

TEAMSTERS LOCAL 2727 BUILDING ADDITION

TEAMSTERS LOCAL 2727
4810 N Preston Hwy
Shepherdsville, KY



Local 2727

DRAWING INDEX

DESIGN TEAM

ARCHITECT

TowerPinkster
Architecture · Engineering · Interiors

MECHANICAL ENGINEER

TowerPinkster
Architecture · Engineering · Interiors

STRUCTURAL ENGINEER

TowerPinkster
Architecture · Engineering · Interiors

ELECTRICAL ENGINEER

TowerPinkster
Architecture · Engineering · Interiors

CIVIL CONSULTANT

**CORNERSTONE
ENGINEERING INC**
Strong team. Smart solutions.

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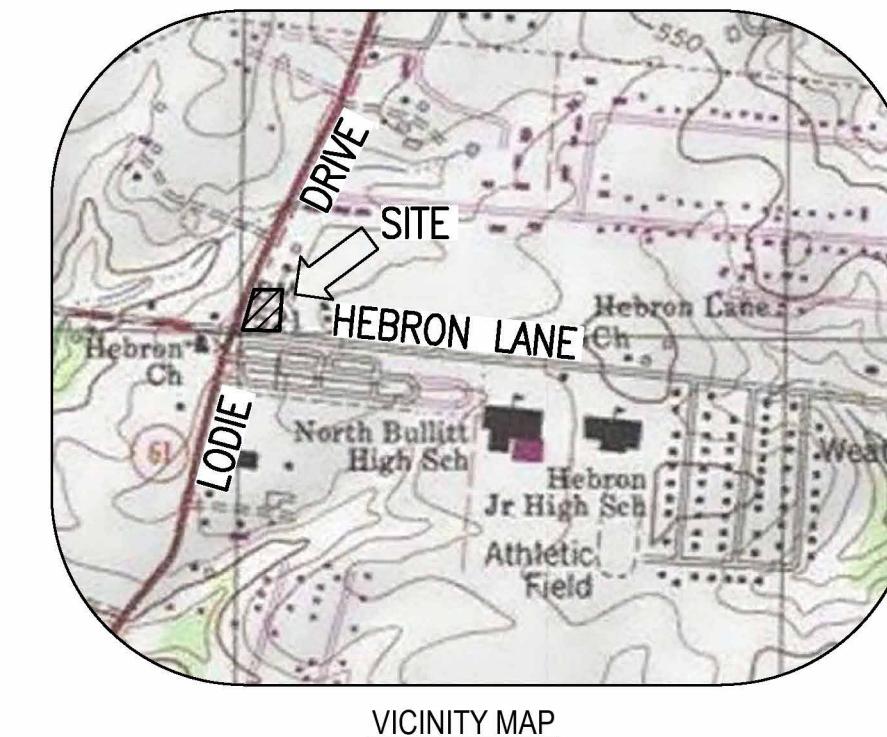
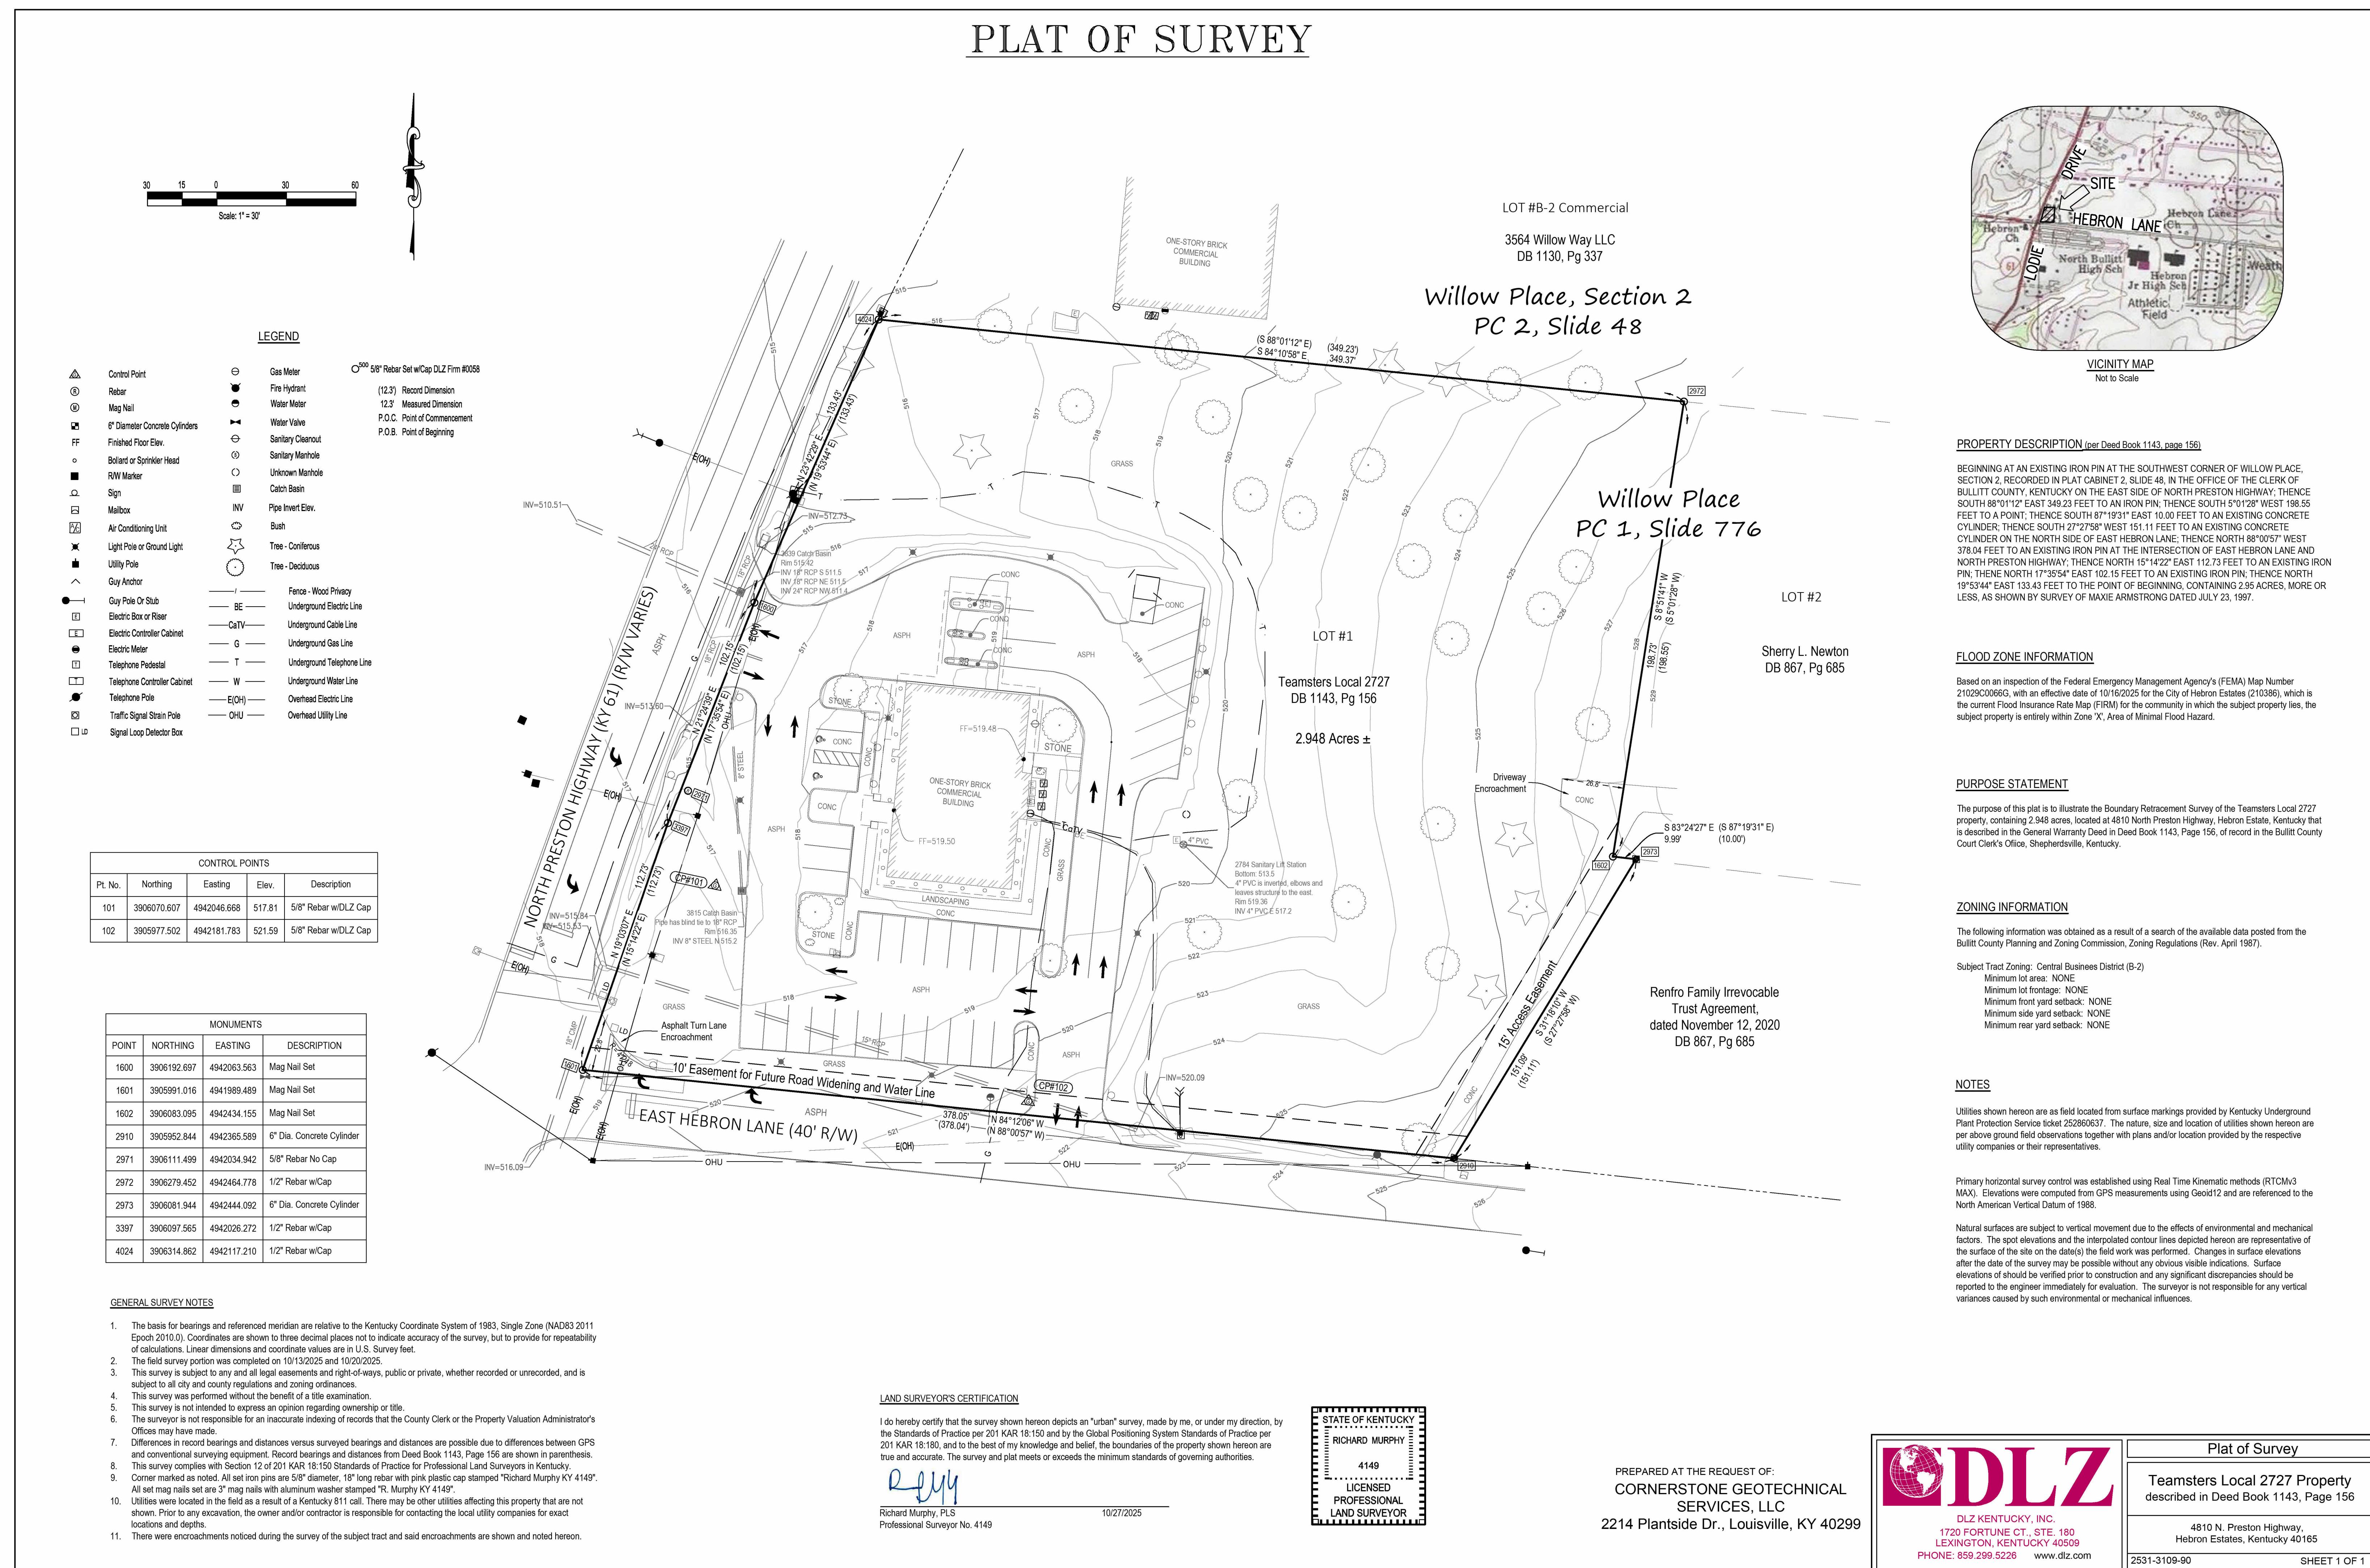
PROJECT TITLE
TEAMSTERS LOCAL 2727
BUILDING ADDITION

OWNER
TEAMSTERS LOCAL 2727
4810 N Preston Hwy
Shepherdsville, KY

DATE
JANUARY 9, 2026

OWNER AND SITE ADDRESS

TEAMSTERS LOCAL 2727
4810 N PRESTON HWY
SHEPHERDSVILLE, KENTUCKY
PHONE: 502.239.0990



PROJECT TITLE
TEAMSTERS LOCAL 2727
BUILDING ADDITION

OWNER
4810 N Preston Hwy
Shepherdsville, KY

DATE
JANUARY 9, 2026

SHEET TITLE
PLAT OF SURVEY


SHEET NUMBER
SP 1
25-376.000

OWNER:
Teamsters Local 2727
4810 N Preston Hwy
Shepherdsville, KY 40165
(502) 239-0990

ENGINEER:
Cornerstone Engineering, Inc.
Michael Bryar, P.E.
2214 Plantside Dr.
Louisville, KY 40299
(502) 491-4824

ARCHITECT:
TowerPinkster
Jim Keller
320 Pearl St, Ste 100
New Albany, IN 47150
(502) 939-8294

TEAMSTERS 2727
CIVIL SITE IMPROVEMENTS
4810 N PRESTON HWY
SHEPHERDSVILLE, KY 40165

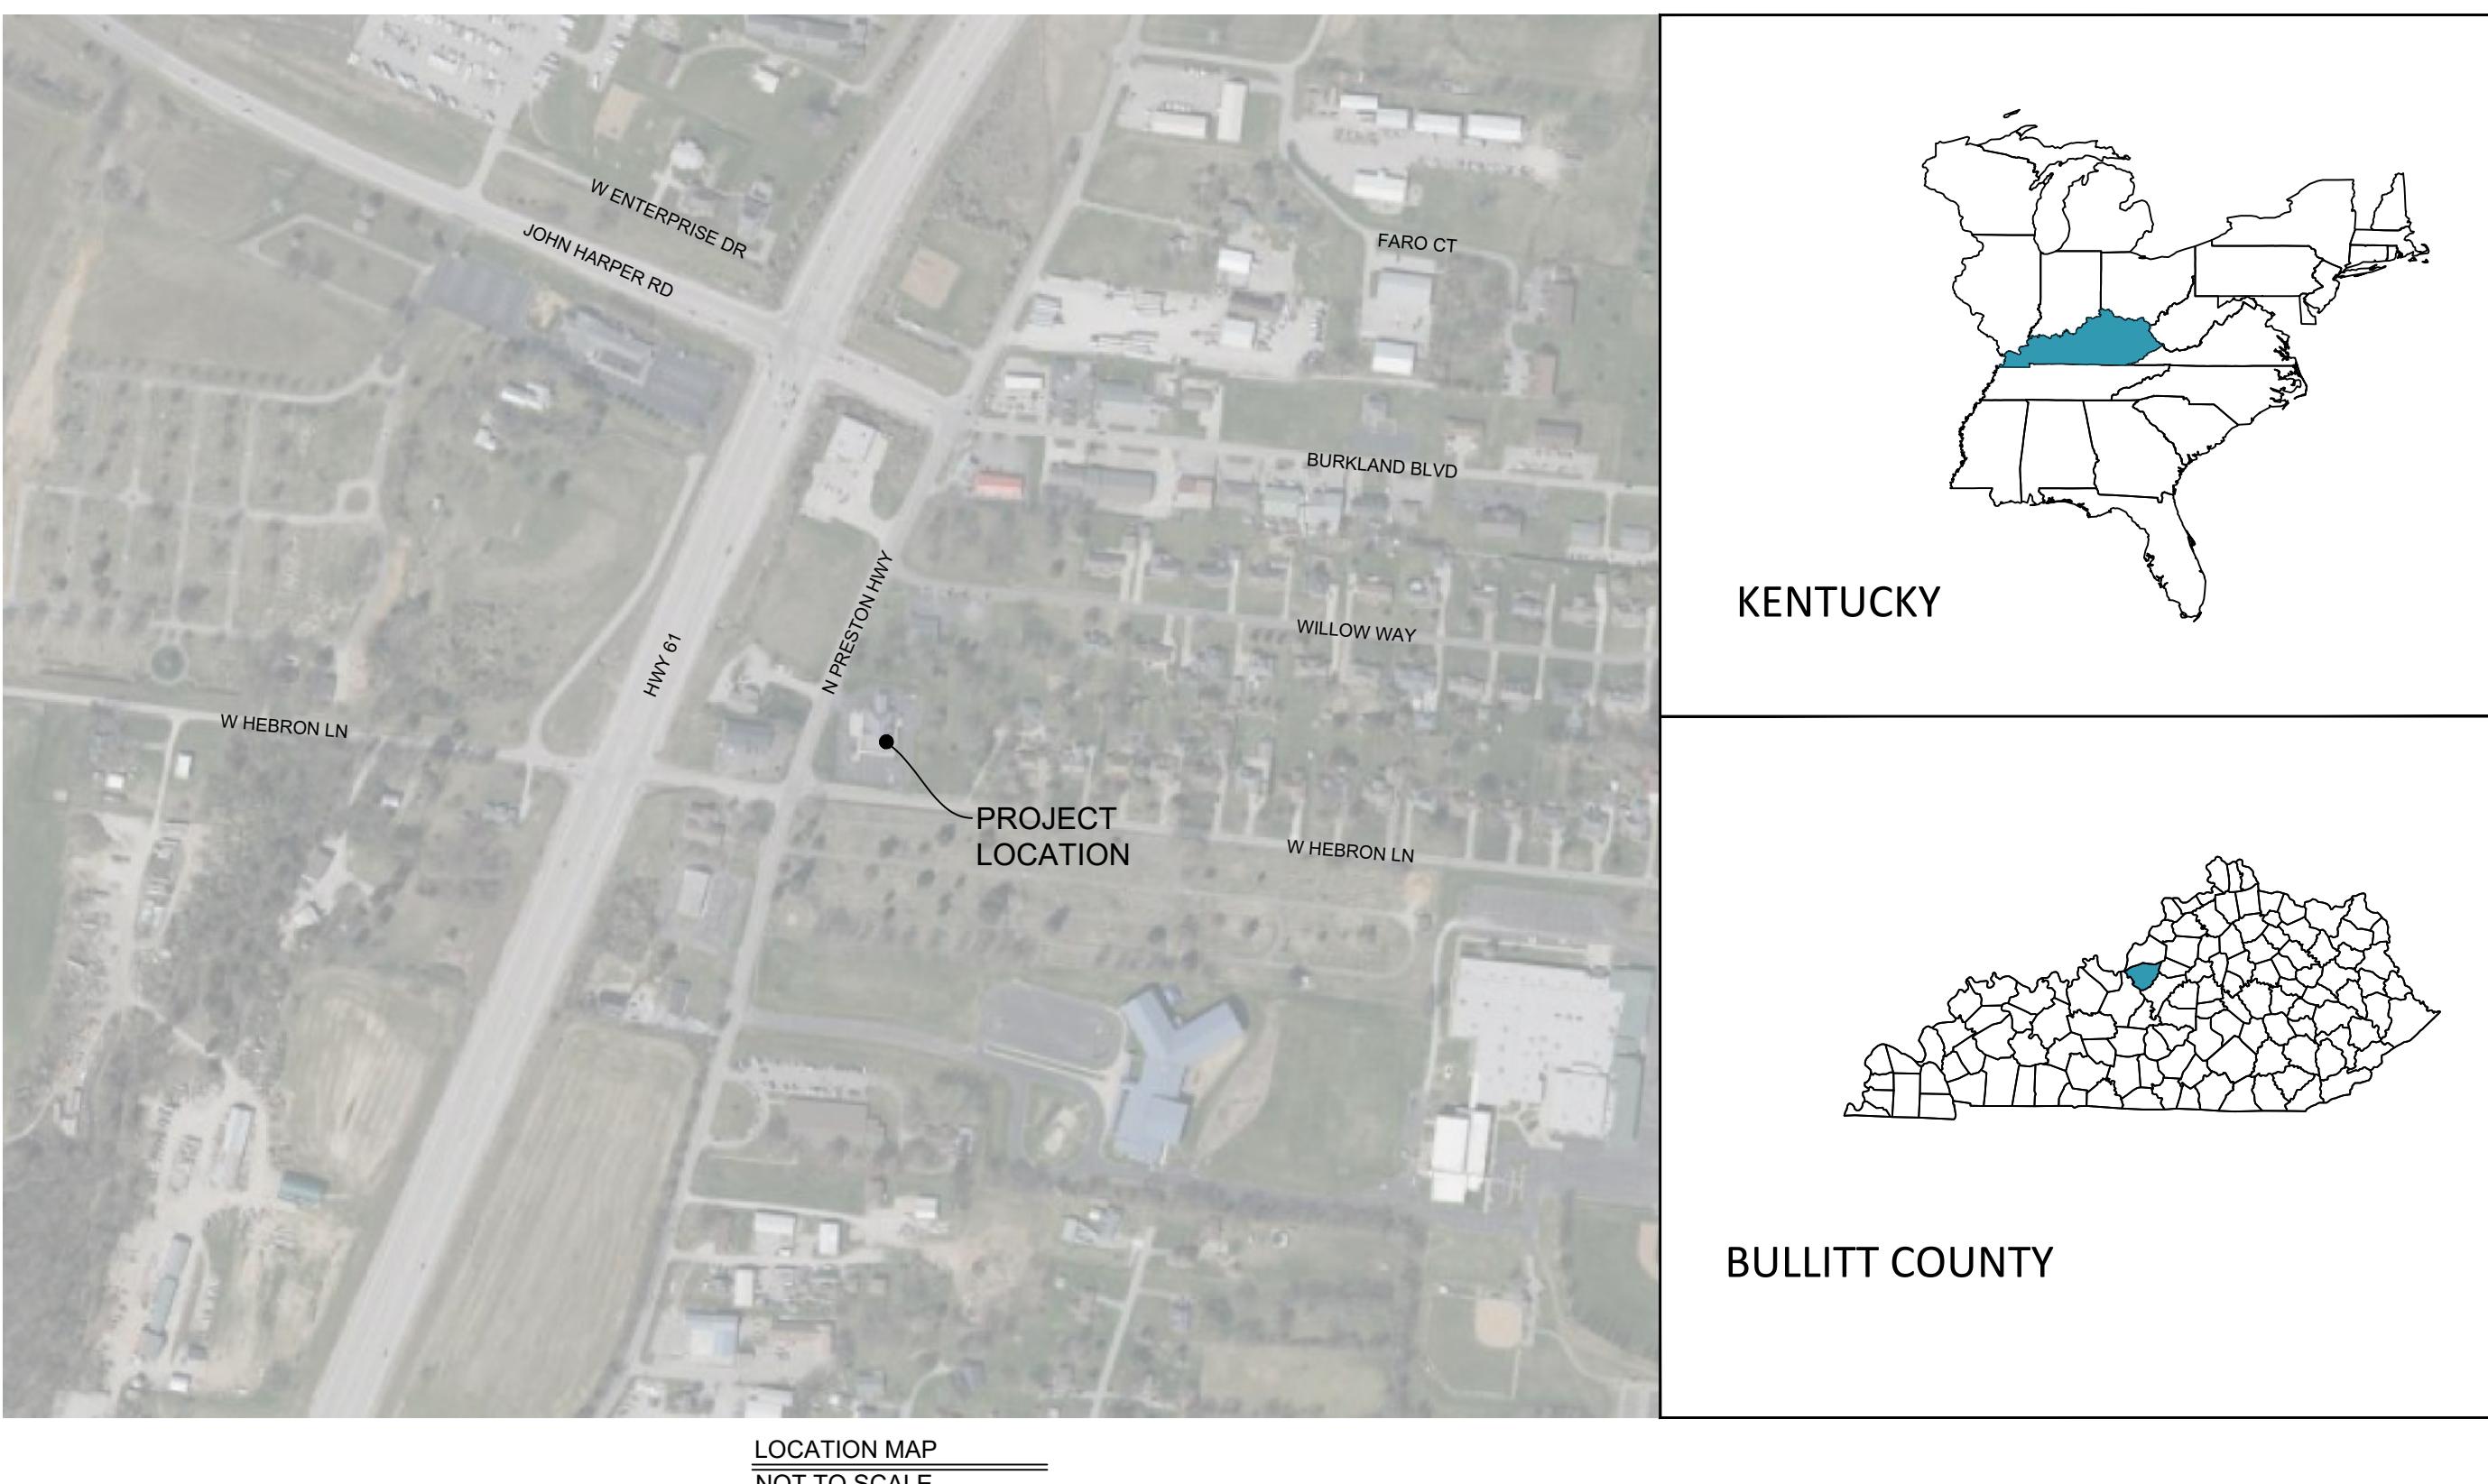

QUANTITIES NOTE:
ANY AND ALL QUANTITY TABLES, NOTES OR VALUES AS SHOWN ON THESE PLANS ARE FOR REFERENCE ONLY. THE PLANS, DETAILS, AND SPECIFICATION GOVERN. IT IS THE RESPONSIBILITY OF THE CONTRACTOR TO REVIEW THE ENTIRE CONSTRUCTION SET AND DETERMINE ALL THE FINAL QUANTITIES FOR ALL NECESSARY ITEMS REQUIRED TO COMPLETE THIS PROJECT. THE OWNER OR THE ENGINEER WILL NOT BE HELD LIABLE OR RESPONSIBLE FOR ESTIMATES NOT CONFIRMED BY THE CONTRACTORS. THE CONTRACTOR SHALL VERIFY ALL QUANTITIES PRIOR TO BIDDING AND CONSTRUCTION. IF DISCREPANCIES ARE FOUND, CONTACT THE ENGINEER IMMEDIATELY.

FLOOD HAZARD STATEMENT:

THE ACCURACY OF THE FLOOD HAZARD INFORMATION SHOWN OR IDENTIFIED HEREON IS SUBJECT TO MAP SCALE UNCERTAINTY AND TO ANY OTHER UNCERTAINTY IN LOCATION OR ELEVATION ON THE REFERENCED FLOOD INSURANCE RATE MAP. THE WITHIN DESCRIBED TRACT OF LAND LIES WITHIN FLOOD HAZARD ZONE X AS SAID TRACT PLOTS BY SCALE ON COMMUNITY PANEL NUMBER 21029C0066G OF THE FLOOD INSURANCE RATE MAPS FOR BULLITT COUNTY, KENTUCKY (PANEL UPDATED 10/16/2025)

NOTE: CAUTION EXISTING UTILITIES

NOTE: CAUTION EXISTING UTILITIES
THE INFORMATION SHOWN ON THESE DRAWINGS CONCERNING TYPE AND
LOCATION OF UNDERGROUND UTILITIES IS NOT GUARANTEED TO BE ACCURATE OR
ALL-INCLUSIVE. LOCATION, SIZE, AND MATERIAL SHOWN ON UTILITIES ARE FROM
AVAILABLE RECORDS SUPPLIED BY THE RESPECTIVE UTILITY COMPANY. KENTUCKY
811-BEFORE YOU DIG (BUD) MUST BE NOTIFIED 2 BUSINESS DAYS PRIOR TO ANY
EXCAVATION FOR VERIFICATION OF LOCATION, SIZE, AND MATERIAL.
DIAL 811 OR 1-800-752-6007.


UTILITY CONTACT INFORMATION:		
<u>SANITARY:</u> ON SITE SEPTIC	<u>ELECTRIC:</u> LOUISVILLE GAS & ELECTRIC 220 W MAIN ST LOUISVILLE, KY 40222	<u>WATER:</u> LOUISVILLE WATER COMPANY 550 S 3RD ST LOUISVILLE, KY 40222



Know what's below.
Call before you dig.




DATE:	
COVER SHEET	<p>TEAMSTER 2727 CIVIL SITE IMPROVEMENTS 4180 N PRESTON HWY SHEPHERDVILLE, KY</p>

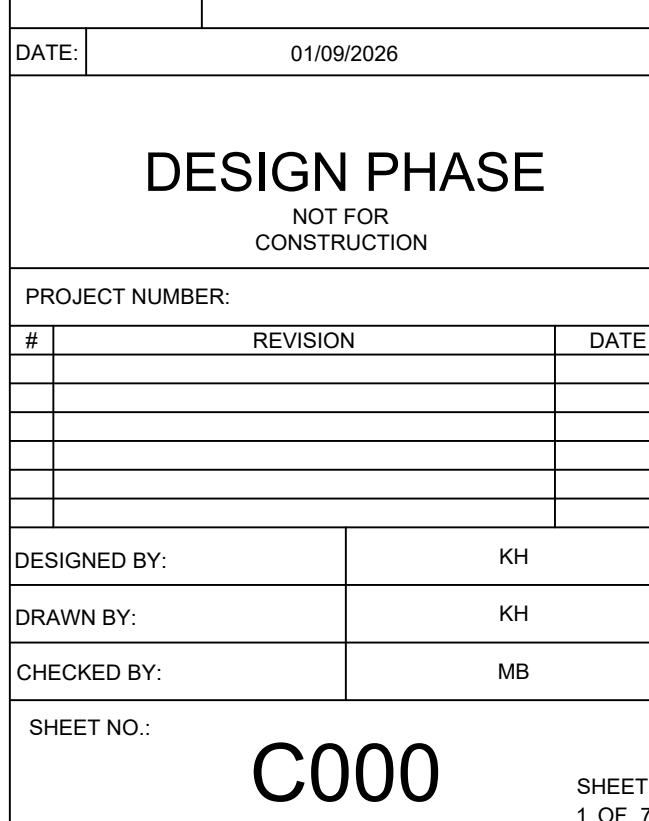

GENERAL NOTES
TEAMSTER 2727
CIVIL SITE IMPROVEMENTS
4180 N PRESTON HWY
SHEPHERDSVILLE, KY

National Flood Hazard Layer FIRMette

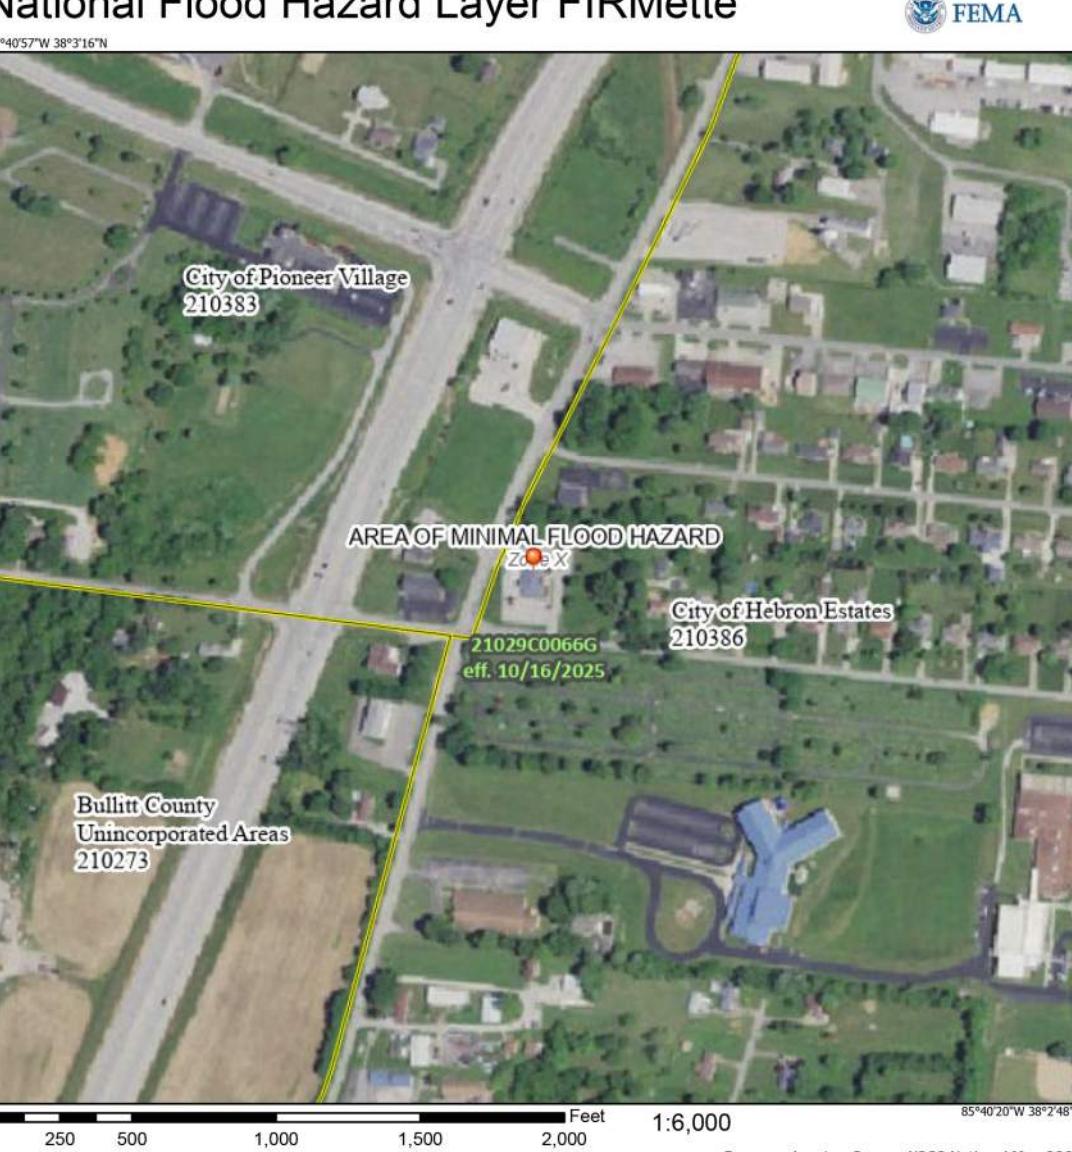

Legend

SEE FIG REPORT FOR DETAILED LEGEND AND INDEX MAP FOR FIRM PANEL LAYOUT

SPECIAL FLOOD HAZARD AREAS

- Without Flood Elevation (FFE)
- With Flood Elevation (FFE)
- Regulatory Floodway
- 0.25% Annual Chance Flood Hazard, Areas of 1% annual chance flood with average depth less than one foot or with drainage times greater than 10 years
- 0.5% Annual Chance Flood Hazard, Areas of 1% annual chance flood with average depth less than one foot or with drainage times greater than 10 years
- Future Conditions 1% Annual
- Area with Reduced Flood Risk due to Levee/SD
- Area with Flood Risk due to Levee/SD

OTHER AREA OF FLOOD HAZARD

- NO FLOOD
- Effective Limits
- Area of Undetermined Flood Hazard Zone D

GENERAL STRUCTURES

- Channel, Culvert, or Storm Sewer
- Levee, Dike, or Floodwall

OTHER FEATURES

- 20.3 Cross Sections with 1% Annual Chance Flood Hazard
- Water Surface Elevation
- Base Flood Elevation Line (BFE)
- Junction Boundary
- Coastal Transient Baseline
- Hydrographic Feature

MAP PANELS

- Digital Data Available
- No Digital Data Available
- Unmapped

The map displayed on the map is an unmap point selected by the user and does not represent the entire map area.

This map complies with FEMA standards for the use of digital flood maps. It is a map of the area shown. The basemap shown complies with FEMA's basemap standards.


The flood hazard information is derived directly from the authoritative NFIP web services provided by FEMA. This map was generated on 10/16/2025. It is subject to change. It does not reflect changes or amendments subsequent to this date and this map is not to be used for regulatory purposes until it has become superseded by new data over the map.

This map image is valid for one or more of the following map areas: 1.00% chance of flooding in 50 years. Flood zone labels, legend, scale bar, map creation date, community identifiers, FIRM panel, and map panel are valid for this map. It is not valid for unmapped and unmonitored areas cannot be used for regulatory purposes.

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DATE:



DATE: 01/09/2026

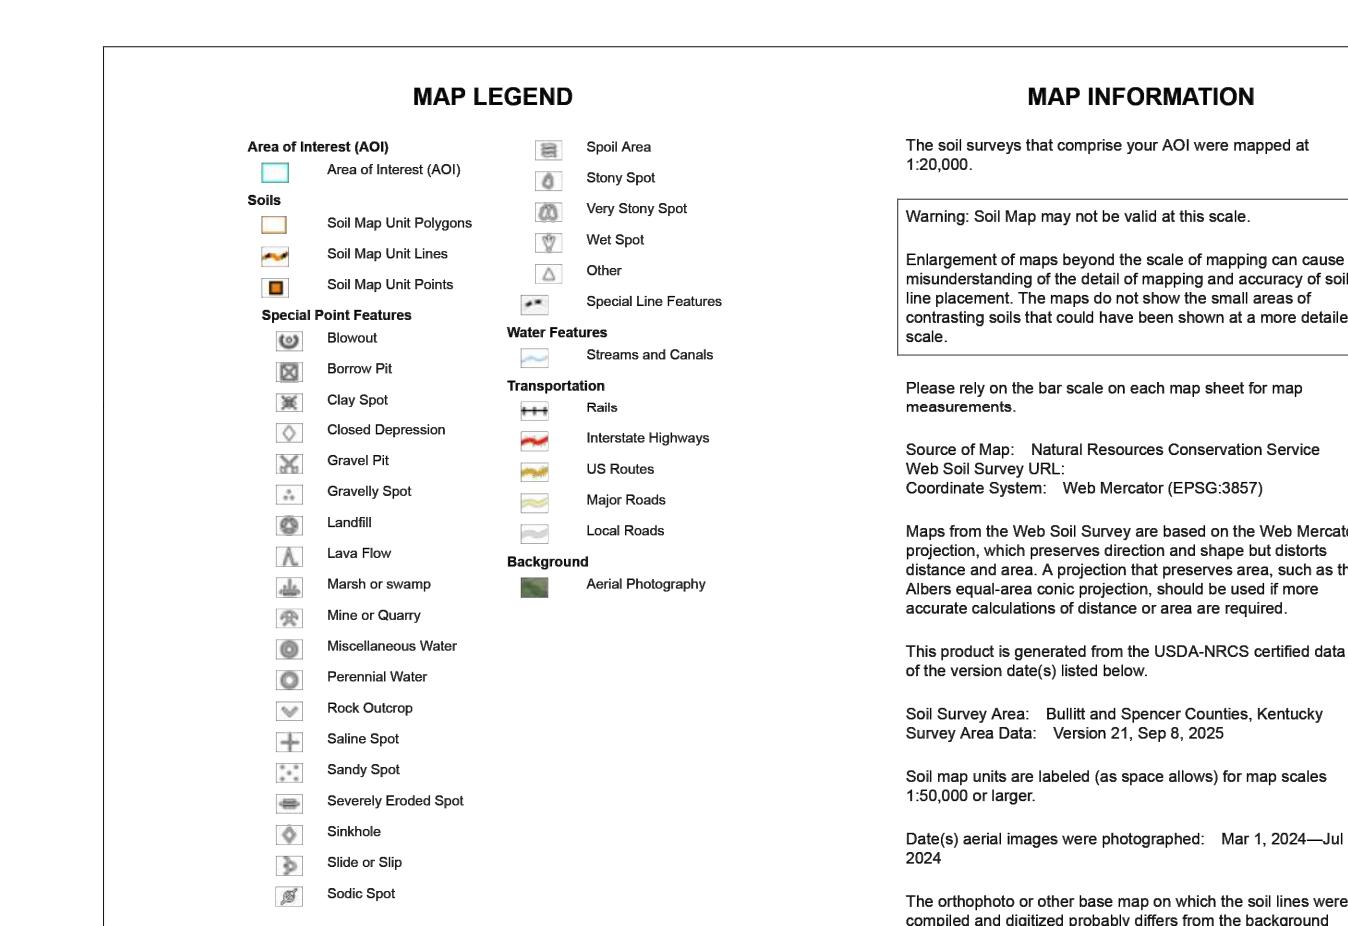DESIGN PHASE
NOT FOR
CONSTRUCTION

PROJECT NUMBER:

#	REVISION	DATE

DESIGNED BY: KH

DRAWN BY: KH

CHECKED BY: MB

SHEET NO.: C001

SHEET 2 OF 7


OVERALL PROJECT GENERAL NOTES

- CONTRACTOR SHALL PERFORM ALL MAINTENANCE OF TRAFFIC IN ACCORDANCE WITH STATE AND LOCAL STANDARDS AND THE MANUAL OF UNIFORM TRAFFIC CONTROL DEVICES.
- CONTRACTOR SHALL COMPLY WITH ANY AND ALL SAFETY REGULATIONS AND REQUIREMENTS RELATED TO THE PROTECTION OF HUMAN SAFETY PROVIDED BY THE STATE, THE CITY, THE COUNTY, THE APPLICABLE STATE AND LOCAL REGULATIONS OF THE STATE, NATIONAL SAFETY AND HEALTH ADMINISTRATION, OSHA AND THE OTHER LOCAL, STATE OR FEDERAL AGENCY HAVING JURISDICTION. THE CONTRACTOR SHALL BE SOLELY AND COMPLETELY RESPONSIBLE FOR CONDITIONS OF THE JOB SITE, INCLUDING SAFETY OF ALL PERSONS AND PROPERTY DURING PERFORMANCE OF THE WORK. THE OPTION OF THE OWNER AND/OR ENGINEER TO CONDUCT CONSTRUCTION INSPECTION OF THE CONTRACTOR'S PERFORMANCE DOES NOT INCLUDE A REVIEW OF CONTRACTOR'S IMPLEMENTED SAFETY MEASURES.
- CONTRACTOR SHALL BE RESPONSIBLE FOR PROVIDING AND MAINTAINING ALL BARRICADES, FENCES, WARNING SIGNS, FLASHING LIGHTS, TEMPORARY WALKWAYS AND OTHER SAFETY MEASURES DURING CONSTRUCTION.
- CONTRACTOR SHALL BE RESPONSIBLE FOR ALL FEES AND PERMITS REQUIRED FOR WORK.
- PLANS AND SPECIFICATIONS REQUIREMENT ARCHITECT, ENGINEER AND LANDSCAPE ARCHITECT INTERCHANGEABLY THROUGHOUT.
- NO CHANGES SHALL BE MADE TO THE PLANS WITHOUT PRIOR NOTICE AND WRITTEN APPROVAL OF ENGINEER.
- CONTACT ENGINEER OF RECORD IF ANY DEVIATIONS OF THE EXISTING CONDITIONS FROM THOSE SHOWN ON THE PLANS MAY AFFECT THE IMPROVEMENTS BEFORE CONSTRUCTION PROCEEDS AT THAT LOCATION.
- CONTRACTOR SHALL BE RESPONSIBLE FOR PROTECTING EXISTING SURVEY MONUMENTS AND BENCHMARKS. ANY OBJECT DISTURBED OR DESTROYED DURING CONSTRUCTION ACTIVITY SHALL BE REPLACED VERIFIED BY A LICENSED SURVEYOR IN THE STATE THAT THE WORK OCCURS IN.
- EXCAVATION AND DISPOSAL OF MATERIAL SHALL BE DONE IN ACCORDANCE WITH ALL FEDERAL, STATE, AND LOCAL LAWS, CODES, AND ENVIRONMENTAL REGULATIONS. CONTRACTOR SHALL CEASE EXCAVATION ACTIVITIES AND NOTIFY THE OWNER AND ARCHITECT IMMEDIATELY IF CONTAMINATED SOIL OR OTHER ENVIRONMENTAL HAZARD IS ENCOUNTERED.
- CONTRACTOR SHALL REPAIR OR REPLACE ANY EXISTING SITE AREAS OR IMPROVEMENTS DAMAGED DURING CONSTRUCTION TO AT LEAST THE CONDITION THAT EXISTED BEFORE CONSTRUCTION.

UTILITY GENERAL NOTES

DEMOLITION NOTES

SITE IMPROVEMENT NOTES

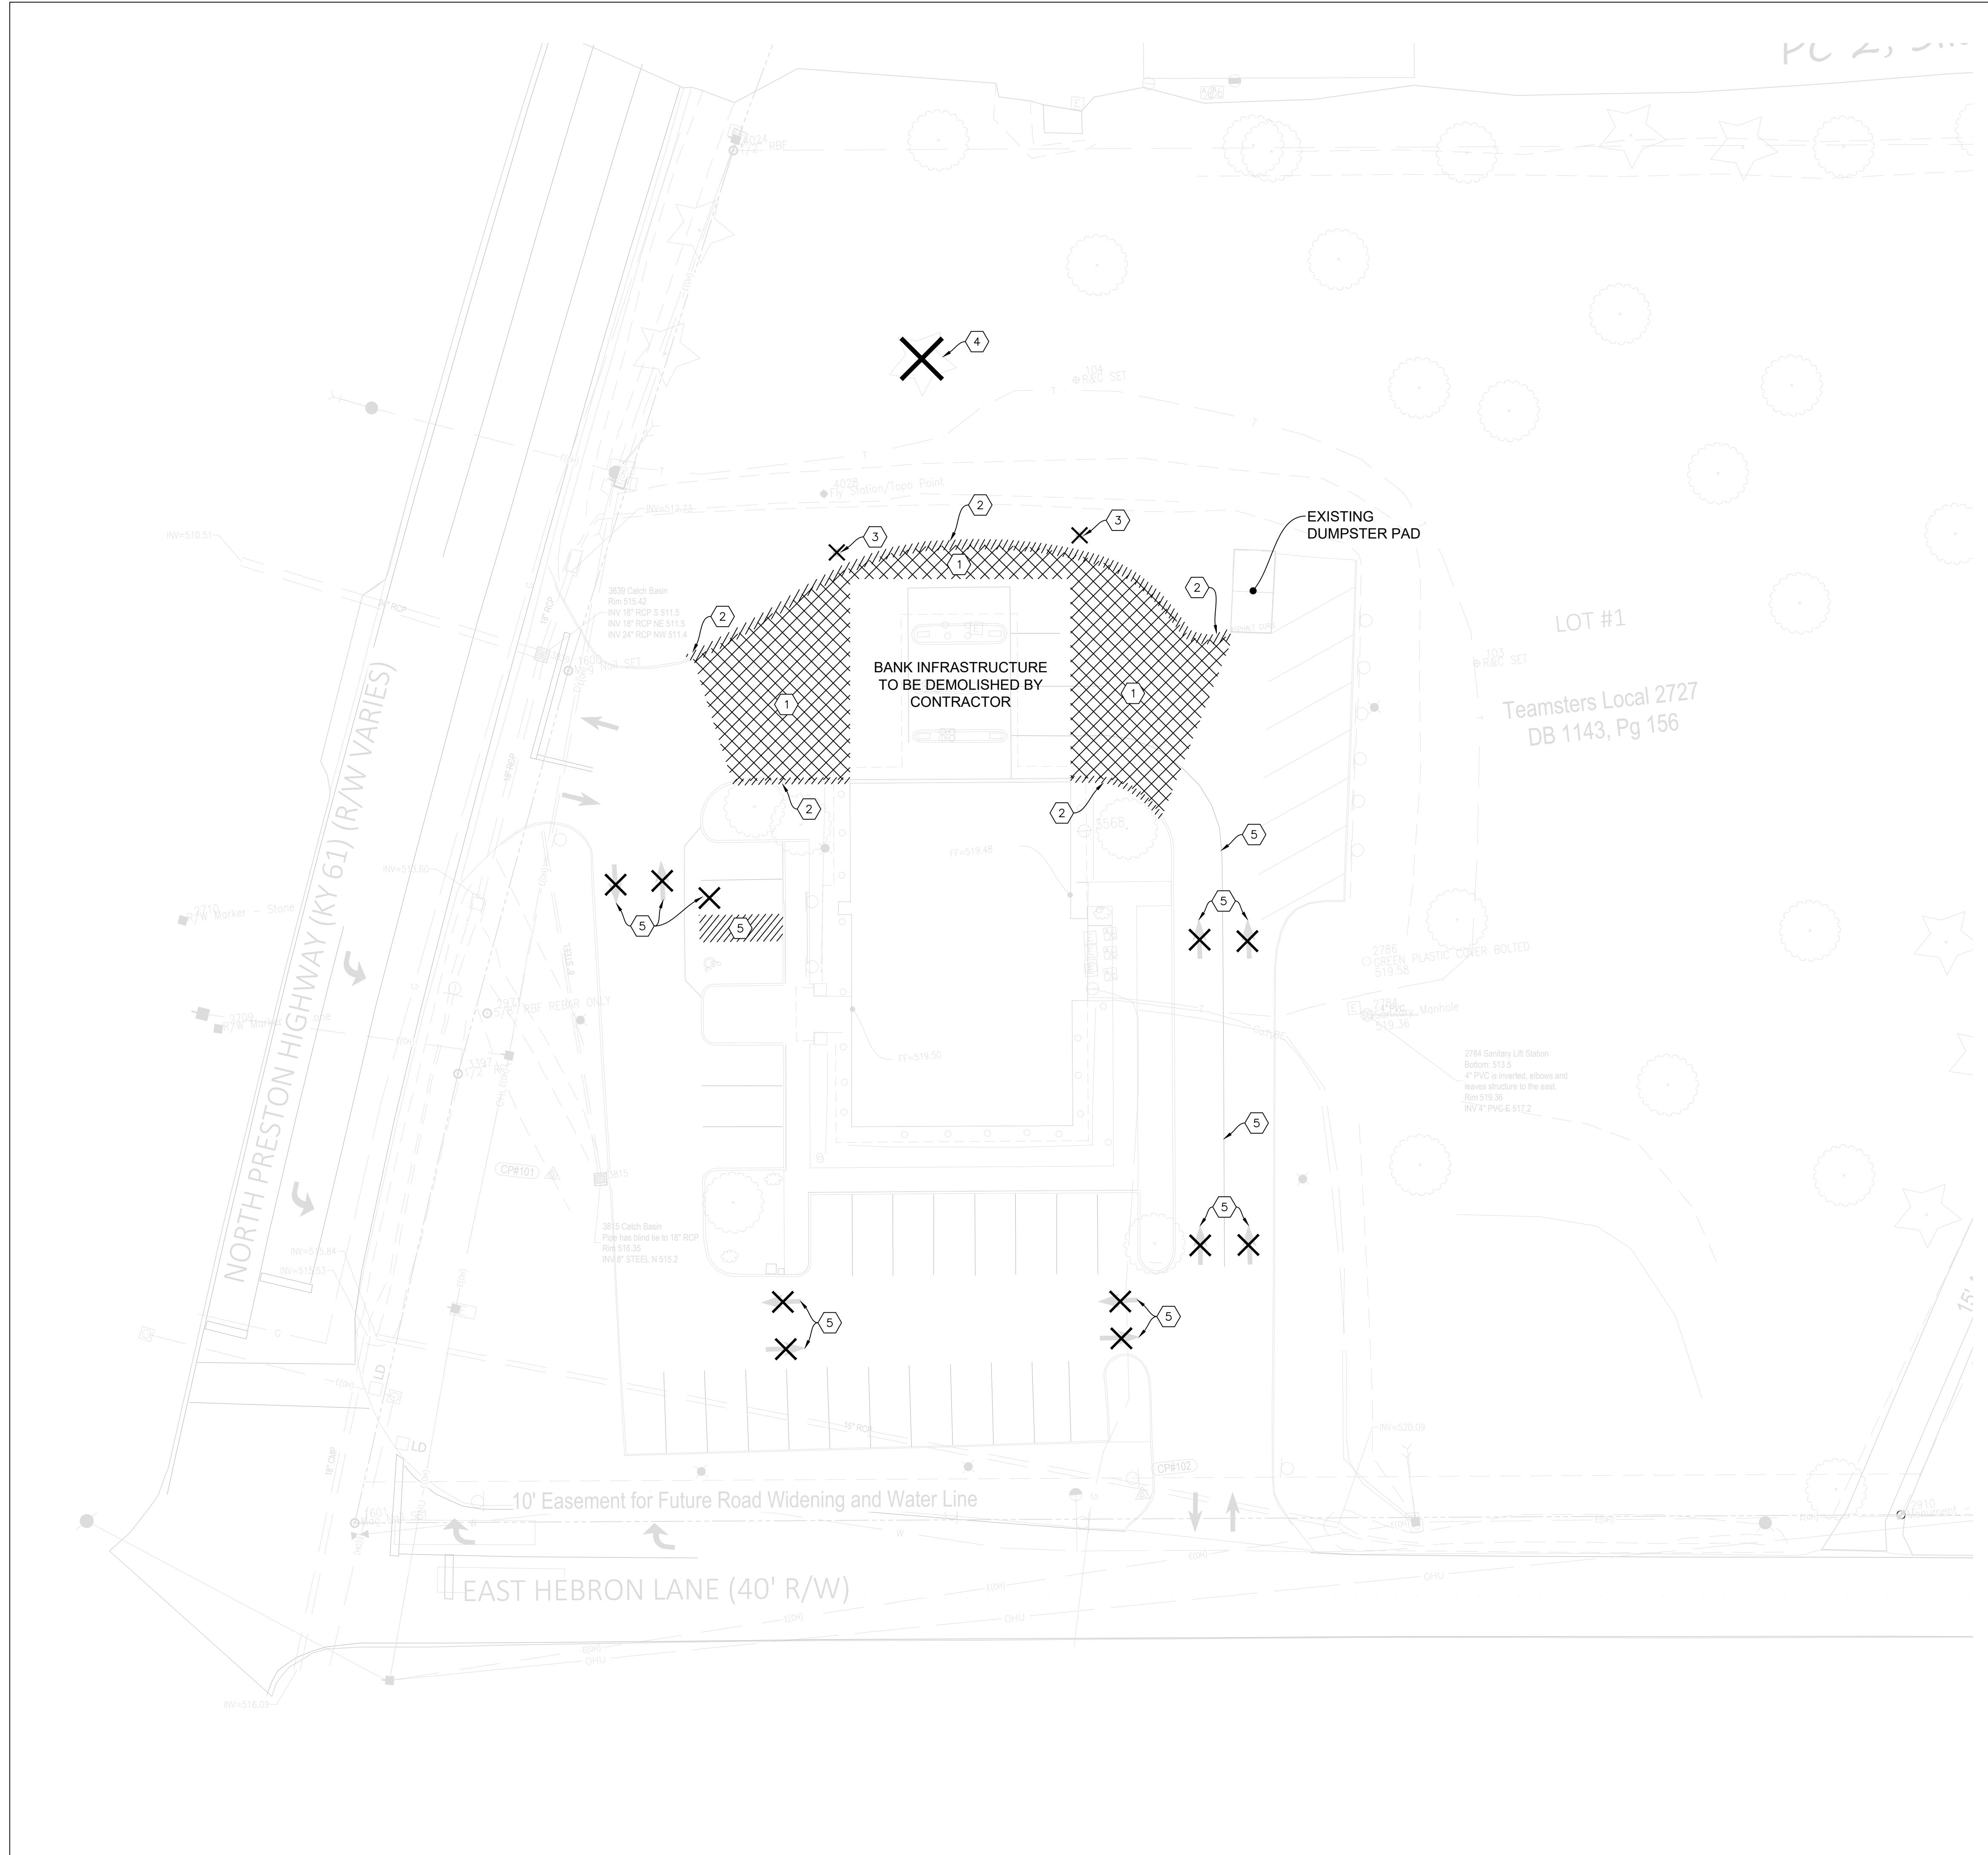

GENERAL SURVEY NOTES

- THE BASIS FOR BEARINGS AND REFERENCED MERIDIAN ARE RELATIVE TO THE KENTUCKY COORDINATE SYSTEM OF 1983, SINGLE ZONE (NAD83 2011 EPOCH 2010). COORDINATES ARE SHOWN TO THREE DECIMAL PLACES NOT TO INDICATE ACCURACY OF THE SURVEY, BUT TO PROVIDE FOR REPEATABILITY OF CALCULATIONS. LINEAR DIMENSIONS AND COORDINATE VALUES ARE IN U.S. SURVEY FEET.
- THE FIELD SURVEY PORTION WAS COMPLETED ON 10/13/2025 AND 10/20/2025.
- THIS SURVEY IS SUBJECT TO ANY AND ALL LEGAL EASEMENTS AND RIGHT-OF-WAYS, PUBLIC OR PRIVATE, WHETHER RECORDED OR UNRECORDED, AND IS SUBJECT TO ALL CITY AND COUNTY REGULATIONS AND ZONING ORDINANCES.
- THIS SURVEY WAS PERFORMED WITHOUT THE BENEFIT OF A TITLE EXAMINATION.
- THIS SURVEY IS NOT INTENDED TO EXPRESS AN OPINION REGARDING OWNERSHIP OR TITLE.
- THE SURVEYOR IS NOT RESPONSIBLE FOR AN INACCURATE INDEXING OF RECORDS THAT THE COUNTY CLERK OR THE PROPERTY VALUATION ADMINISTRATOR'S OFFICES MAY HAVE MADE.
- DIFFERENCES IN RECORD BEARINGS AND DISTANCES VERSUS SURVEYED BEARINGS AND DISTANCES ARE POSSIBLE DUE TO DIFFERENCES BETWEEN GPS AND CONVENTIONAL SURVEYING EQUIPMENT. RECORD BEARINGS AND DISTANCES FROM DEED BOOK 1143, PAGE 156 ARE SHOWN IN PARENTHESIS.
- THIS SURVEY COMPLIES WITH SECTION 12 OF 201 KAR 18:150 STANDARDS OF PRACTICE FOR PROFESSIONAL LAND SURVEYORS IN KENTUCKY.
- CORNER MARKED AS NOTED. ALL SET IRON PINS ARE 5/8" DIAMETER, 18" LONG REBAR WITH PINK PLASTIC CAP STAMPED "RICHARD MURPHY KY 4149". ALL SET MAG NAILS SET ARE 3" MAG NAILS WITH ALUMINUM WASHER STAMPED "R. MURPHY KY 4149".
- UTILITIES WERE LOCATED IN THE FIELD AS A RESULT OF A KENTUCKY 811 CALL. THERE MAY BE OTHER UTILITIES AFFECTING THIS PROPERTY THAT ARE NOT PRIOR TO ANY EXCAVATION, THE OWNER AND/OR CONTRACTOR IS RESPONSIBLE FOR CONTACTING THE LOCAL UTILITY COMPANIES FOR EXACT LOCATIONS AND DEPTHS.
- THERE WERE ENCROACHMENTS NOTICED DURING THE SURVEY OF THE SUBJECT TRACT AND SAID ENCROACHMENTS ARE SHOWN AND NOTED HEREON.

SURVEY NOTES:

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CONTROL POINT 101:
NORTHING: 3900070.607
EASTING: 4942046.668
ELEVATION: 517.81
REBAR AND CAP SET IN GRASS 73.3' FEET NORTHEASTERLY FROM SOUTHWEST CORNER OF THE PROPERTY, 33.8' SOUTHEASTERLY FROM A REBAR PROPERTY CORNER ON THE WEST SIDE OF PRESTON HIGHWAY, AND 11.7' WEST FROM THE CENTER OF A CATCH BASIN.

CONTROL POINT 102:
NORTHING: 3905977.502
EASTING: 4942181.783
ELEVATION: 521.59
REBAR AND CAP SET IN THE GRASS, APPROXIMATELY 2' BEHIND CONCRETE CURB ON THE WEST SIDE OF THE ENTRANCE FROM HEBRON ROAD, 4.7' FROM THE ENTRANCE SIGN.

PLAN KEYNOTES

- DEMOLISH EXISTING ASPHALT PAVEMENT
- SAWCUT AND REMOVE EXISTING CURB
- REMOVE EXISTING LIGHT POLE AND CAP ELECTRIC LINE
- REMOVE EXISTING TREE AND STUMP
- REMOVE EXISTING STRIPING

EXISTING CONDITIONS & DEMOLITION
TEAMSTERS 2727
CIVIL SITE IMPROVEMENTS
4810 N PRESTON HWY
SHEPHERDSVILLE, KY 40165

DATE: 01/09/2026

DESIGN PHASE NOT FOR CONSTRUCTION

PROJECT NUMBER:	REVISION	DATE

DESIGNED BY: KH
DRAWN BY: KH
CHECKED BY: MB

SHEET NO.: C100


SCALE: 1" = 20' Feet

0 20 40

LINEAR DEMOLITION

AREA DEMOLITION



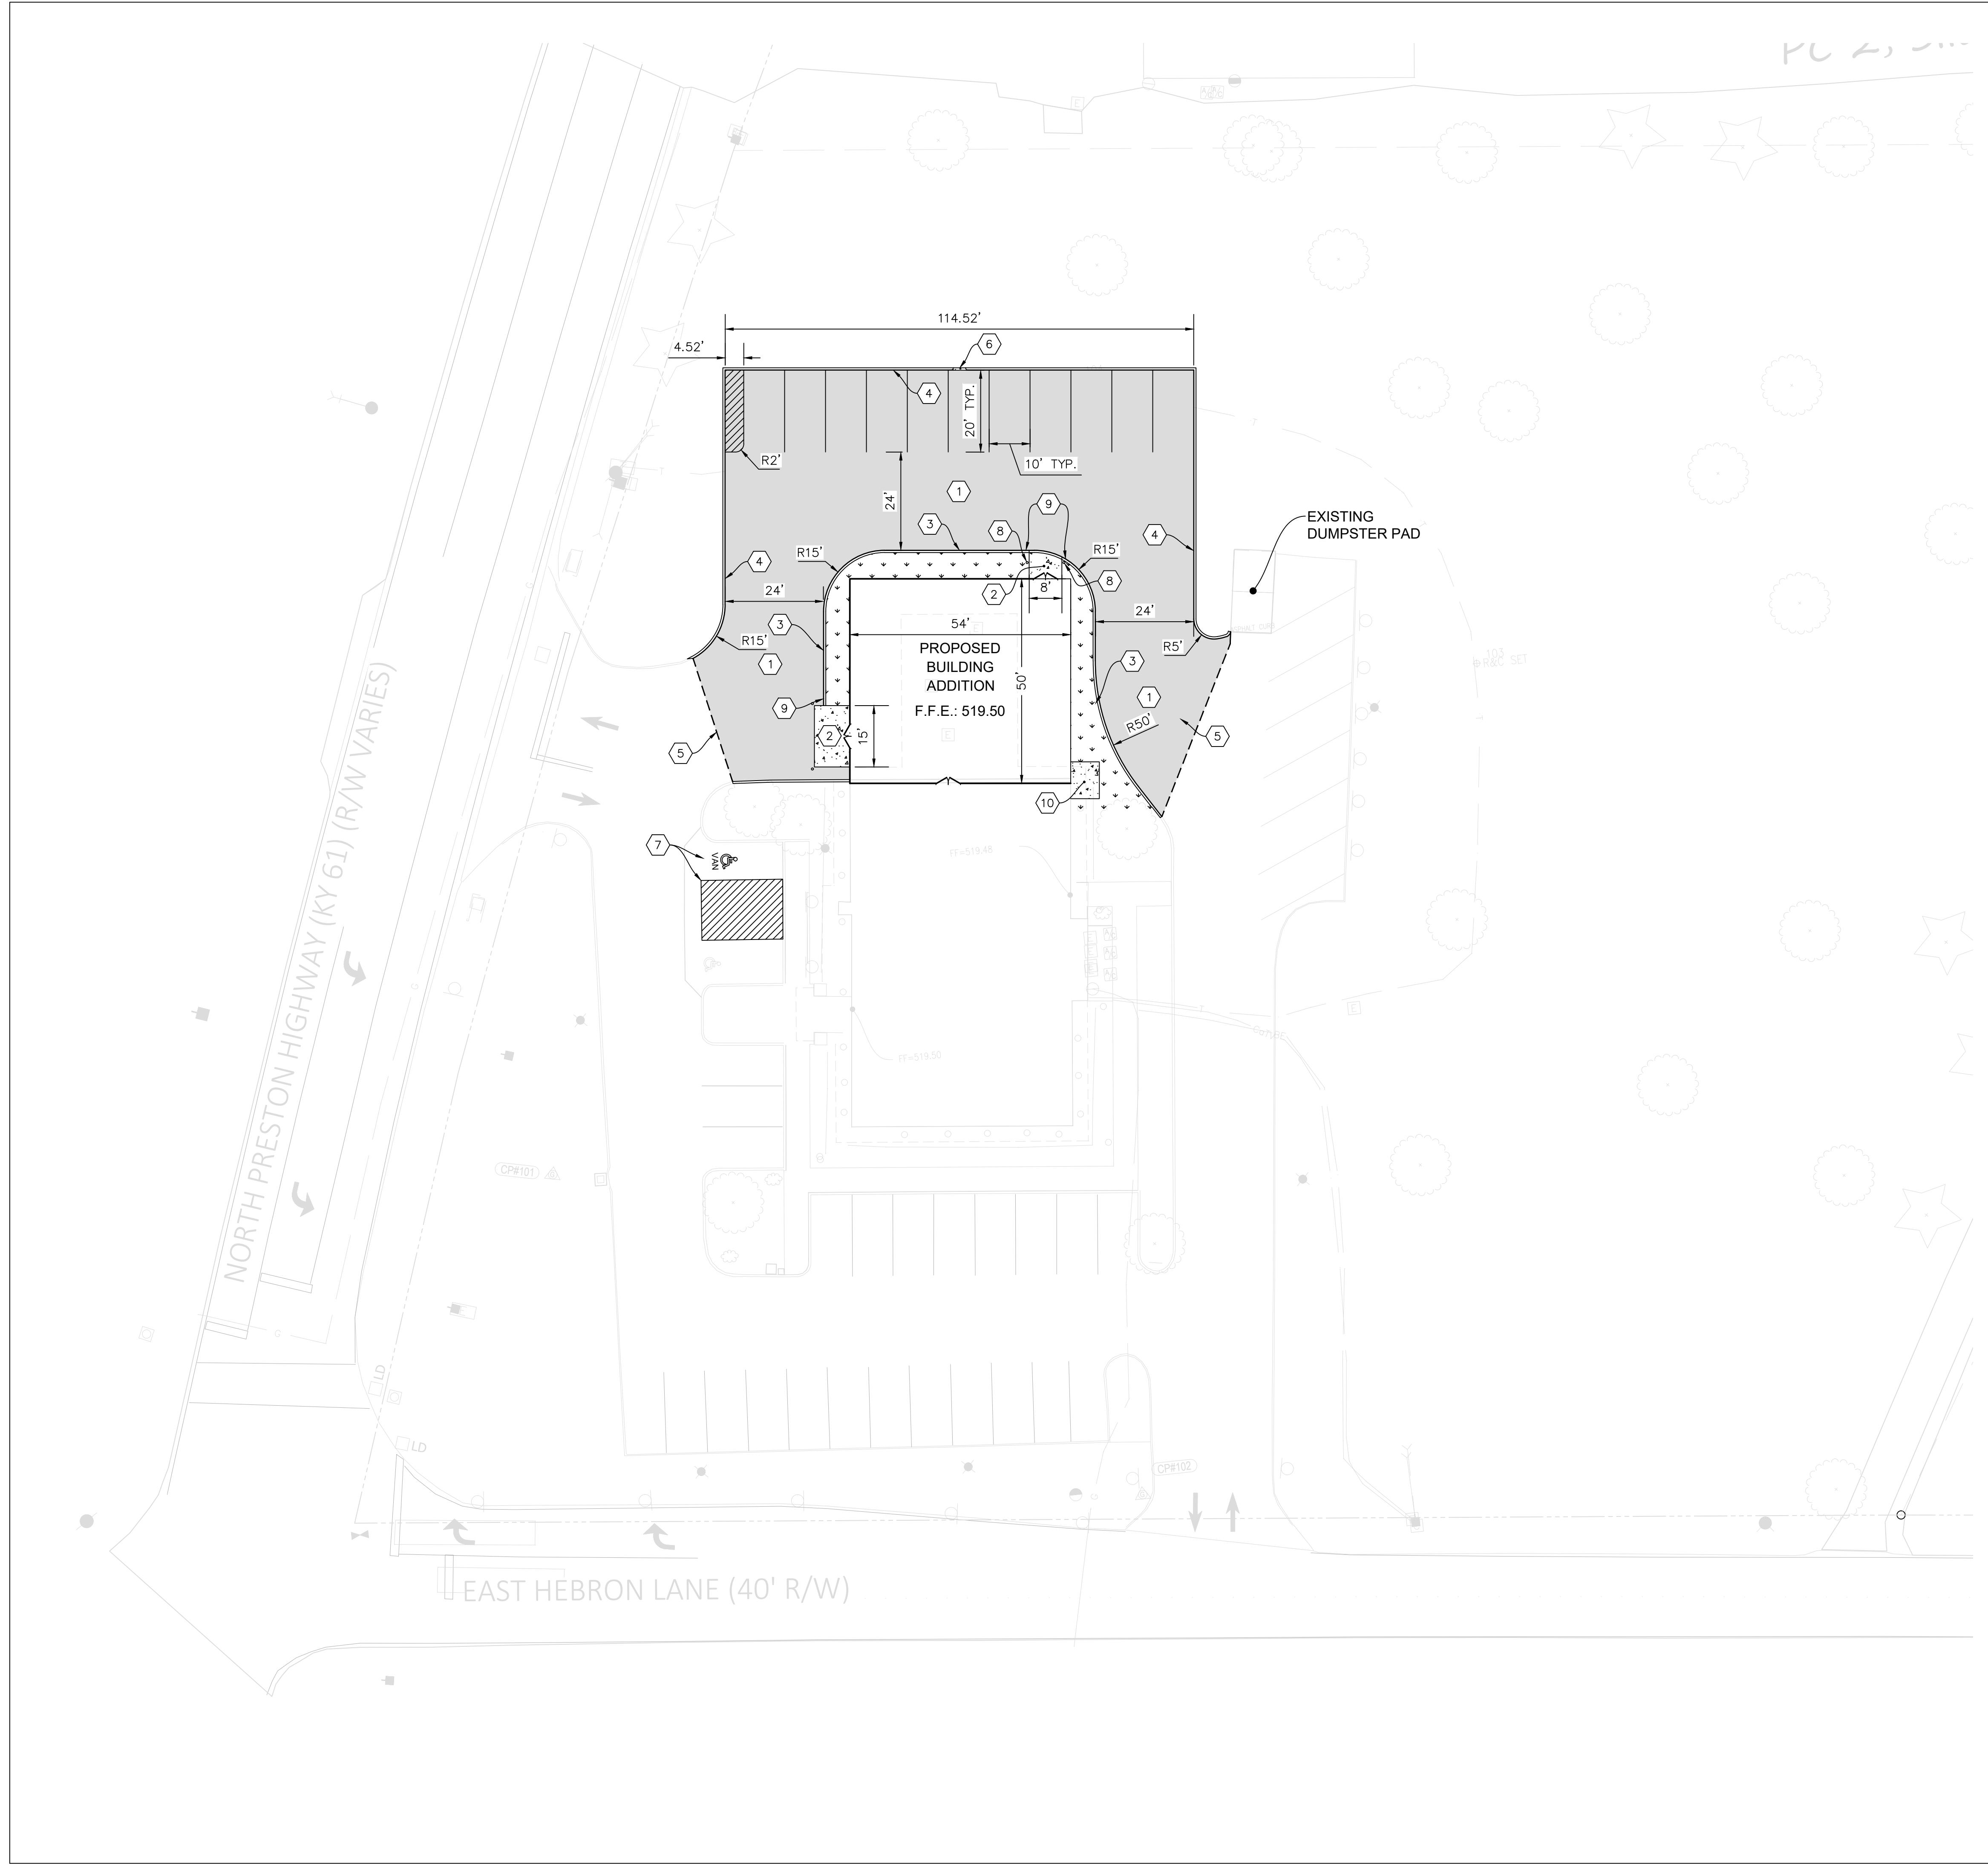

CORNERSTONE ENGINEERING INC
Strong team. Smart solutions.
502-493-2717 cei-engineering.com

SITE LAYOUT

TEAMSTERS 2727
CIVIL SITE IMPROVEMENTS
4810 N PRESTON HWY
SHEPHERDSVILLE, KY 40165

DATE: 01/09/2026

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NOT FOR CONSTRUCTION

PROJECT NUMBER:	REVISION	DATE

DESIGNED BY: KH
DRAWN BY: KH
CHECKED BY: MB
SHEET NO.: C200
SCALE: 1" = 20' Feet


SHEET 4 OF 7

CEI

STATE OF KENTUCKY
MICHAEL R. BRYAR
36119
LICENSED PROFESSIONAL ENGINEER

DATE:

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SITE DATA:

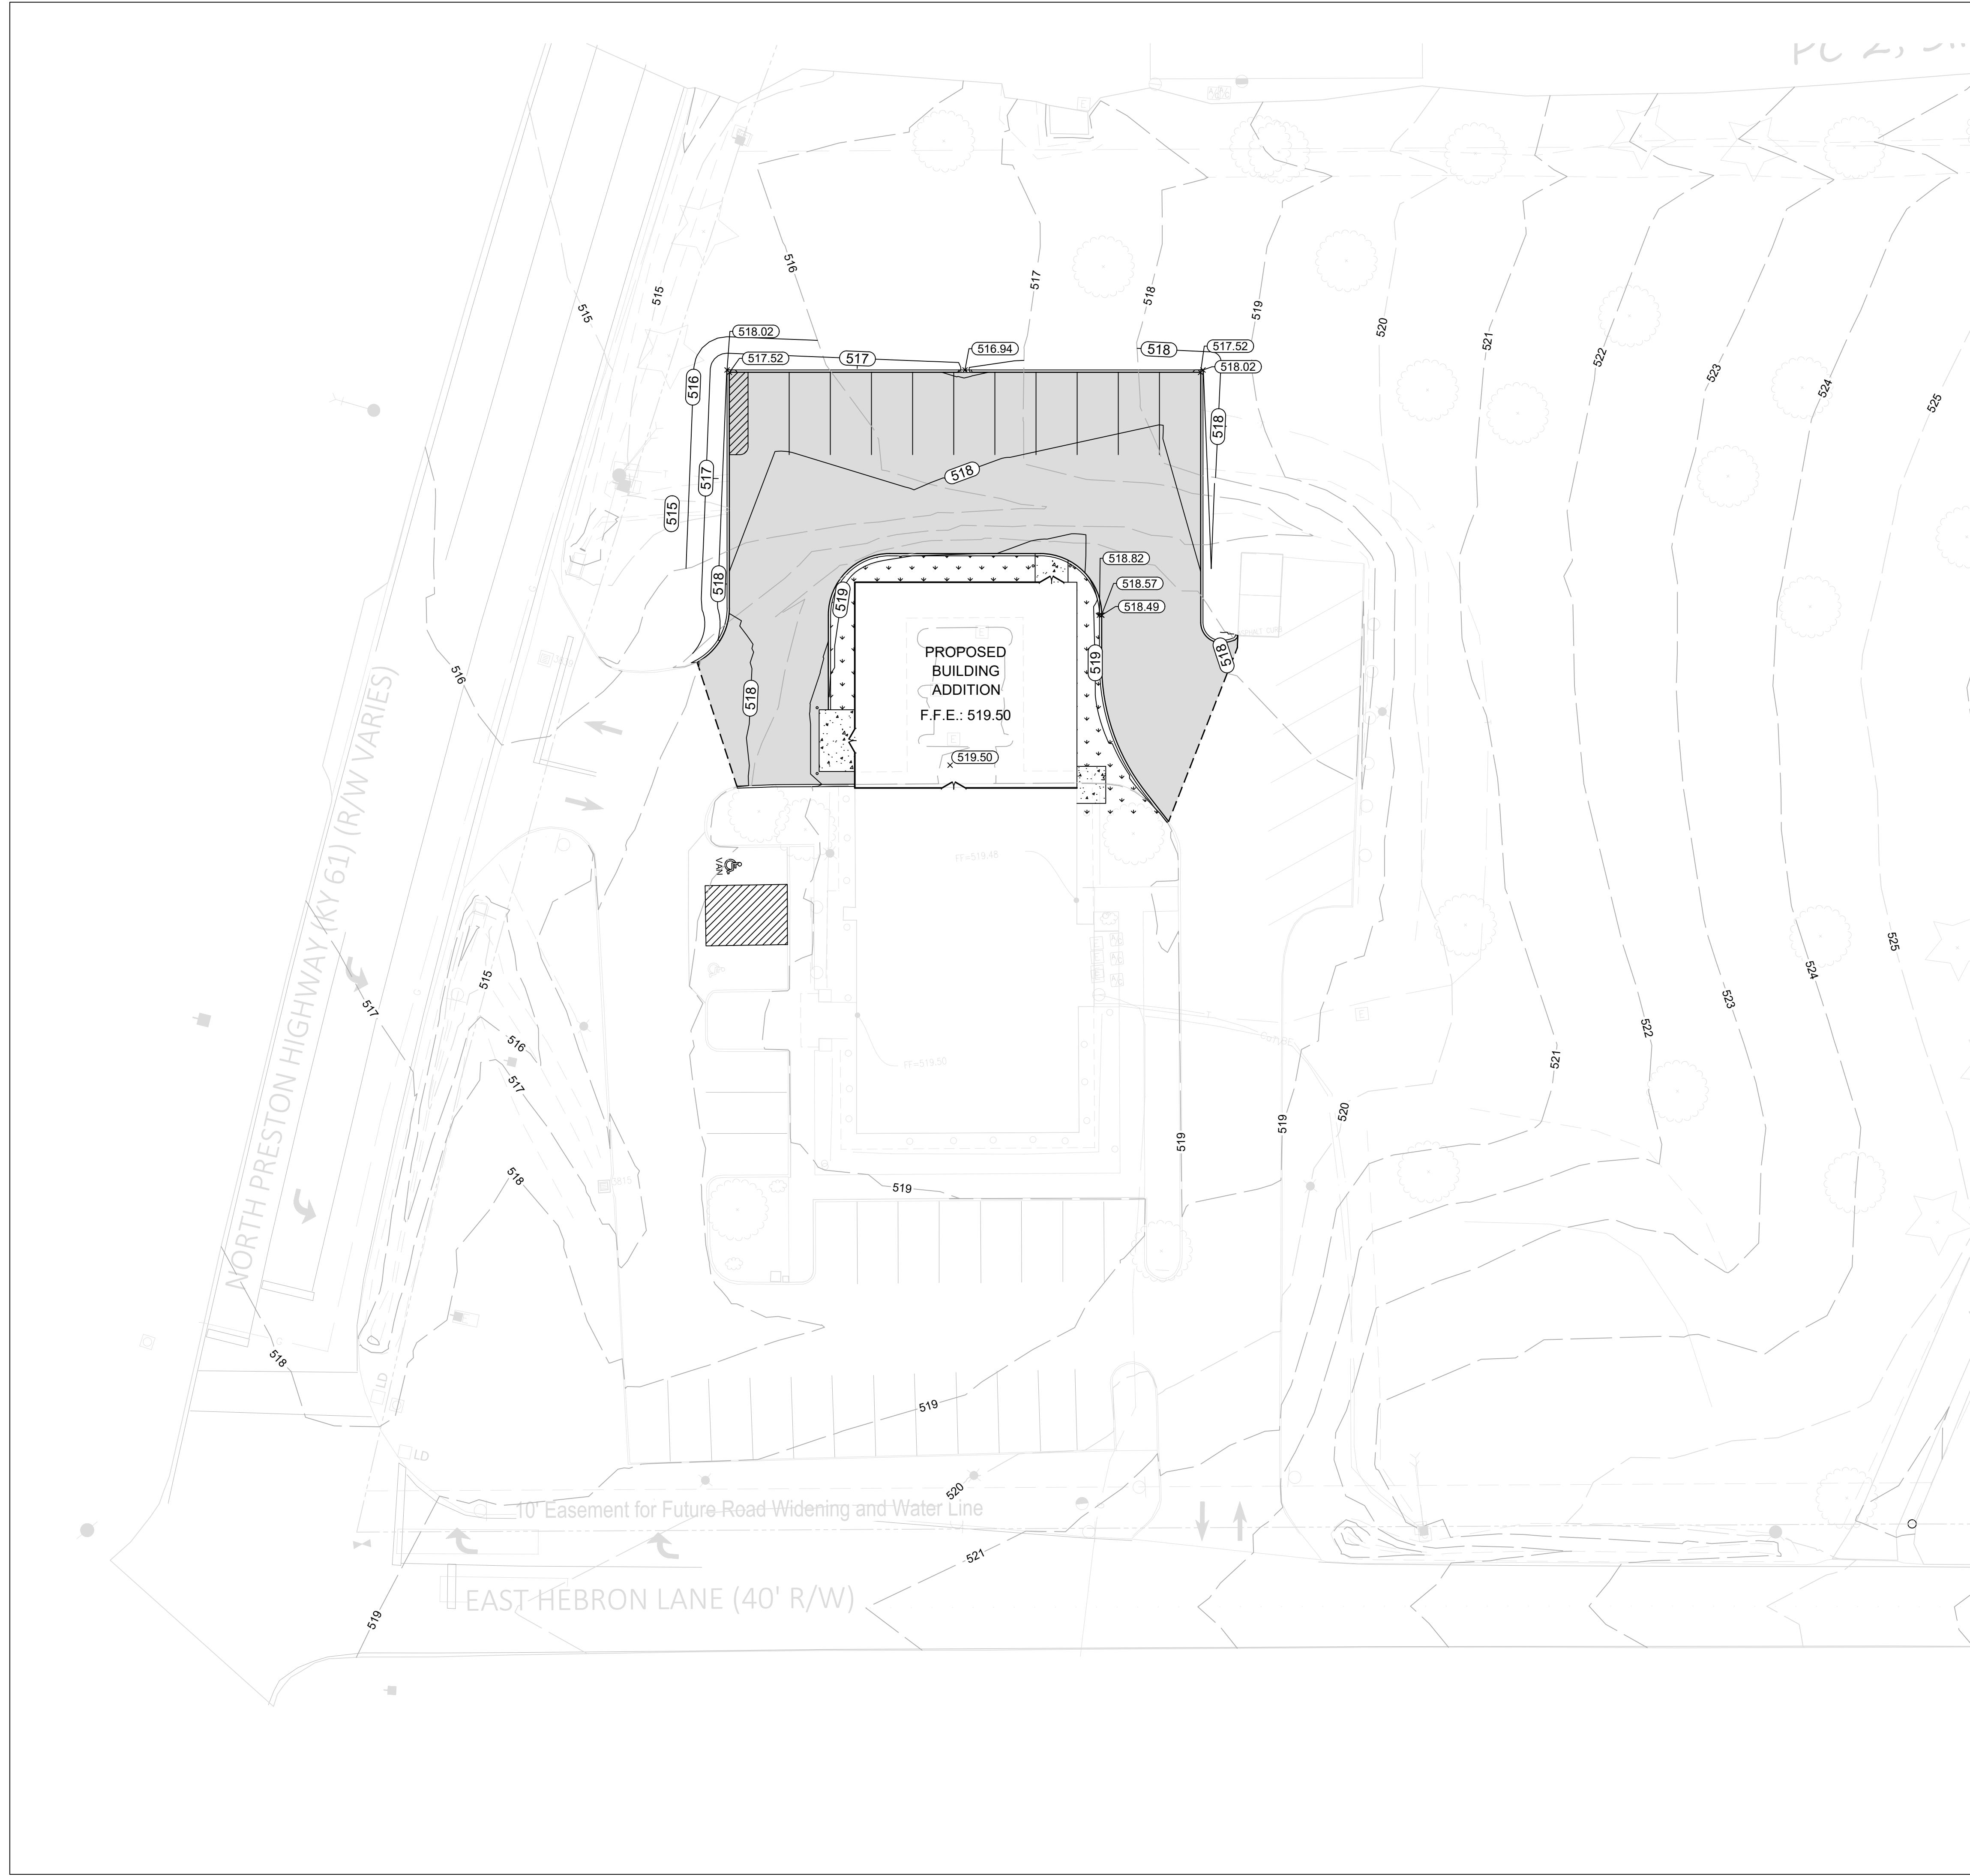CURRENT ZONING: B-2
PROPOSED ZONING: B-2

SITE AREA: 2.95 AC (128,398.10 SF)
LIMITS OF DISTURBANCE: 0.36 AC (15,830.22 SF)

EXISTING BUILDING FOOTPRINT: 4,533 SF
PROPOSED BUILDING FOOTPRINT: 7,233 SF

EXISTING IMPERVIOUS AREA: 34,748.44 SF (0.27%)
PROPOSED IMPERVIOUS AREA: 40,513.10 SF (0.32%)
TOTAL AREA INCREASE: 5,764.66 SF

REQUIRED PARKING: 37 TOTAL SPACES (2 ADA)
REQUIRED ADA PARKING: 2 SPACES (1 VAN ACCESS.)
PROPOSED PARKING: 42 TOTAL SPACES (2 ADA)
PROPOSED ADA PARKING: 2 SPACES (1 VAN ACCESS.)

EARTHWORK DATA:

REQUIRED EARTHWORK: 422.78 CY FILL
PROPOSED EARTHWORK: 426.12 CY FILL


PROPOSED PAVEMENT LEGEND

CONCRETE	LIGHT-DUTY ASPHALT
----------	--------------------

DATE:

STATE OF KENTUCKY
MICHAEL R. BRYAR
36119
LICENSED PROFESSIONAL ENGINEER

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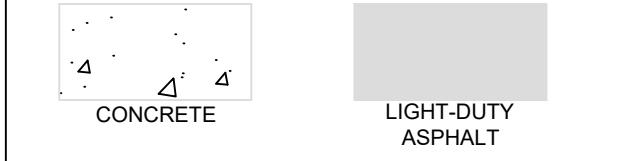
PLAN KEYNOTES

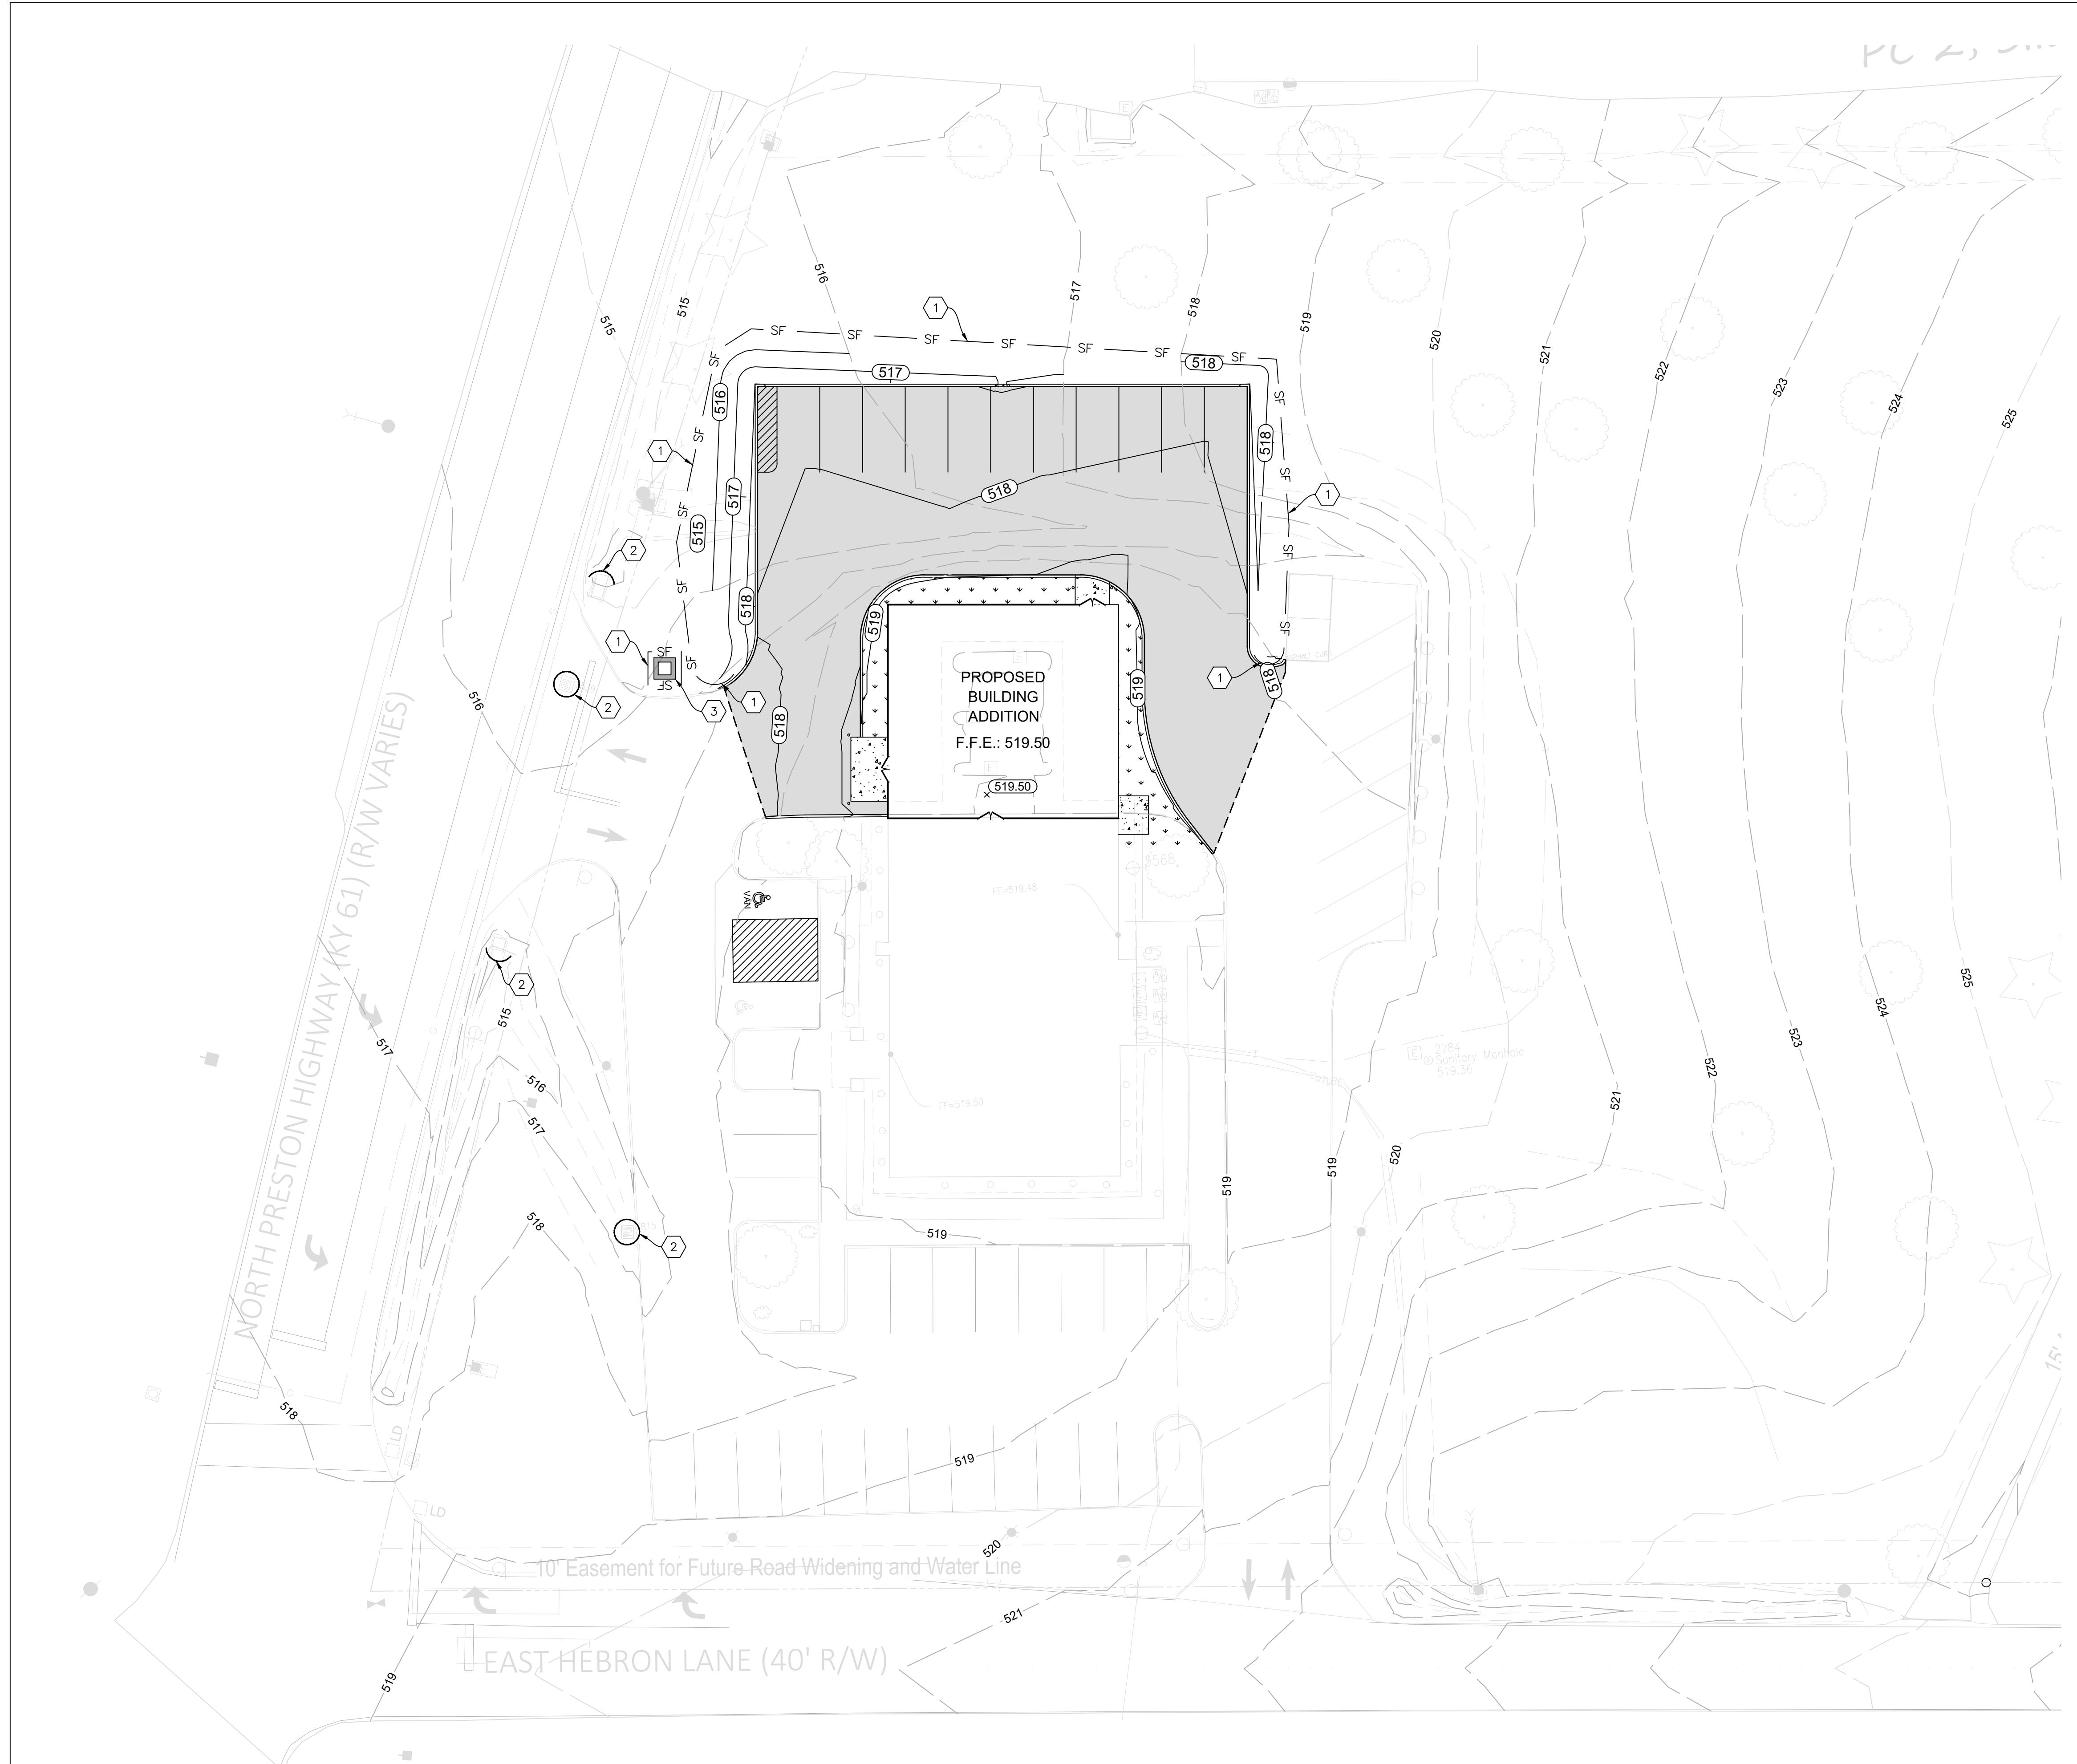1. SILT FENCE, SEE DETAIL 10 ON SHEET C-600
2. STORM INLET PROTECTION, SEE DETAIL 11 ON SHEET C-600
3. CONCRETE WASHOUT, SEE DETAIL 12 ON SHEET C-600


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PROPOSED ADA PARKING:	2 SPACES (1 VAN ACCESS.)

PROPOSED PAVEMENT LEGEND



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DATE:

EPSC PLAN

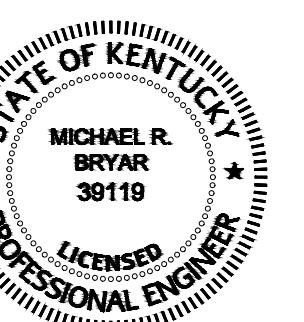TEAMSTERS 2727
CIVIL SITE IMPROVEMENTS
4810 N PRESTON HWY
SHEPHERDSVILLE, KY 40165

DATE: 01/09/2026

DESIGN PHASE

NOT FOR CONSTRUCTION

PROJECT NUMBER:	REVISION	DATE

DESIGNED BY: KH
DRAWN BY: KH
CHECKED BY: MB

SHEET NO.:

C400












SCALE: 1" = 20' Feet

6 OF 7

CIVIL DETAILS

TEAMSTERS 2727
CIVIL SITE IMPROVEMENTS
4810 N PRESTON HWY
SHEPHERDSVILLE, KY 40165

DATE: 01/09/2026		
DESIGN PHASE NOT FOR CONSTRUCTION		
PROJECT NUMBER:		
#	REVISION	DATE
DESIGNED BY: KH		
DRAWN BY: KH		
CHECKED BY: MB		
SHEET NO.: C600		

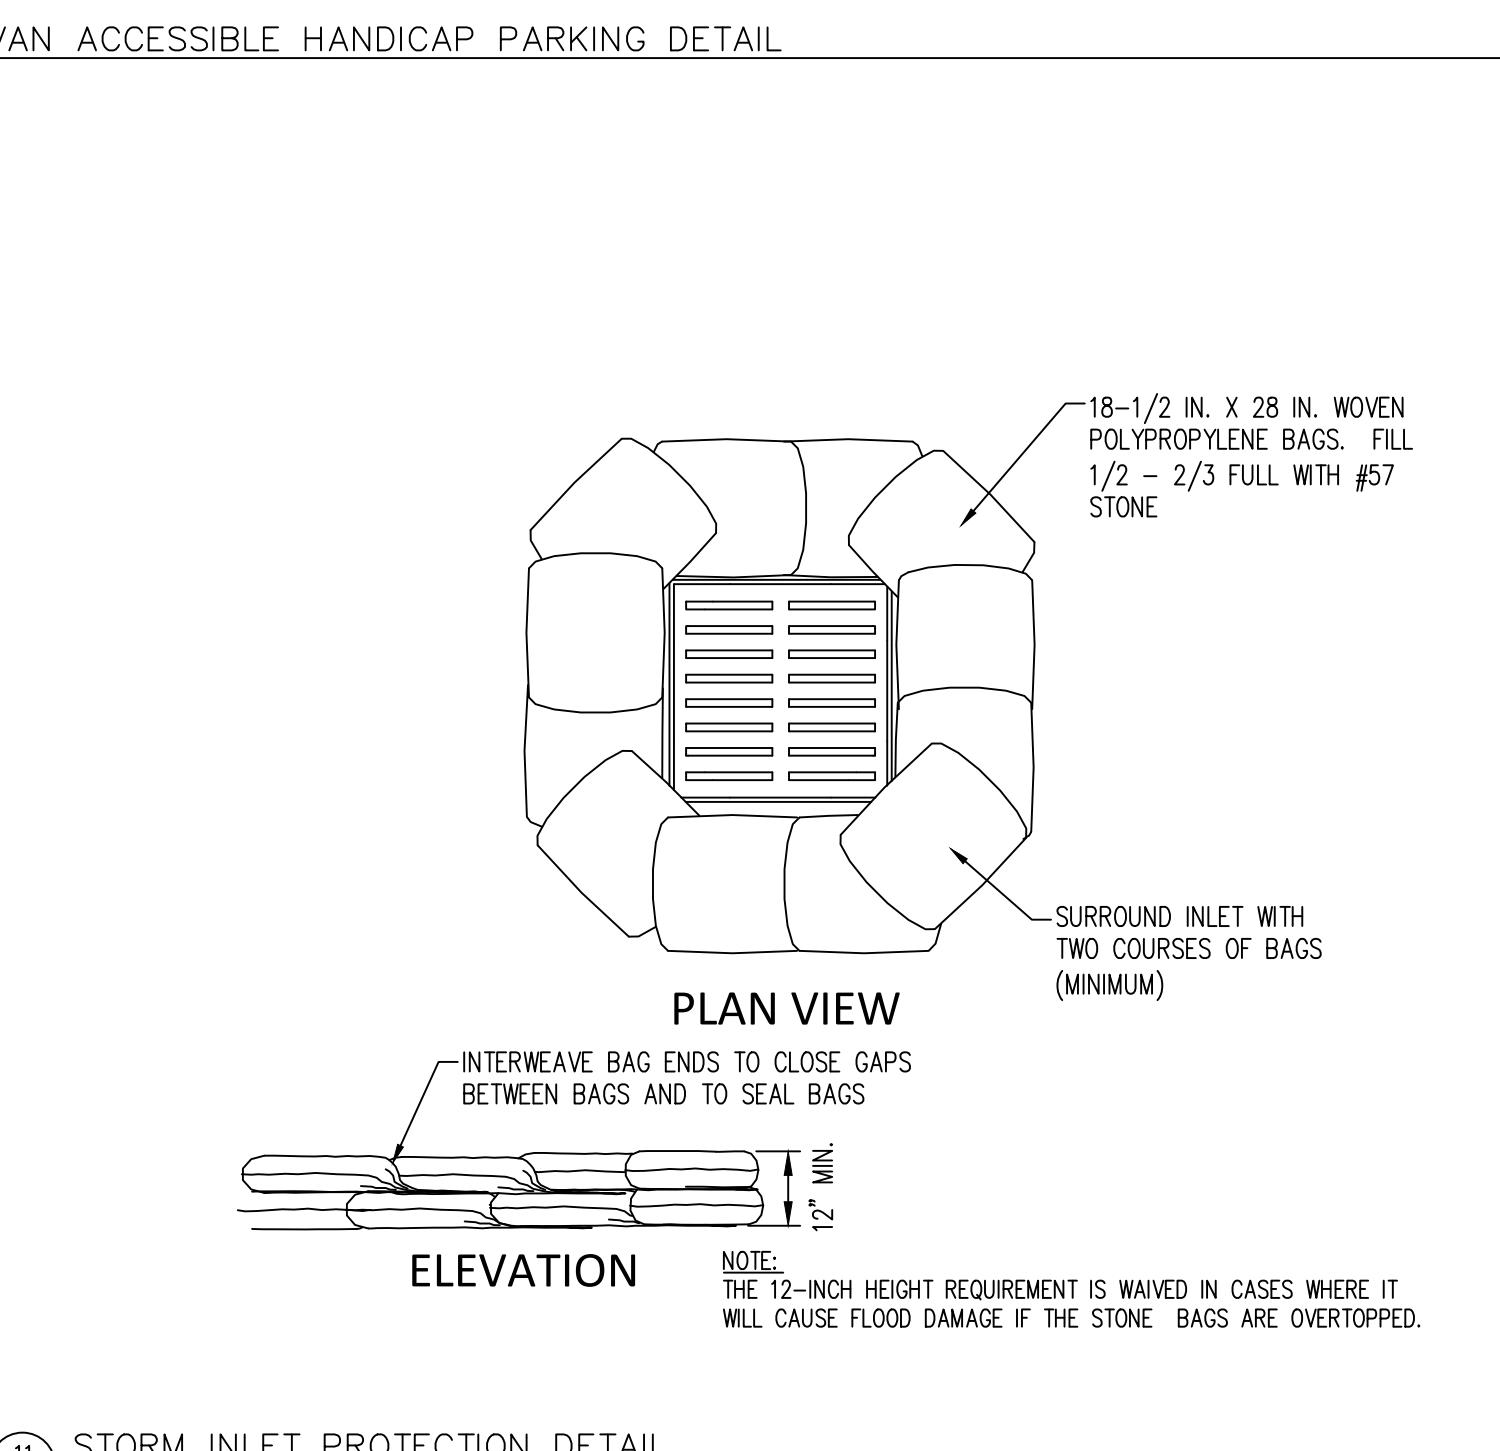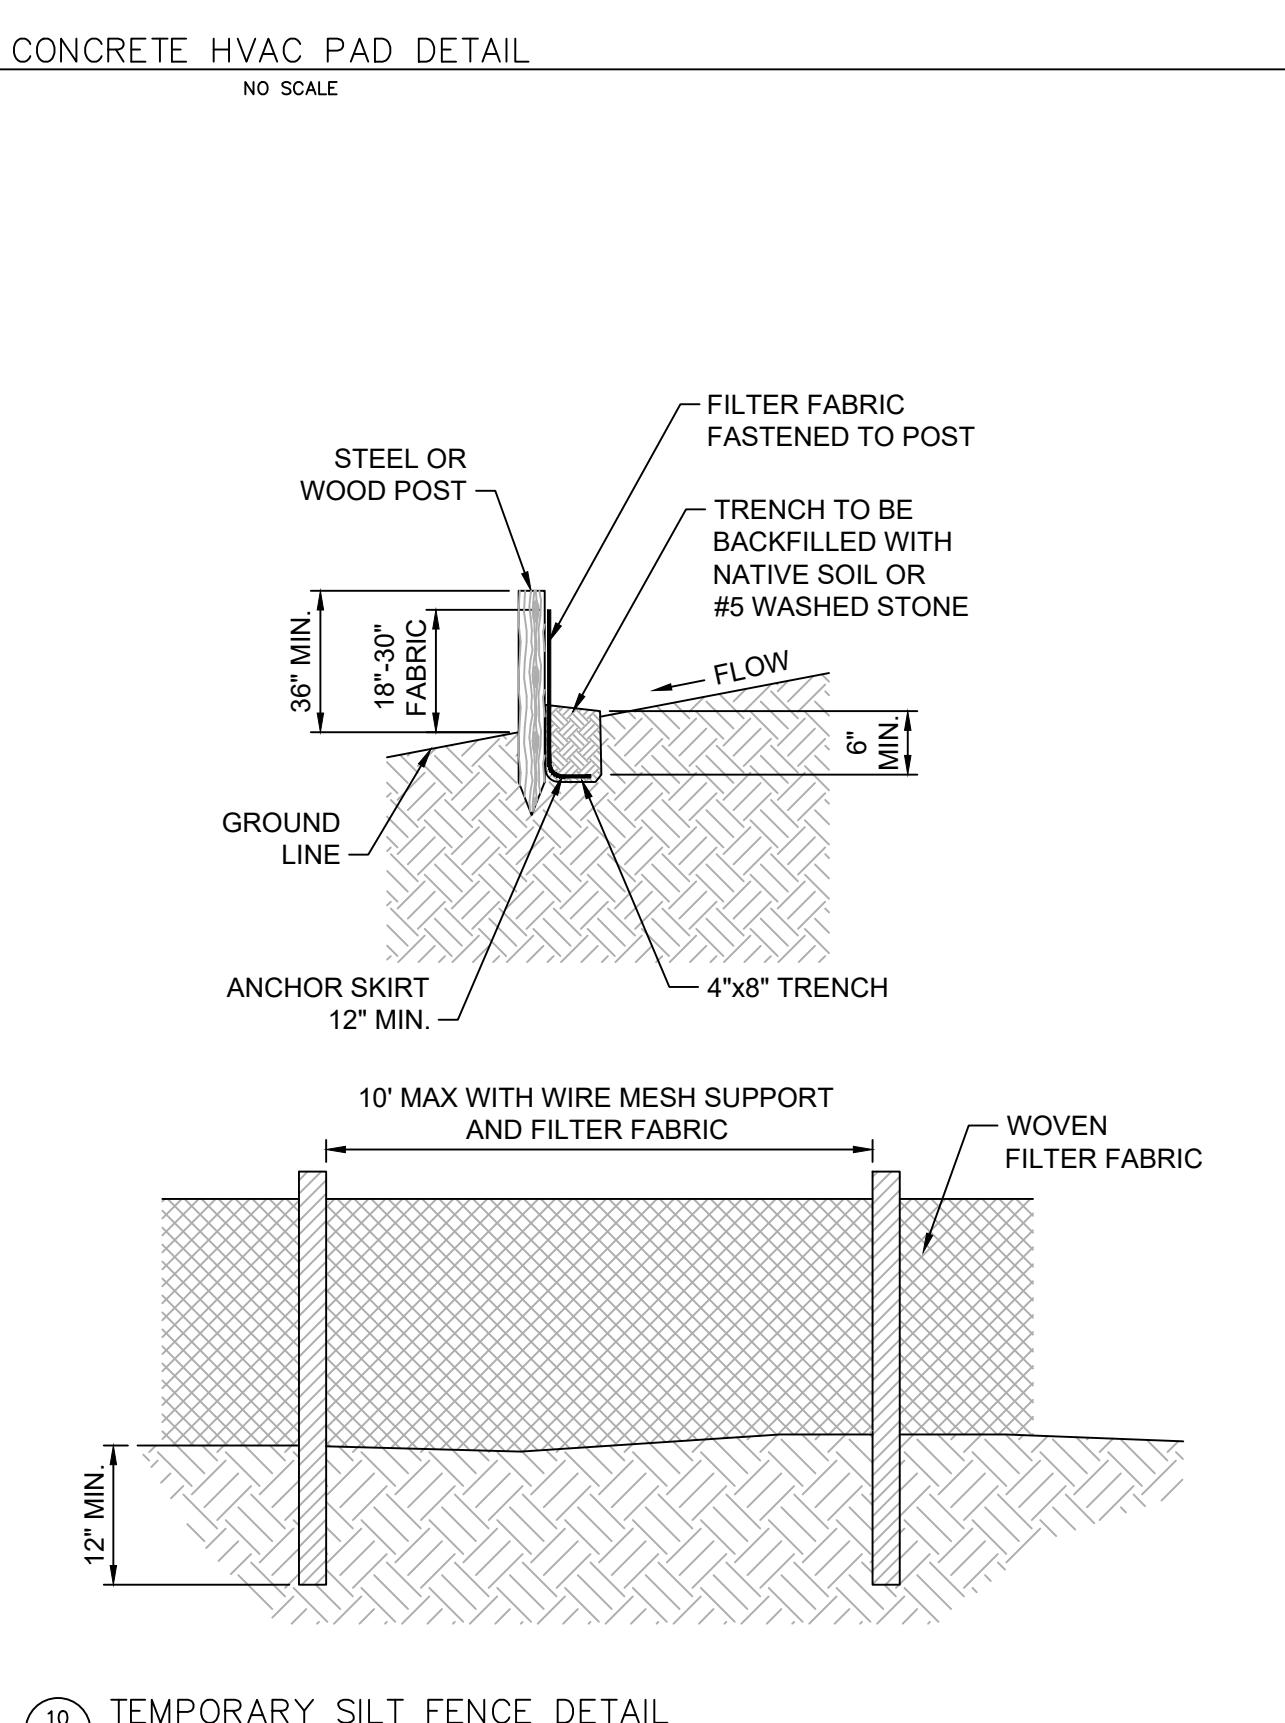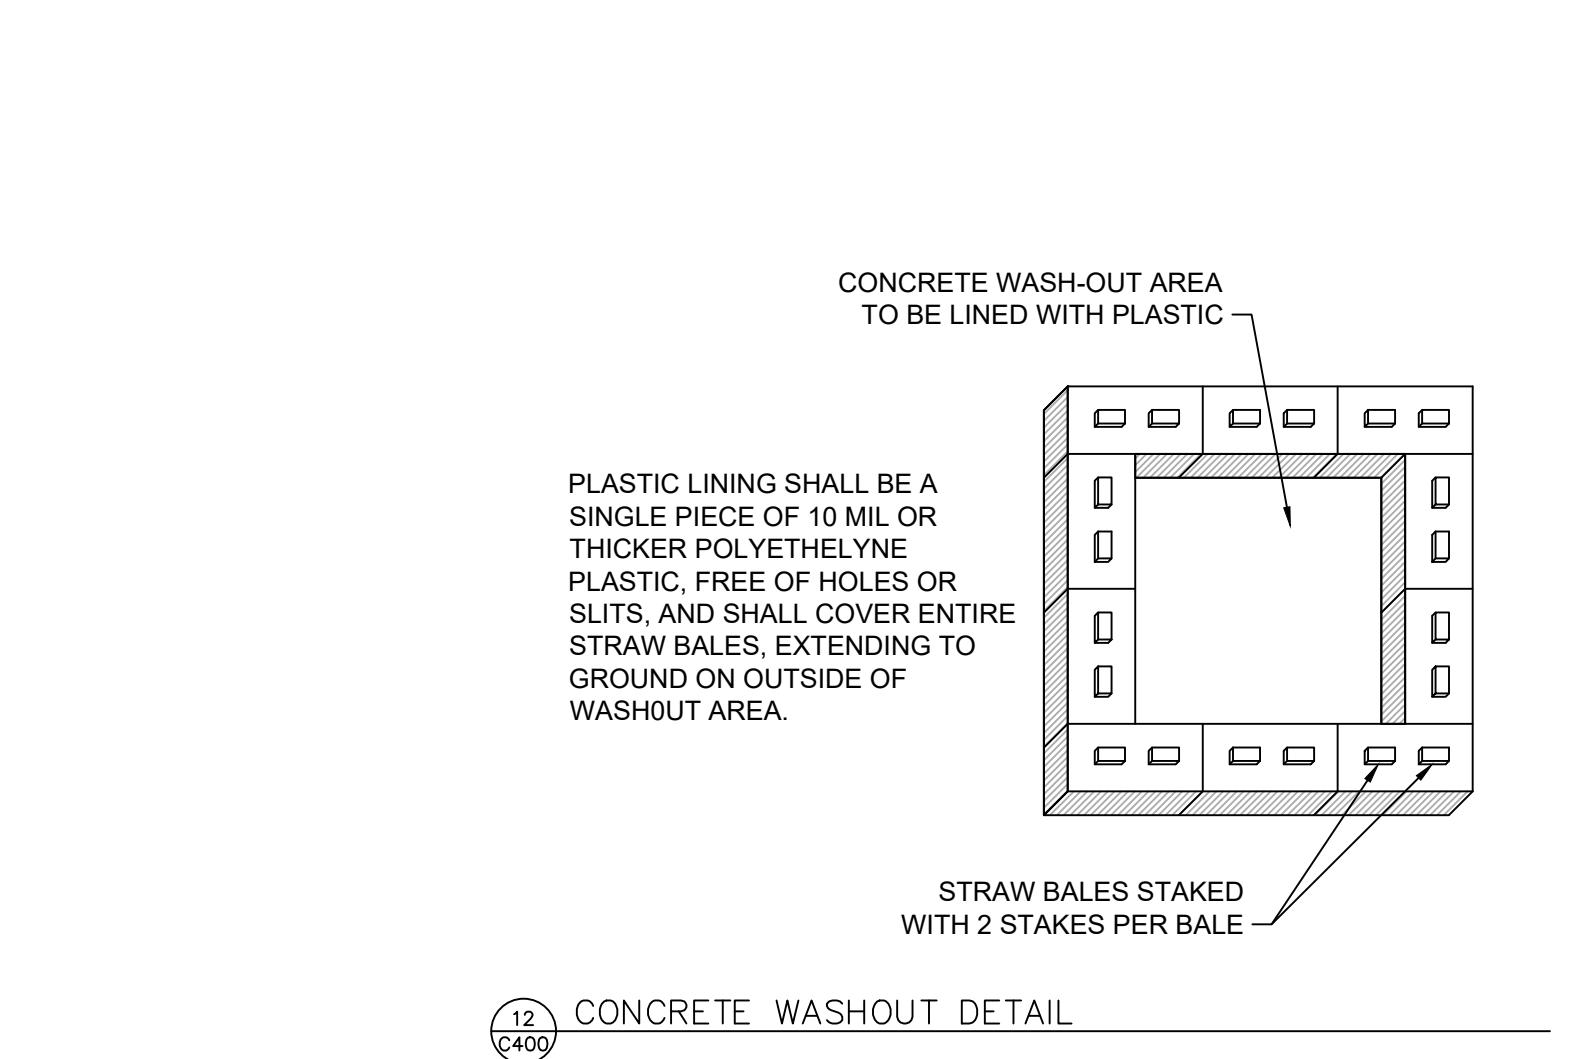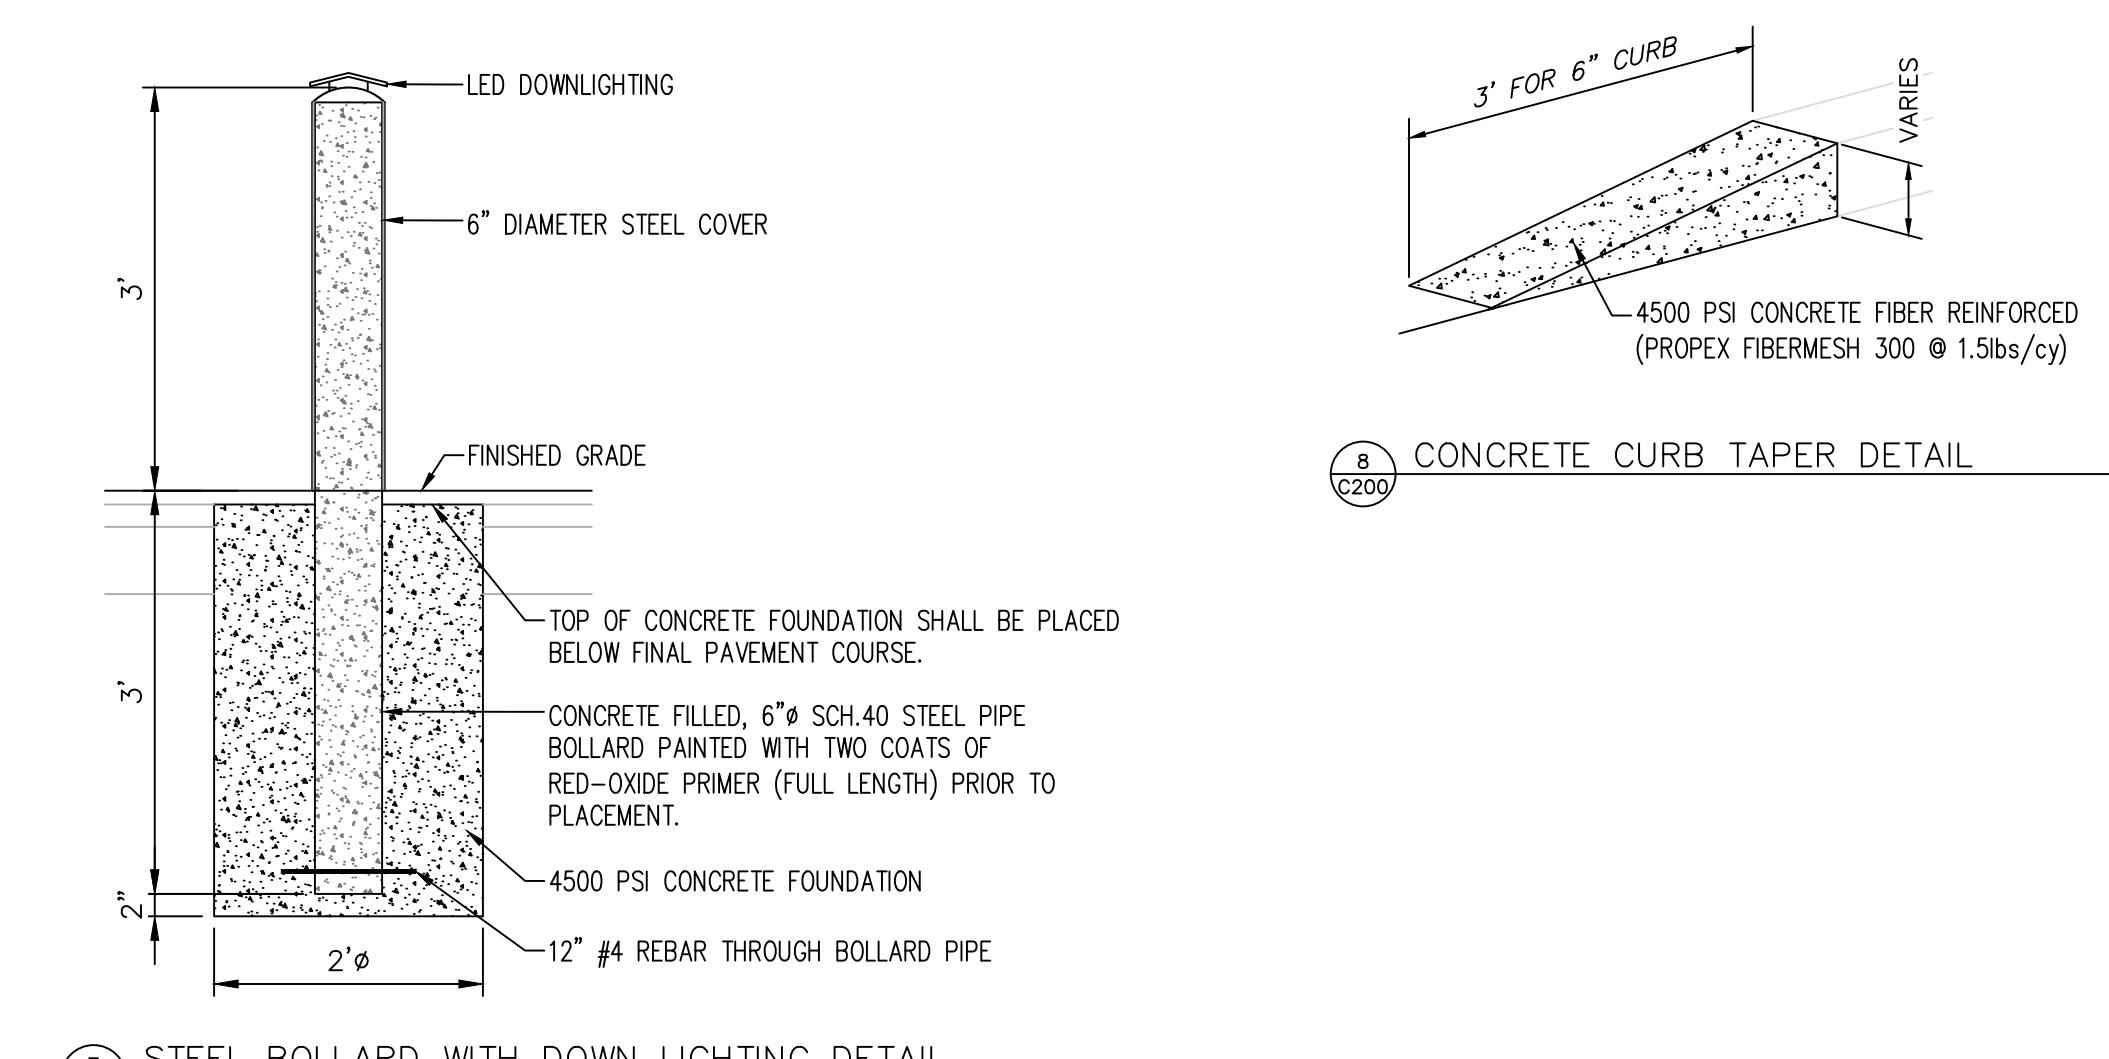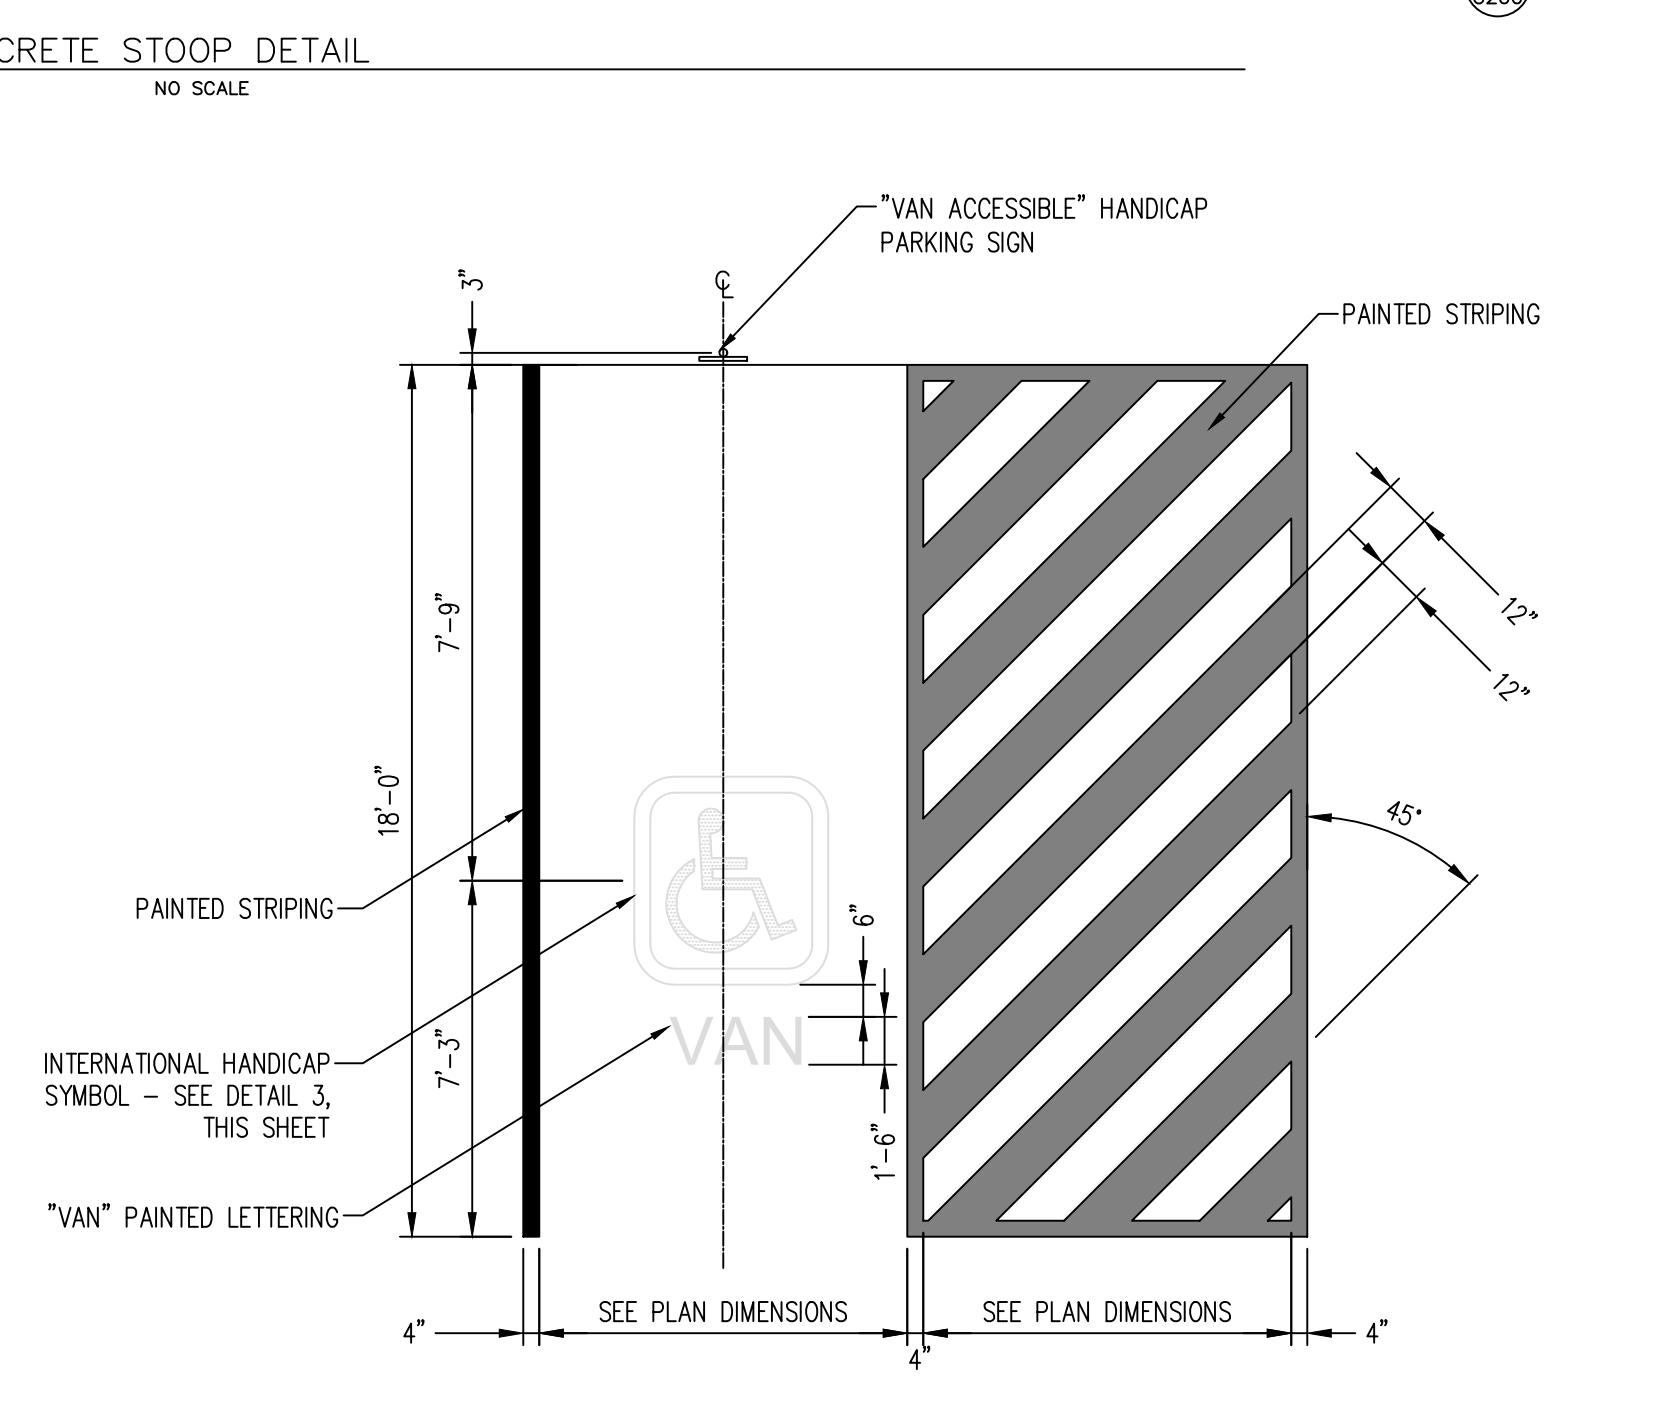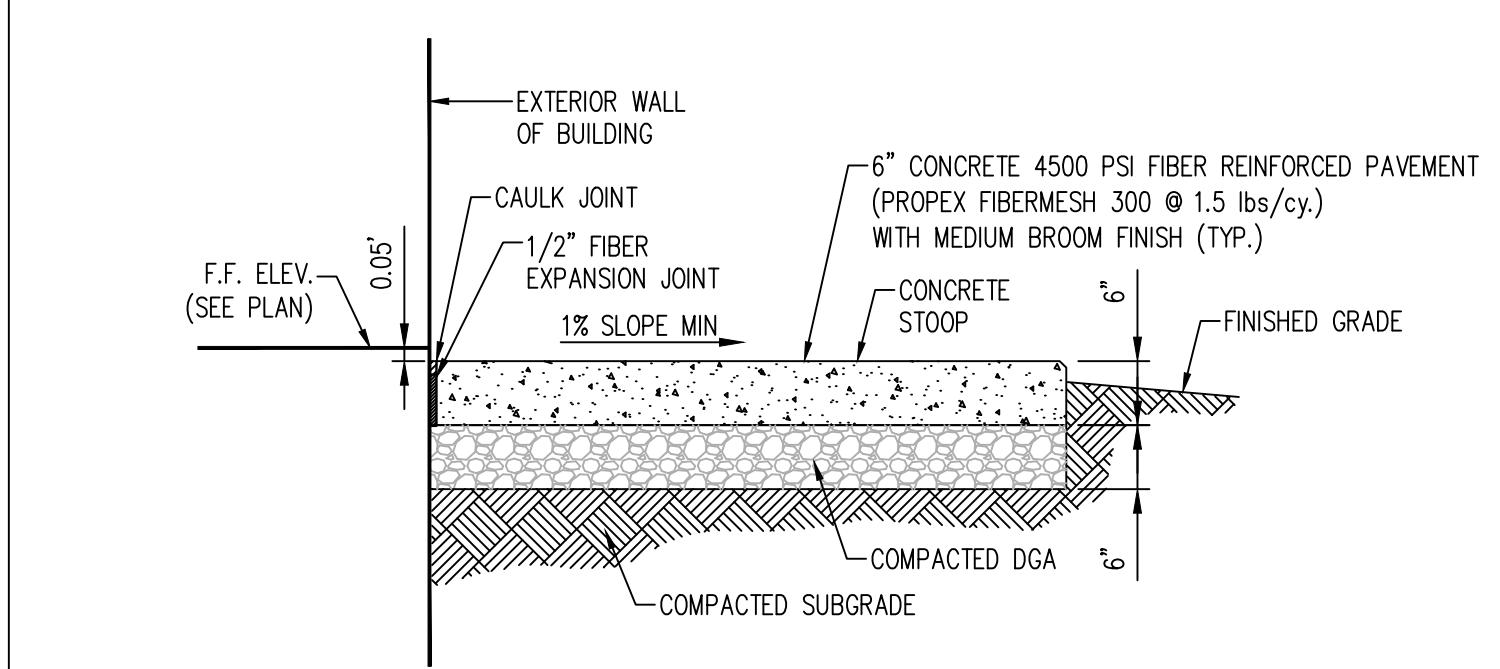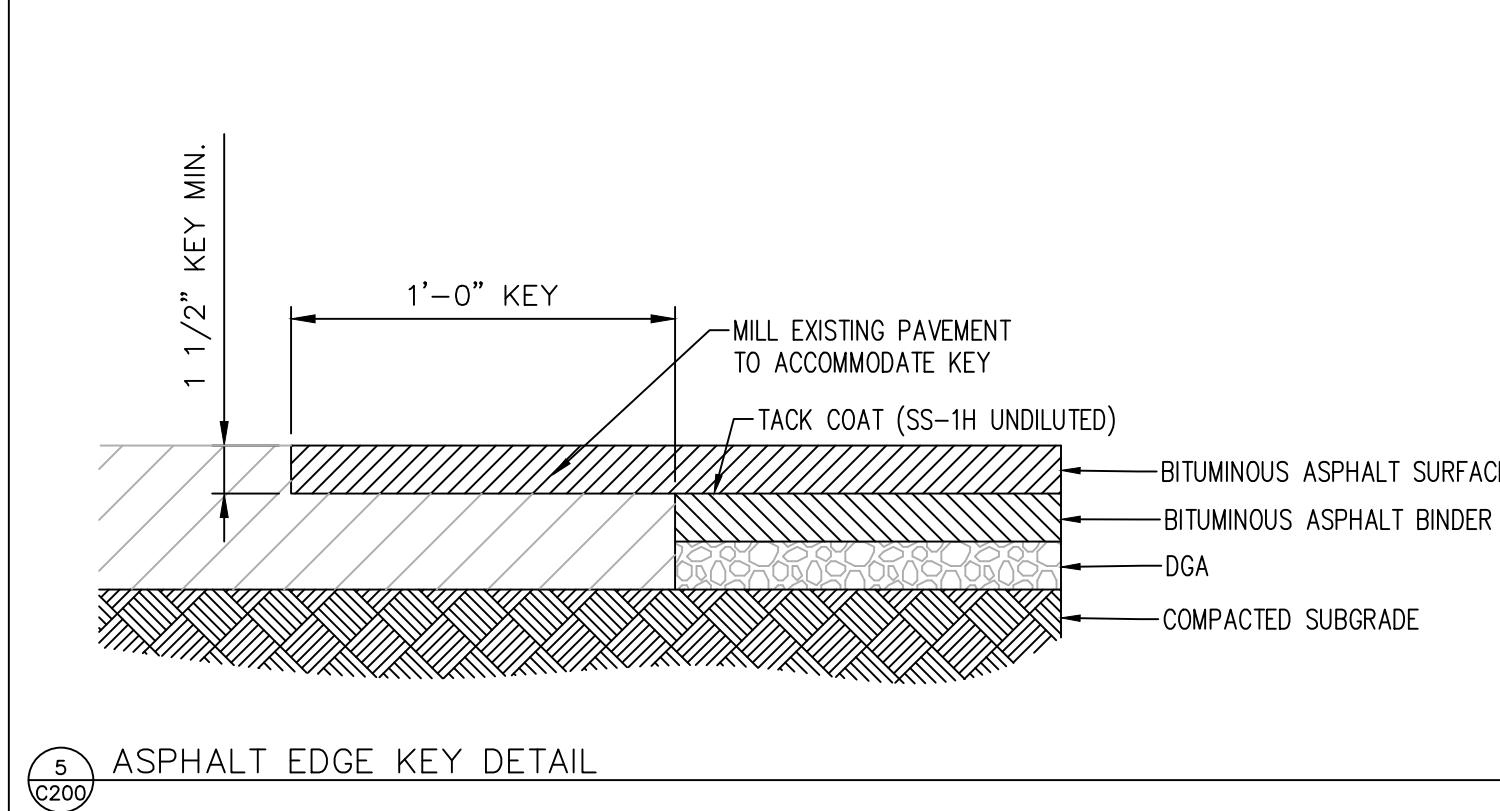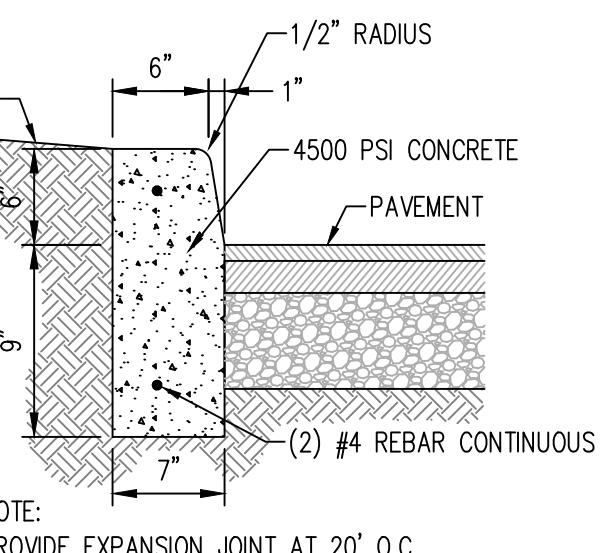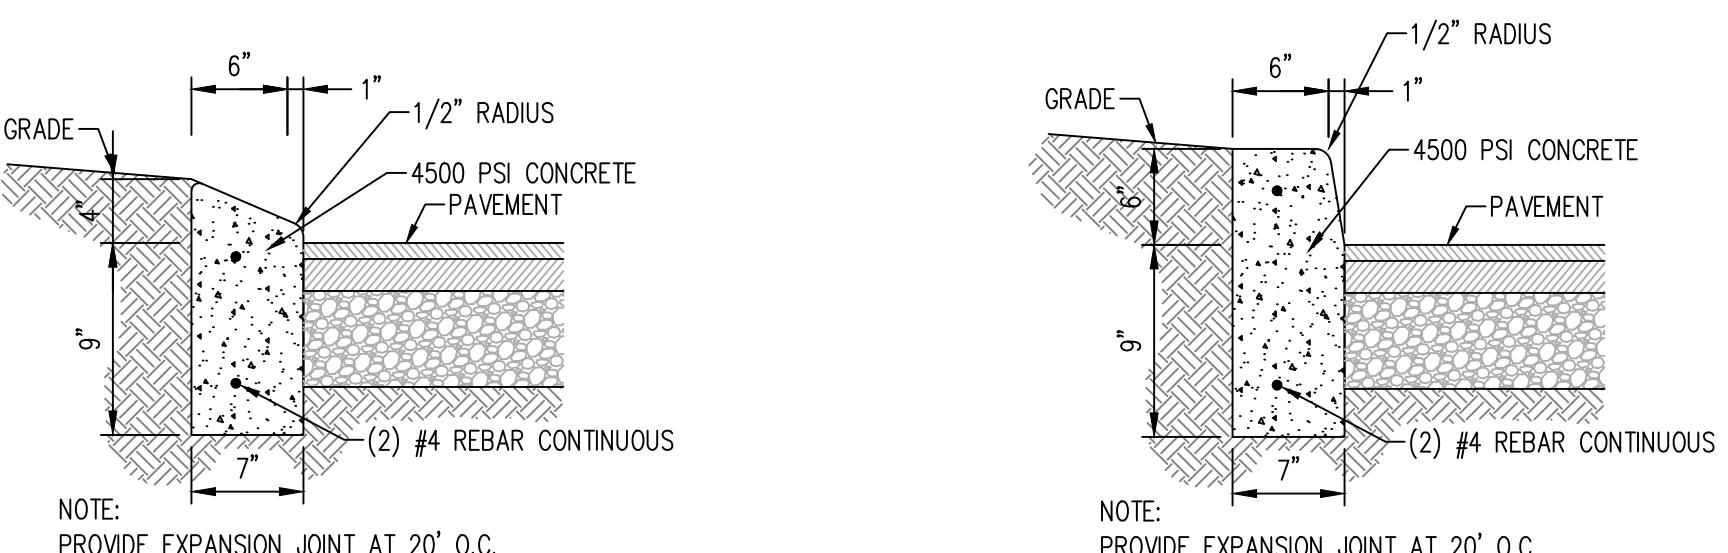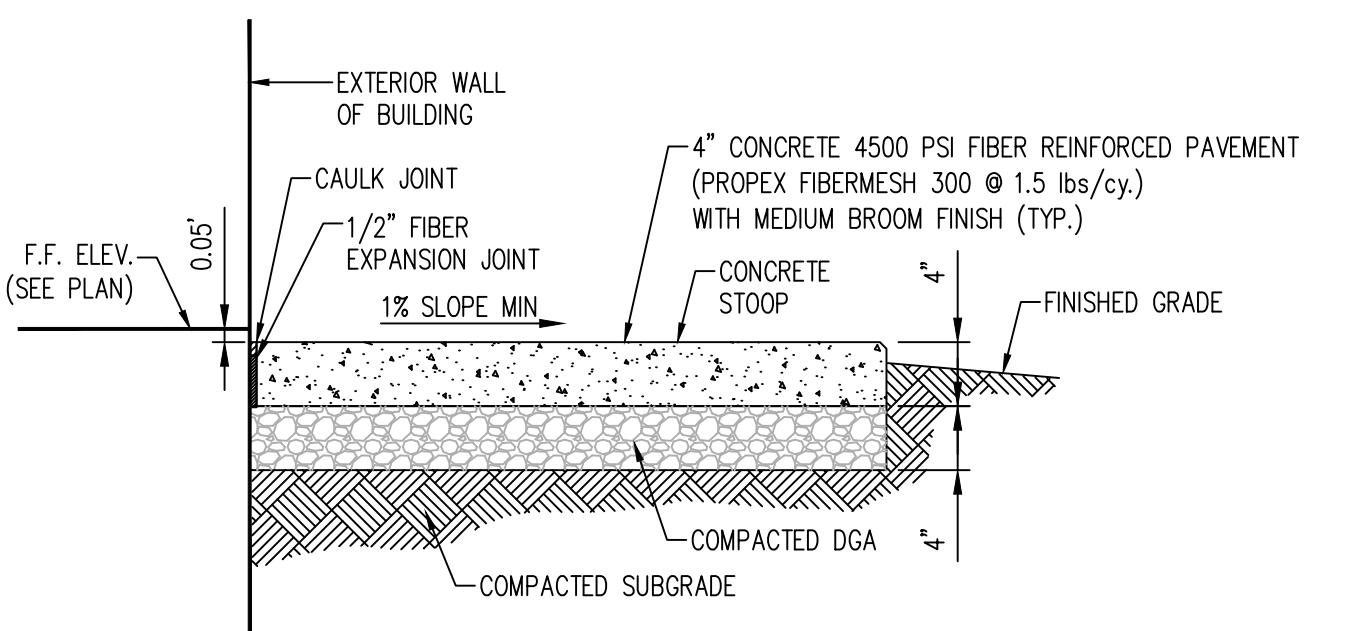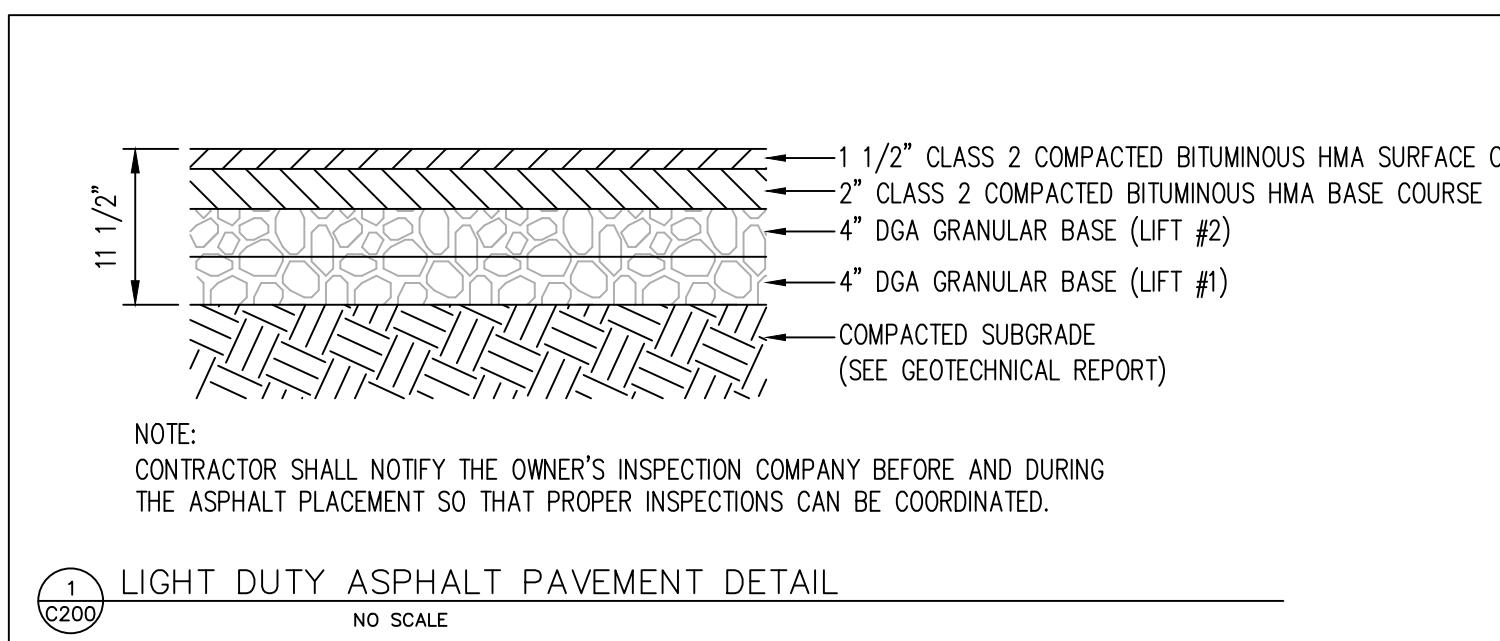

GENERAL CONDITIONS		STRUCTURAL DESIGN CRITERIA		WOOD CONSTRUCTION		PRE-FABRICATED WOOD TRUSS		GENERAL NOTES REGARDING SPECIAL INSPECTIONS AND TESTS	
1. COORDINATE WITH ALL DRAWINGS FOR PERTINENT INFORMATION RELATED TO THE STRUCTURAL WORK. ANY CHANGES TO THE STRUCTURAL SYSTEMS SHALL BE RE-DESIGNED BY A REGISTERED PROFESSIONAL ENGINEER AT NO COST TO THE OWNER OR A/E AND SUBMITTED TO THE A/E FOR REVIEW. SUBMITTAL SHALL BE ACKNOWLEDGED IN WRITING BEFORE BEGINNING CONSTRUCTION		1. GOVERNING CODE: KENTUCKY BUILDING CODE, 2018 EDITION 2. BUILDING RISK CATEGORY: II 3. DESIGN SOIL BEARING PRESSURE: 2,000 PSF		1. WOOD CONSTRUCTION SHALL CONFORM TO THE ANSI/AIF AND PA "NATIONAL SPECIFICATION FOR WOOD CONSTRUCTION". 2. STRESS GRADE LUMBER AND GLUE LAMINATED MEMBERS FOR JOISTS, BEAMS, TRUSSES, AND COLUMNS SHALL DEVELOP WORKING STRESSES AND A MODULUS OF ELASTICITY AS FOLLOWS:		1. PRE-FABRICATED WOOD TRUSSES SHALL BE DESIGNED IN ACCORDANCE WITH THE "NATIONAL DESIGN SPECIFICATION FOR STRESS-GRADE LUMBER AND ITS FASTENINGS" AS RECOMMENDED BY THE NATIONAL FOREST PRODUCTS ASSOCIATION. 2. DESIGN OF MEMBERS AND CONNECTIONS SHALL BE DONE BY A REGISTERED PROFESSIONAL ENGINEER, REGISTERED IN THE JURISDICTION OF THE PROJECT, EXPERIENCED IN SIMILAR DESIGN AND RETAINED BY THE MANUFACTURER.		1. SPECIAL INSPECTIONS ARE IN ADDITION TO INSPECTIONS BY THE BUILDING OFFICIAL THAT ARE IDENTIFIED IN SECTION 110 OF THE BUILDING CODE. SPECIAL INSPECTIONS DO NOT RELIEVE THE CONTRACTOR FROM COMPLYING WITH THE CONTRACT DOCUMENTS. 2. CONTINUOUS SPECIAL INSPECTION IS DEFINED AS SPECIAL INSPECTION BY THE SPECIAL INSPECTOR WHO IS PRESENT CONTINUOUSLY WHEN AND WHERE THE WORK TO BE INSPECTED IS BEING PERFORMED. 3. PERIODIC SPECIAL INSPECTION IS DEFINED AS SPECIAL INSPECTION BY THE SPECIAL INSPECTOR WHO IS INTERMITTENTLY PRESENT WHERE THE WORK TO BE INSPECTED HAS BEEN OR IS BEING PERFORMED. THE FREQUENCY OF THESE SPECIAL INSPECTION TASKS SHALL BE ADEQUATE TO DETERMINE THAT WORK HAS BEEN PERFORMED IN ACCORDANCE WITH THE APPROVED CONSTRUCTION DOCUMENTS. 4. WHERE A SPECIAL INSPECTION TASK IS NOTED AS "OBSERVE," THE SPECIAL INSPECTOR SHALL OBSERVE THESE ITEMS ON A RANDOM BASIS. OPERATIONS NEED NOT BE DELAYED PENDING THESE INSPECTIONS. THE FREQUENCY OF THESE SPECIAL INSPECTION TASKS SHALL BE ADEQUATE TO DETERMINE THAT THE WORK HAS BEEN PERFORMED IN ACCORDANCE WITH THE APPROVED CONSTRUCTION DOCUMENTS. 5. WHERE A SPECIAL INSPECTION TASK IS NOTED AS "PERFORM," THE TASK SHALL BE PERFORMED FOR EACH MEMBER, JOINT, OR ELEMENT PRIOR TO FINAL ACCEPTANCE. 6. THE SPECIAL INSPECTOR SHALL BE A QUALIFIED PERSON EMPLOYED OR RETAINED BY AN APPROVED AGENCY AND APPROVED BY THE BUILDING OFFICIAL AS HAVING THE COMPETENCE NECESSARY TO INSPECT A PARTICULAR TYPE OF CONSTRUCTION REQUIRING SPECIAL INSPECTION. 7. THE PERIOD OF TIME BETWEEN SPECIAL INSPECTIONS CAN VARY GREATLY DEPENDING ON THE TYPE OF INSPECTION DONE, THE TYPE OF CONSTRUCTION, THE QUALITY OF WORKMANSHIP, AND OTHER FACTORS. IT IS THE RESPONSIBILITY OF THE SPECIAL INSPECTOR TO PROVIDE INSPECTIONS AT AN APPROPRIATE FREQUENCY AND AT APPROPRIATE TIMES DURING CONSTRUCTION. THE SPECIAL INSPECTOR MUST HAVE ADEQUATE EXPERIENCE AND EXHIBIT PROFESSIONAL JUDGEMENT IN DETERMINING THE TIMING AND FREQUENCY OF INSPECTIONS. 8. PRIOR TO THE START OF CONSTRUCTION, THE APPROVED SPECIAL INSPECTION AGENCY SHALL SUBMIT WRITTEN DOCUMENTATION TO THE BUILDING OFFICIAL DEMONSTRATING THE COMPETENCE AND RELEVANT EXPERIENCE OR TRAINING OF THE SPECIAL INSPECTORS WHO WILL PERFORM THE SPECIAL INSPECTIONS AND TESTS DURING CONSTRUCTION. 9. THE CONSTRUCTION OR WORK FOR WHICH SPECIAL INSPECTION OR TESTING IS REQUIRED SHALL REMAIN ACCESSIBLE AND EXPOSED FOR SPECIAL INSPECTION OR TESTING PURPOSES UNTIL COMPLETION OF REQUIRED SPECIAL INSPECTIONS OR TESTS. SEE SPECIFICATION FOR ADDITIONAL REQUIREMENTS, INCLUDING CONTRACTOR'S RESPONSIBILITY TO PROVIDE ACCESS FOR SPECIAL INSPECTIONS AND CONTRACTOR'S RESPONSIBILITY TO PROVIDE DUE NOTICE TO SPECIAL INSPECTOR PRIOR TO THE TIME THAT SPECIAL INSPECTION IS REQUIRED. 10. SPECIAL INSPECTION AGENCY SHALL KEEP RECORDS OF SPECIAL INSPECTIONS AND TESTS AND SHALL SUBMIT REPORTS OF SPECIAL INSPECTIONS AND TESTS TO THE BUILDING OFFICIAL AND TO THE ENGINEER. REPORTS SHALL INDICATE THAT WORK INSPECTED OR TESTED WAS OR WAS NOT COMPLETED CONFORMANCE TO APPROVED CONSTRUCTION DOCUMENTS. DISCREPANCIES SHALL BE BROUGHT TO THE IMMEDIATE ATTENTION OF THE CONTRACTOR FOR CORRECTION. IF THEY ARE NOT CORRECTED, THE DISCREPANCIES SHALL BE BROUGHT TO THE ATTENTION OF THE BUILDING OFFICIAL AND TO THE ENGINEER PRIOR TO THE COMPLETION OF THAT PHASE OF THE WORK. A FINAL REPORT DOCUMENTING REQUIRED SPECIAL INSPECTIONS AND TESTS, AND CORRECTION OF ANY DISCREPANCIES NOTED IN THE INSPECTIONS AND TESTS, SHALL BE SUBMITTED TO THE BUILDING OFFICIAL. 11. WHERE SPECIAL INSPECTION OF STRUCTURAL MEMBERS OR ASSEMBLIES IS BEING CONDUCTED ON THE PREMISES OF A FABRICATOR'S SHOP, SPECIAL INSPECTION OF THE FABRICATED ITEMS SHALL BE PERFORMED DURING FABRICATION. 12. SPECIAL INSPECTIONS DURING FABRICATION ARE NOT REQUIRED WHERE THE WORK IS DONE ON THE PREMISES OF A FABRICATOR REGISTERED AND APPROVED BY THE BUILDING OFFICIAL TO PERFORM SUCH WORK WITHOUT SPECIAL INSPECTION. UPON THE COMPLETION OF FABRICATION, THE APPROVED FABRICATOR SHALL SUBMIT A CERTIFICATE OF COMPLIANCE TO THE OWNER OR THE OWNER'S AUTHORIZED AGENT FOR SUBMITTAL TO THE BUILDING OFFICIAL STATING THAT THE WORK WAS PERFORMED IN COMPLIANCE WITH THE APPROVED CONSTRUCTION DOCUMENTS. 13. REFER TO THE CODE SECTIONS REFERENCED IN THE HEADER OF EACH TABLE ON THIS SHEET FOR TESTING AND INSPECTION CRITERIA. 14. REFER TO PROJECT SPECIFICATIONS FOR ADDITIONAL TESTING AND INSPECTION CRITERIA.	
2. EQUIPMENT FRAMING LOADS, OPENINGS, AND STRUCTURE, IN ANY WAY RELATED TO HVAC, PLUMBING, PROCESS, ELECTRICAL, ELEVATOR, OR ESCALATOR REQUIREMENTS ARE SHOWN FOR BIDDING PURPOSES ONLY. CONTRACTOR SHALL OBTAIN APPROVAL OF THE PERTINENT TRADES BEFORE PROCEEDING WITH SUCH PORTION OF THE WORK. EXCESS COST RELATED TO VARIATION IN THESE REQUIREMENTS SHALL BE BORNE BY THE APPROPRIATE CONTRACTOR.		3. IT IS SOLELY THE CONTRACTOR'S RESPONSIBILITY TO DETERMINE THE ERECTION PROCEDURE AND SEQUENCES TO ENSURE THE SAFETY OF THE BUILDING AND ITS COMPONENTS DURING ERECTION. THIS INCLUDES, BUT IS NOT LIMITED TO, THE ADDITION OF TEMPORARY BRACING, SHORING, GUYS, OR TIE-DOWNS THAT MAY BE NECESSARY.		4. THE STRUCTURE HAS BEEN DESIGNED FOR THE UNIFORM LOADS INDICATED IN ADDITION TO THE CONCENTRATED LOADS REQUIRED BY THE BUILDING CODE. THE STRUCTURAL DESIGN IS BASED SOLELY ON THE BUILDING IN ITS COMPLETED STATE. CONTRACTORS AND THEIR SUB-CONTRACTORS SHALL TAKE NECESSARY PRECAUTIONS TO WITHSTAND ALL HORIZONTAL AND VERTICAL LOADINGS THAT MAY BE ENCOUNTERED DURING CONSTRUCTION PRIOR TO COMPLETION OF THE BUILDING. SUCH CONSTRUCTION LOADINGS INCLUDE, BUT ARE NOT LIMITED TO, LOADS FROM CRANES, LIFTS, DOLIES, AND HOISTS. THE CONTRACTOR IS SOLELY RESPONSIBLE FOR THE EVALUATION OF THE IMPACT OF SUCH LOADS ON THE STRUCTURE AND PROVIDING TEMPORARY SHORING, BRACING, OR REINFORCEMENT AS REQUIRED.		5. SEE THE ARCHITECTURAL DRAWINGS FOR ALL DIMENSIONS NOT SHOWN ON THE STRUCTURAL DRAWINGS. ALL DIMENSIONS AND ELEVATIONS SHOWN ON THE STRUCTURAL DRAWINGS SHALL BE VERIFIED BY THE CONTRACTOR AND SHALL CONFORM TO THOSE SHOWN ON THE ARCHITECTURAL DRAWINGS. REPORT ALL DISCREPANCIES TO THE A/E FOR RESOLUTION BEFORE PROCEEDING.		6. THE CONTRACTOR SHALL SUPPORT, BRACE, AND SECURE EXISTING STRUCTURES AS REQUIRED. THE CONTRACTOR IS SOLELY RESPONSIBLE FOR THE SAFETY OF EXISTING STRUCTURES DURING CONSTRUCTION. FIELD VERIFY ALL EXISTING DIMENSIONS WHICH AFFECT THE NEW CONSTRUCTION PRIOR TO FINAL DETAILING AND FABRICATION OF NEW STRUCTURAL ELEMENTS.	
EXISTING CONDITIONS		7. ALL EXISTING STRUCTURAL ELEMENTS (GLARS, BEAMS, WALLS, COLUMNS, FOUNDATIONS, ETC.) SHALL REMAIN INTACT UNLESS SPECIFICALLY NOTED TO BE REMOVED BY THE MOST RECENT DEMOLITION DOCUMENTS OR OTHERWISE NOTED ON THE STRUCTURAL DRAWINGS.		8. INFORMATION PROVIDED ON THESE DRAWINGS RELATED TO EXISTING CONDITIONS IS BASED ON AVAILABLE DESIGN DOCUMENTS AND LIMITED FIELD OBSERVATION. THE CONTRACTOR SHALL IMMEDIATELY REPORT TO AND AWAIT DIRECTION FROM THE A/E IF ANY DISCREPANCY BETWEEN THE CONTRACT DOCUMENTS AND THE EXISTING CONDITIONS IS DISCOVERED.		9. THIS PROJECT REQUIRES A SIGNIFICANT AMOUNT OF DRILLING INTO THE EXISTING REINFORCED CONCRETE STRUCTURE. THE CONTRACTOR WILL NOT RECEIVE ADDITIONAL PAYMENT FOR DIFFICULTIES ENCOUNTERED IN DRILLING DUE TO HARDESS OF MATERIALS, HITTING OF EXISTING REINFORCING, ETC.. ALL COSTS ASSOCIATED WITH DRILLING OF HOLES DUE TO HITTING EXISTING REINFORCING STEEL SHALL BE BORNE BY THE CONTRACTOR. THIS INCLUDES FILLING UNNECESSARY AND UNUSED HOLES WITH EPOXY GROUT. DO NOT CUT REINFORCING STEEL DURING CONCRETE DRILLING OR CORING OPERATIONS. LOCATE REINFORCING WITH A PACOMETER OR OTHER NON-DESTRUCTIVE TESTING DEVICE PRIOR TO DRILLING OR CORING OPERATIONS.		10. CORE DRILLS REQUIRED BY MECHANICAL OR ELECTRICAL TRADES, BUT NOT SHOWN ON THE STRUCTURAL DRAWINGS SHALL BE DOCUMENTED IN SKETCH FORM SHOWING EXACT DIMENSIONS AND LOCATIONS. THE SKETCH SHALL BE SUBMITTED TO THE A/E FOR COMMENT PRIOR TO PROCEEDING WITH THE DRILLING OPERATION.	
5. EXISTING SURFACE PREPARATION: INTENTIONALLY ROUGHEN EXISTING CONCRETE SURFACES WHERE NEW CONCRETE IS BEING PLACED AGAINST THE EXISTING CONCRETE AND CONNECTED BY DRILLING AND EPOXY GROUTING. THE ENTIRE COMMON SURFACE WHERE THE EXISTING CONCRETE ABUTS THE NEW SHALL BE COATED WITH AN EPOXY BONDING AGENT. FOLLOW ALL ADDITIONAL REQUIREMENTS OF SURFACE PREPARATION AS REQUIRED BY THE BONDING AGENT MANUFACTURER.		11. CONCRETE MINIMUM LAP SPLICING AND ANCHORAGE DIMENSION TABLE		12. DESIGN SNOW LOAD AND SNOW DRIFTING PARAMETERS ARE AS FOLLOWS:		13. THE INTENT OF THE FRAMING PLAN IS TO PROVIDE MEMBER SIZES, SPACING AND GENERAL LOCATION. ADJUSTMENTS WILL BE REQUIRED TO THE NUMBER AND LOCATION OF MEMBERS BASED ON FIELD CONDITIONS AND COORDINATION ISSUES WITH THE MECHANICAL, ELECTRICAL AND PLUMBING DRAWINGS. MEMBER SPANS AND SPACING MAY NOT BE INCREASED WITH THE PERMISSION OF THE STRUCTURAL ENGINEER.		14. THE CONNECTIONS INDICATED ARE BASED ON SIMPSON STRONG-TIE PRODUCTS WHICH REPRESENT THE TYPE OF CONNECTION AND LOAD CAPACITY REQUIRED. SUBSTITUTIONS WILL BE CONSIDERED PROVIDED DOWNWARD, UPLIFT AND LATERAL LOAD CAPACITY IS EQUAL TO THE SPECIFIED CONNECTORS. PROPOSED CONNECTOR SUBSTITUTIONS SHALL INCLUDE A COMPARISON OF THE LOAD CAPACITY OF EACH PROPOSED CONNECTOR WITH EACH SPECIFIED CONNECTOR SEALED BY A LICENSED ENGINEER IN THE STATE THE PROJECT IS LOCATED.	
13. CONCRETE REINFORCING CLEAR COVER REQUIREMENTS		14. CONCRETE CAST AGAINST AND PERMANENTLY IN CONTACT WITH GROUND		15. PROVIDE PRESERVATIVE PRESSURE TREATED WOOD AS INDICATED AND WHERE IN CONTACT WITH CONCRETE, MASONRY, OR EXPOSED TO EARTH OR WEATHER. AWPA U1 USING AMMONIACAL COPPER ZINC ARSENATE (ACZA), AMMONIACAL OR AMINE COPPER QUAT (ACQ), OR AMMONIACAL COPPER CITRATE (ACC). TREAT ALL WOOD PER AWPA STANDARD C-2 AS FOLLOWS:		16. STUDS SHALL BE DOUBLED AT ALL ANGLES, CORNERS, AND AROUND ALL OPENINGS.		17. 10. SEISMIC LOAD DESIGN PARAMETERS ARE AS FOLLOWS:	
14. CONCRETE EXPOSED TO WEATHER OR IN CONTACT WITH GROUND		15. # BAR AND SMALLER: 1-1/2"; # BAR AND LARGER: 2"		16. ABOVE GROUND USE: PROVIDE 0.25 POUND PER CUBIC FOOT OF WOOD BELOW GROUND USE: PROVIDE 0.40 POUND PER CUBIC FOOT OF WOOD		18. 11. NOTES:		19. 10. 1. END ZONE WIDTH IN FEET = 10% OF LEAST HORIZONTAL DIMENSION OR .4h WHICHEVER IS SMALLER BUT NOT LESS THAN EITHER, 4% OF LEAST HORIZONTAL DIMENSION OR 3'-0". h = MEAN ROOF HEIGHT, IN FEET, EXCEPT THAT EAVE HEIGHT SHALL BE USED FOR ROOF ANGLES < 10 DEGREES.	
15. CONCRETE NOT EXPOSED TO WEATHER OR IN CONTACT WITH GROUND		16. # SLABS, JOISTS, AND WALLS (NOT LARGER THAN #11 BAR) BEAMS, COLUMNS, PIERS: 3/4" 1-1/2"		17. 11. 1. CAST-IN-PLACE CONCRETE WORK SHALL CONFORM TO THE PROJECT MANUAL AND AMERICAN CONCRETE INSTITUTE CODES AND STANDARDS, INCLUDING, BUT NOT LIMITED TO, ACI 301, ACI 315, AND ACI 318.		20. 12. 1. CAST-IN-PLACE CONCRETE WORK SHALL CONFORM TO THE PROJECT MANUAL AND AMERICAN CONCRETE INSTITUTE CODES AND STANDARDS, INCLUDING, BUT NOT LIMITED TO, ACI 301, ACI 315, AND ACI 318.		21. 13. 1. SOIL SITE CLASS: C MAPELD SPECTRAL RESPONSE ACCELERATION: (S ₁) 20.5 % (S ₂) 10.7 % DESIGN SPECTRAL RESPONSE ACCELERATION: (S ₁) 16.4 % (S ₂) 12.1 % SEISMIC DESIGN CATEGORY: B SEISMIC IMPORTANCE FACTOR (I ₁) 1.0 SEISMIC LATERAL FORCE RESISTING SYSTEM - WOOD WALLS SHEATHED WITH WOOD STRUCTURAL PANEL RATED FOR SHEAR RESISTANCE RESPONSE MODIFICATION FACTOR (R) 6.5 DEFLECTION AMPLIFICATION FACTOR (C ₂) 4.0 SEISMIC DESIGN METHOD: EQUIVALENT LATERAL FORCE PROCEDURE SEISMIC RESPONSE COEFFICIENT (C ₃) 0.034 SEISMIC DESIGN STRUCTURE WEIGHT (W) 72.0 KIPS SEISMIC DESIGN BASE SHEAR (V) 2.4 KIPS	
16. CONCRETE REINFORCING CLEAR COVER REQUIREMENTS		17. 14. CONCRETE EXPOSED TO WEATHER OR IN CONTACT WITH GROUND		18. 15. 1. WHERE CONSTRUCTION JOINTS ARE REQUIRED BUT NOT INDICATED ON THE DRAWINGS, THEY SHALL BE LOCATED AT THE MID-SPAN OF BEAMS, SLABS AND WALLS, AND SHALL BE SUBJECT TO REVIEW BY THE A/E, UNO OR SHOWN ON THE DRAWINGS. PROVIDE A CONTINUOUS SHEAR KEY IN SLABS AND WALLS, AND A MINIMUM OF (2) CONTINUOUS HORIZONTAL KEYS IN BEAMS AND EACH JOIST. THE MINIMUM KEY SIZE SHALL BE 1-1/2" DEEP X 1/3 THE DEPTH OR WIDTH OF THE MEMBER.		19. 16. THE CONTRACTOR SHALL PROVIDE 3/4" CHAMERS ON ALL EXPOSED CORNERS OF COLUMNS, BEAMS, AND WALLS INDICATED ON THE ARCHITECTURAL DRAWINGS. MINIMUM CLEARANCES FOR REINFORCING STEEL SHALL CONFORM WITH THE TYPICAL REINFORCING BAR CLEARANCE TABLE.		20. 17. THE HARDENED CONCRETE OF HORIZONTAL CONSTRUCTION JOINTS SHALL BE DAMPENED AND THEN THOROUGHLY COVERED WITH A COAT OF CEMENT GROUT OR SIMILAR PROPORTIONS TO THE MORTAR IN THE CONCRETE. THE FRESH CONCRETE SHALL BE PLACED BEFORE THE GROUT HAS ATTAINED ITS INITIAL SET.	
17. CONCRETE EXPOSED TO WEATHER OR IN CONTACT WITH GROUND		18. # SLABS, JOISTS, AND WALLS (NOT LARGER THAN #11 BAR) BEAMS, COLUMNS, PIERS: 3/4" 1-1/2"		21. 18. THE CONTRACTOR SHALL PROVIDE 3/4" CHAMERS ON ALL EXPOSED CORNERS OF COLUMNS, BEAMS, AND WALLS INDICATED ON THE ARCHITECTURAL DRAWINGS. MINIMUM CLEARANCES FOR REINFORCING STEEL SHALL CONFORM WITH THE TYPICAL REINFORCING BAR CLEARANCE TABLE.		22. 19. 1. THE CONTRACTOR SHALL PROVIDE 3/4" CHAMERS ON ALL EXPOSED CORNERS OF COLUMNS, BEAMS, AND WALLS INDICATED ON THE ARCHITECTURAL DRAWINGS. MINIMUM CLEARANCES FOR REINFORCING STEEL SHALL CONFORM WITH THE TYPICAL REINFORCING BAR CLEARANCE TABLE.		23. 20. 1. THE HARDENED CONCRETE OF HORIZONTAL CONSTRUCTION JOINTS SHALL BE THOROUGHLY COATED WITH A BONDING AGENT (SKA ARMATEC 110 OR EQUAL).	
18. CONCRETE NOT EXPOSED TO WEATHER OR IN CONTACT WITH GROUND		19. # SLABS, JOISTS, AND WALLS (NOT LARGER THAN #11 BAR) BEAMS, COLUMNS, PIERS: 3/4" 1-1/2"		24. 21. 1. WELDING OF REINFORCING STEEL IS NOT PERMITTED.		25. 22. 1. COMPLY WITH THE ARCHITECTURAL DRAWINGS FOR LOCATION AND EXTENT OF SPECIAL FINISHES OR TREATMENTS TO EXPOSED CONCRETE.		26. 23. 1. PROVIDE 6X6-W1.4XW1.4 WELDED WIRE FABRIC IN ALL TOPPING SLABS, UNO.	
19. CONCRETE CAST AGAINST AND PERMANENTLY IN CONTACT WITH GROUND		20. # SLABS, JOISTS, AND WALLS (NOT LARGER THAN #11 BAR) BEAMS, COLUMNS, PIERS: 3/4" 1-1/2"		27. 24. 1. LAP WELDED WIRE FABRIC 1 1/2" (2 CROSS WIRE) + 2" AT ALL EDGES AND ENDS OF SHEETS.		28. 25. 1. REINFORCING BAR LAP SPLICES AND ANCHORAGE LENGTHS SHALL CONFORM WITH "MINIMUM LAP SPLICE AND ANCHORAGE DIMENSION TABLE"		29. 26. 1. WHERE METAL-PLATE-CONNECTED WOOD TRUSSES SPAN 60 FEET OR GREATER, VERIFY THAT THE TEMPORARY INSTALLATION RESTRAINT BRACING AND THE PERMANENT INDIVIDUAL TRUSS MEMBER RESTRAINT/BRACING ARE INSTALLED IN ACCORDANCE WITH THE APPROVED TRUSS SUBMITTAL PACKAGE.	
20. CONCRETE EXPOSED TO WEATHER OR IN CONTACT WITH GROUND		21. # SLABS, JOISTS, AND WALLS (NOT LARGER THAN #11 BAR) BEAMS, COLUMNS, PIERS: 3/4" 1-1/2"		30. 27. 1. WHERE METAL-PLATE-CONNECTED WOOD TRUSSES SPAN 60 FEET OR GREATER, VERIFY THAT THE TEMPORARY INSTALLATION RESTRAINT BRACING AND THE PERMANENT INDIVIDUAL TRUSS MEMBER RESTRAINT/BRACING ARE INSTALLED IN ACCORDANCE WITH THE APPROVED TRUSS SUBMITTAL PACKAGE.		31. 28. 1. WHERE METAL-PLATE-CONNECTED WOOD TRUSSES SPAN 60 FEET OR GREATER, VERIFY THAT THE TEMPORARY INSTALLATION RESTRAINT BRACING AND THE PERMANENT INDIVIDUAL TRUSS MEMBER RESTRAINT/BRACING ARE INSTALLED IN ACCORDANCE WITH THE APPROVED TRUSS SUBMITTAL PACKAGE.		32. 29. 1. WHERE METAL-PLATE-CONNECTED WOOD TRUSSES SPAN 60 FEET OR GREATER, VERIFY THAT THE TEMPORARY INSTALLATION RESTRAINT BRACING AND THE PERMANENT INDIVIDUAL TRUSS MEMBER RESTRAINT/BRACING ARE INSTALLED IN ACCORDANCE WITH THE APPROVED TRUSS SUBMITTAL PACKAGE.	
21. CONCRETE NOT EXPOSED TO WEATHER OR IN CONTACT WITH GROUND		22. # SLABS, JOISTS, AND WALLS (NOT LARGER THAN #11 BAR) BEAMS, COLUMNS, PIERS: 3/4" 1-1/2"		33. 30. 1. WHERE METAL-PLATE-CONNECTED WOOD TRUSSES SPAN 60 FEET OR GREATER, VERIFY THAT THE TEMPORARY INSTALLATION RESTRAINT BRACING AND THE PERMANENT INDIVIDUAL TRUSS MEMBER RESTRAINT/BRACING ARE INSTALLED IN ACCORDANCE WITH THE APPROVED TRUSS SUBMITTAL PACKAGE.		34. 31. 1. WHERE METAL-PLATE-CONNECTED WOOD TRUSSES SPAN 60 FEET OR GREATER, VERIFY THAT THE TEMPORARY INSTALLATION RESTRAINT BRACING AND THE PERMANENT INDIVIDUAL TRUSS MEMBER RESTRAINT/BRACING ARE INSTALLED IN ACCORDANCE WITH THE APPROVED TRUSS SUBMITTAL PACKAGE.		35. 32. 1. WHERE METAL-PLATE-CONNECTED WOOD TRUSSES SPAN 60 FEET OR GREATER, VERIFY THAT THE TEMPORARY INSTALLATION RESTRAINT BRACING AND THE PERMANENT INDIVIDUAL TRUSS MEMBER RESTRAINT/BRACING ARE INSTALLED IN ACCORDANCE WITH THE APPROVED TRUSS SUBMITTAL PACKAGE.	
22. CONCRETE CAST AGAINST AND PERMANENTLY IN CONTACT WITH GROUND		23. # SLABS, JOISTS, AND WALLS (NOT LARGER THAN #11 BAR) BEAMS, COLUMNS, PIERS: 3/4" 1-1/2"		36. 33. 1. WHERE METAL-PLATE-CONNECTED WOOD TRUSSES SPAN 60 FEET OR GREATER, VERIFY THAT THE TEMPORARY INSTALLATION RESTRAINT BRACING AND THE PERMANENT INDIVIDUAL TRUSS MEMBER RESTRAINT/BRACING ARE INSTALLED IN ACCORDANCE WITH THE APPROVED TRUSS SUBMITTAL PACKAGE.		37. 34. 1. WHERE METAL-PLATE-CONNECTED WOOD TRUSSES SPAN 60 FEET OR GREATER, VERIFY THAT THE TEMPORARY INSTALLATION RESTRAINT BRACING AND THE PERMANENT INDIVIDUAL TRUSS MEMBER RESTRAINT/BRACING ARE INSTALLED IN ACCORDANCE WITH THE APPROVED TRUSS SUBMITTAL PACKAGE.		38. 35. 1. WHERE METAL-PLATE-CONNECTED WOOD TRUSSES SPAN 60 FEET OR GREATER, VERIFY THAT THE TEMPORARY INSTALLATION RESTRAINT BRACING AND THE PERMANENT INDIVIDUAL TRUSS MEMBER RESTRAINT/BRACING ARE INSTALLED IN ACCORDANCE WITH THE APPROVED TRUSS SUBMITTAL PACKAGE.	
23. CONCRETE EXPOSED TO WEATHER OR IN CONTACT WITH GROUND		24. # SLABS, JOISTS, AND WALLS (NOT LARGER THAN #11 BAR) BEAMS, COLUMNS, PIERS: 3/4" 1-1/2"		39. 36. 1. WHERE METAL-PLATE-CONNECTED WOOD TRUSSES SPAN 60 FEET OR GREATER, VERIFY THAT THE TEMPORARY INSTALLATION RESTRAINT BRACING AND THE PERMANENT INDIVIDUAL TRUSS MEMBER RESTRAINT/BRACING ARE INSTALLED IN ACCORDANCE WITH THE APPROVED TRUSS SUBMITTAL PACKAGE.		40. 37. 1. WHERE METAL-PLATE-CONNECTED WOOD TRUSSES SPAN 60 FEET OR GREATER, VERIFY THAT THE TEMPORARY INSTALLATION RESTRAINT BRACING AND THE PERMANENT INDIVIDUAL TRUSS MEMBER RESTRAINT/BRACING ARE INSTALLED IN ACCORDANCE WITH THE APPROVED TRUSS SUBMITTAL PACKAGE.		41. 38. 1. WHERE METAL-PLATE-CONNECTED WOOD TRUSSES SPAN 60 FEET OR GREATER, VERIFY THAT THE TEMPORARY INSTALLATION RESTRAINT BRACING AND THE PERMANENT INDIVIDUAL TRUSS MEMBER RESTRAINT/BRACING ARE INSTALLED IN ACCORDANCE WITH THE APPROVED TRUSS SUBMITTAL PACKAGE.	
24. CONCRETE NOT EXPOSED TO WEATHER OR IN CONTACT WITH GROUND		25. # SLABS, JOISTS, AND WALLS (NOT LARGER THAN #11 BAR) BEAMS, COLUMNS, PIERS: 3/4" 1-1/2"		42. 39. 1. WHERE METAL-PLATE-CONNECTED WOOD TRUSSES SPAN 60 FEET OR GREATER, VERIFY THAT THE TEMPORARY INSTALLATION RESTRAINT BRACING AND THE PERMANENT INDIVIDUAL TRUSS MEMBER RESTRAINT/BRACING ARE INSTALLED IN ACCORDANCE WITH THE APPROVED TRUSS SUBMITTAL PACKAGE.		43. 40. 1. WHERE METAL-PLATE-CONNECTED WOOD TRUSSES SPAN 60 FEET OR GREATER, VERIFY THAT THE TEMPORARY INSTALLATION RESTRAINT BRACING AND THE PERMANENT INDIVIDUAL TRUSS MEMBER RESTRAINT/BRACING ARE INSTALLED IN ACCORDANCE WITH THE APPROVED TRUSS SUBMITTAL PACKAGE.		44. 41. 1. WHERE METAL-PLATE-CONNECTED WOOD TRUSSES SPAN 60 FEET OR GREATER, VERIFY THAT THE TEMPORARY INSTALLATION RESTRAINT BRACING AND THE PERMANENT INDIVIDUAL TRUSS MEMBER RESTRAINT/BRACING ARE INSTALLED IN ACCORDANCE WITH THE APPROVED TRUSS SUBMITTAL PACKAGE.	
25. CONCRETE CAST AGAINST AND PERMANENTLY IN CONTACT WITH GROUND		26. # SLABS, JOISTS, AND WALLS (NOT LARGER THAN #11 BAR) BEAMS, COLUMNS, PIERS: 3/4" 1-1/2"		45. 42. 1. WHERE METAL-PLATE-CONNECTED WOOD TRUSSES SPAN 60 FEET OR GREATER, VERIFY THAT THE TEMPORARY INSTALLATION RESTRAINT BRACING AND THE PERMANENT INDIVIDUAL TRUSS MEMBER RESTRAINT/BRACING ARE INSTALLED IN ACCORDANCE WITH THE APPROVED TRUSS SUBMITTAL PACKAGE.		46. 43. 1. WHERE METAL-PLATE-CONNECTED WOOD TRUSSES SPAN 60 FEET OR GREATER, VERIFY THAT THE TEMPORARY INSTALLATION RESTRAINT BRACING AND THE PERMANENT INDIVIDUAL TRUSS MEMBER RESTRAINT/BRACING ARE INSTALLED IN ACCORDANCE WITH THE APPROVED TRUSS SUBMITTAL PACKAGE.		47. 44. 1. WHERE METAL-PLATE-CONNECTED WOOD TRUSSES SPAN 60 FEET OR GREATER, VERIFY THAT THE TEMPORARY INSTALLATION RESTRAINT BRACING AND THE PERMANENT INDIVIDUAL TRUSS MEMBER RESTRAINT/BRACING ARE INSTALLED IN ACCORDANCE WITH THE APPROVED TRUSS SUBMITTAL PACKAGE.	
26. CONCRETE EXPOSED TO WEATHER OR IN CONTACT WITH GROUND		27. # SLABS, JOISTS, AND WALLS (NOT LARGER THAN #11 BAR) BEAMS, COLUMNS, PIERS: 3/4" 1-1/2"		48. 45. 1. WHERE METAL-PLATE-CONNECTED WOOD TRUSSES SPAN 60 FEET OR GREATER, VERIFY THAT THE TEMPORARY INSTALLATION RESTRAINT BRACING AND THE PERMANENT INDIVIDUAL TRUSS MEMBER RESTRAINT/BRACING ARE INSTALLED IN ACCORDANCE WITH THE APPROVED TRUSS SUBMITTAL PACKAGE.		49. 46. 1. WHERE METAL-PLATE-CONNECTED WOOD TRUSSES SPAN 60 FEET OR GREATER, VERIFY THAT THE TEMPORARY INSTALLATION RESTRAINT BRACING AND THE PERMANENT INDIVIDUAL TRUSS MEMBER RESTRAINT/BRACING ARE INSTALLED IN ACCORDANCE WITH THE APPROVED TRUSS SUBMITTAL PACKAGE.		50. 47. 1. WHERE METAL-PLATE-CONNECTED WOOD TRUSSES SPAN 60 FEET OR GREATER, VERIFY THAT THE TEMPORARY INSTALLATION RESTRAINT BRACING AND THE PERMANENT INDIVIDUAL TRUSS MEMBER RESTRAINT/BRACING ARE INSTALLED IN ACCORDANCE WITH THE APPROVED TRUSS SUBMITTAL PACKAGE.	
27. CONCRETE NOT EXPOSED TO WEATHER									



DATE: 01/08/2006
EXPIRES: 06/30/2007

PROJECT TITLE
TEAMSTERS LOCAL 2727


OWNER
TEAMSTERS LOCAL 2727

SHEET TITLE
TYPICAL STRUCTURAL DETAILS


SHEET NUMBER
SG 002
25-376.000

DATE
JANUARY 9, 2006


4810 N Preston Hwy
Sheppardsville, KY

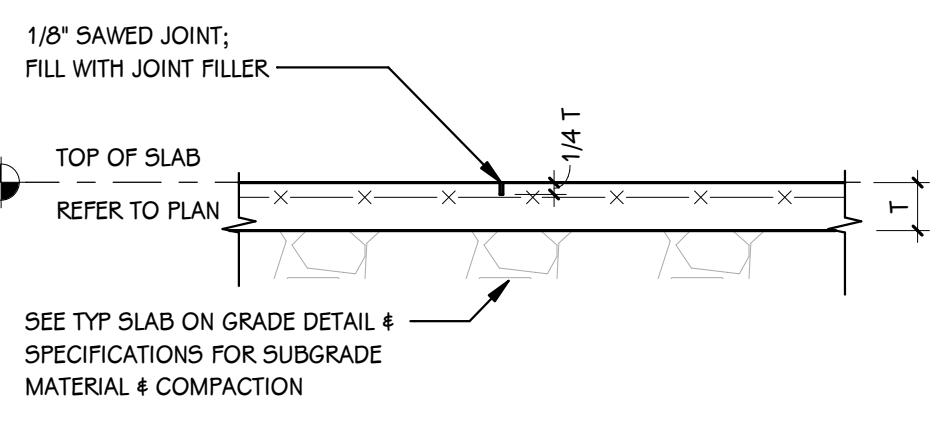


1 TYPICAL SOG CONTROL JOINT

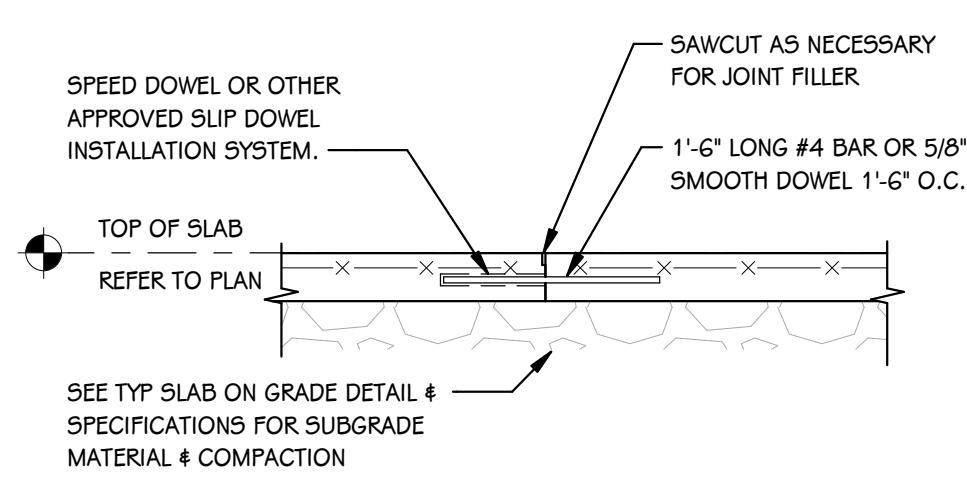


2 TYPICAL SOG CONSTRUCTION JOINT

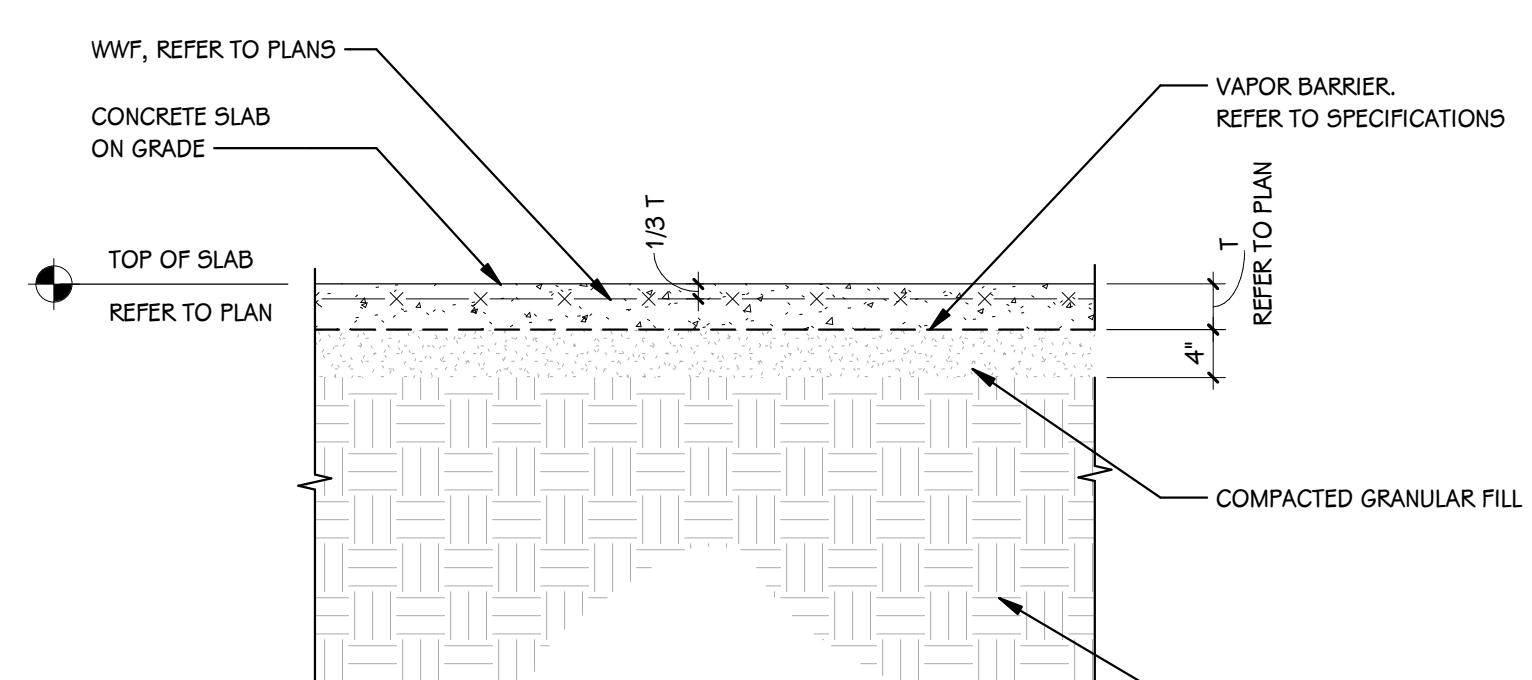


7 TYPICAL SLAB ON GRADE CONSTRUCTION

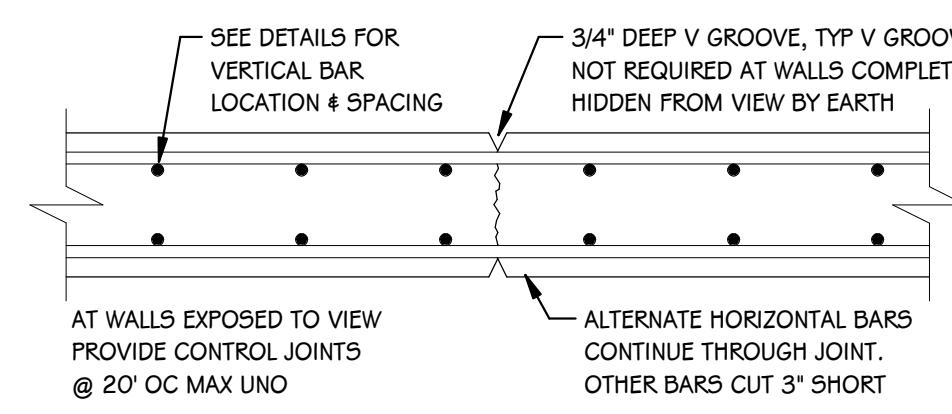


3 TYPICAL WALL CONTROL JOINT

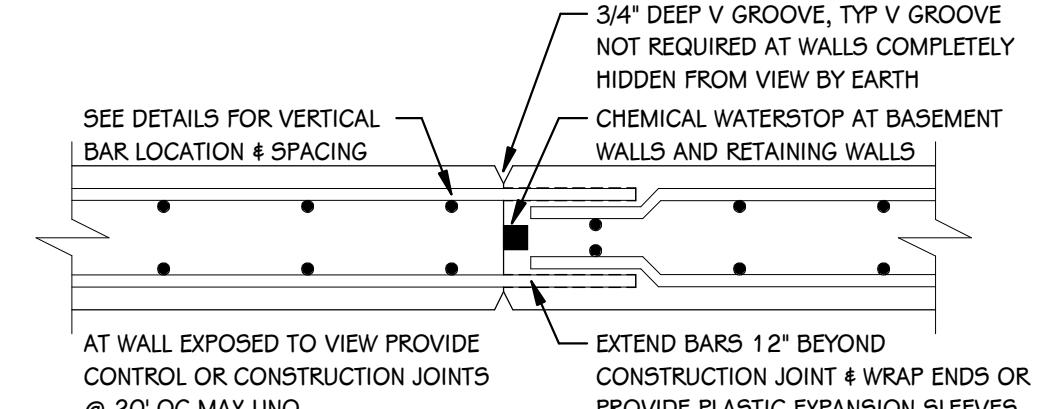


4 TYPICAL WALL CONSTRUCTION JOINT

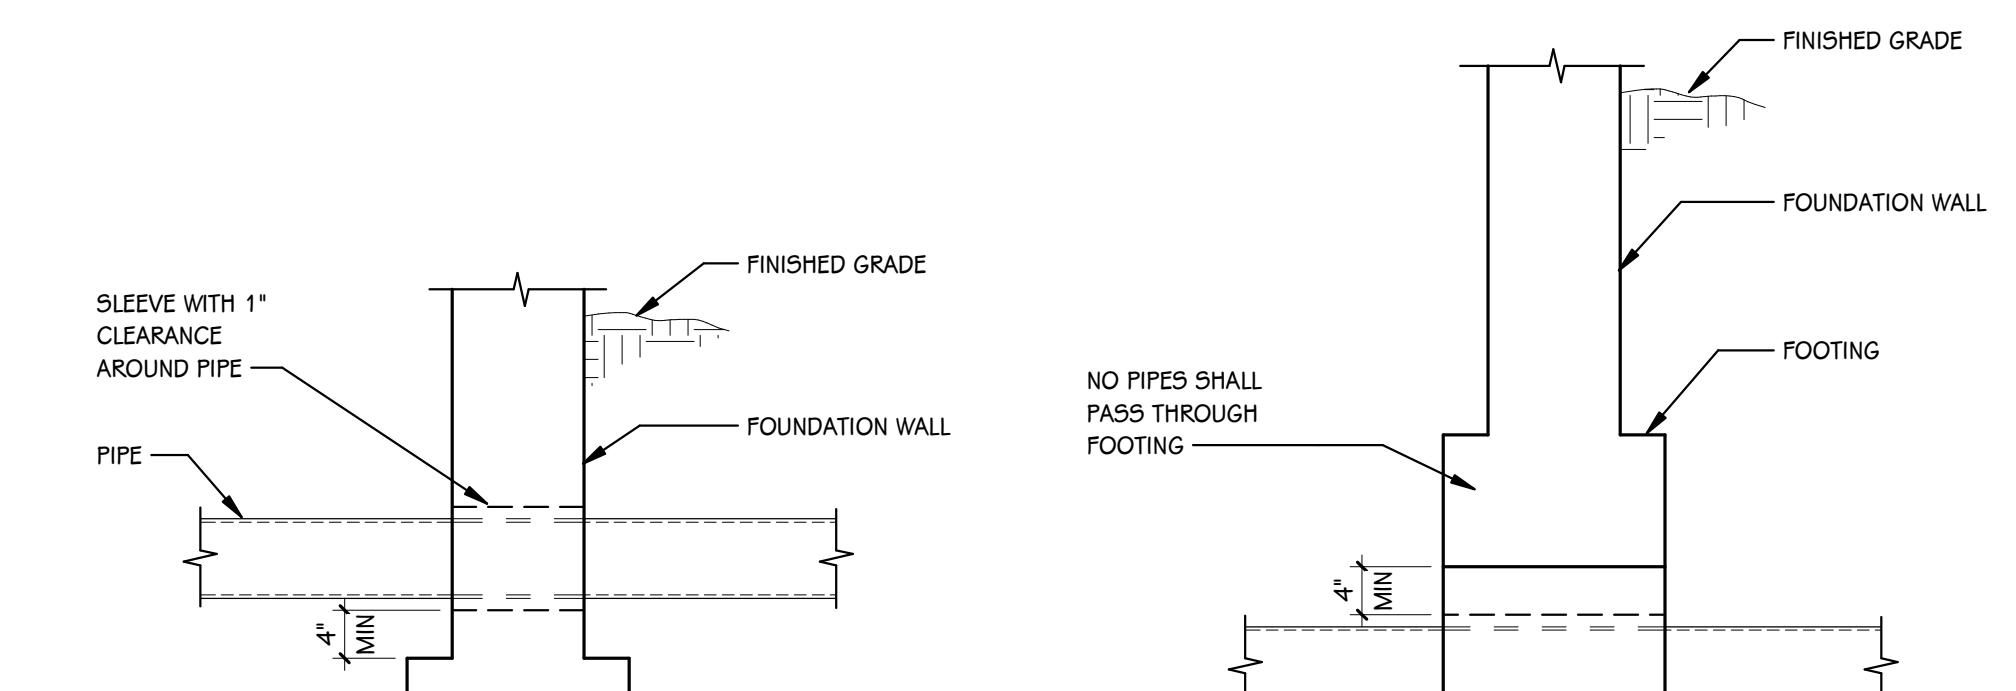


6 TYPICAL FOUNDATION PLUMBING PENETRATIONS

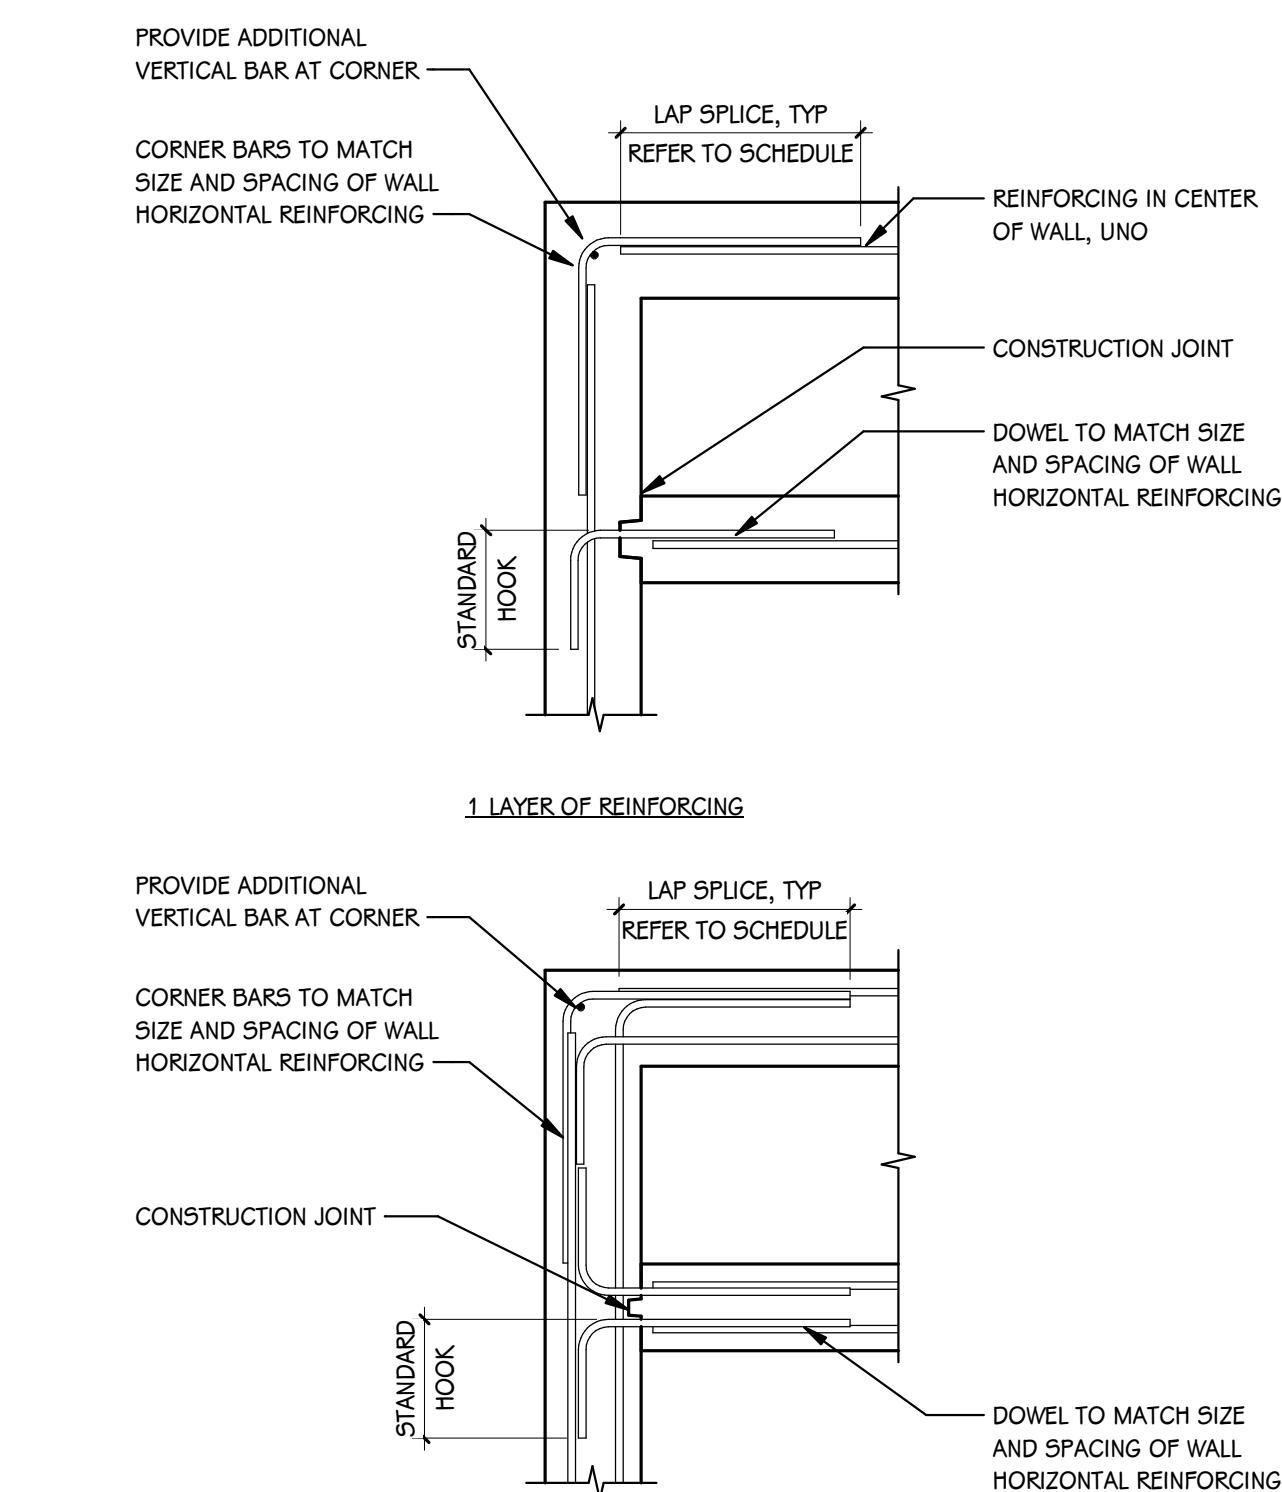


5 TYPICAL CONCRETE WALL CORNER DETAILS

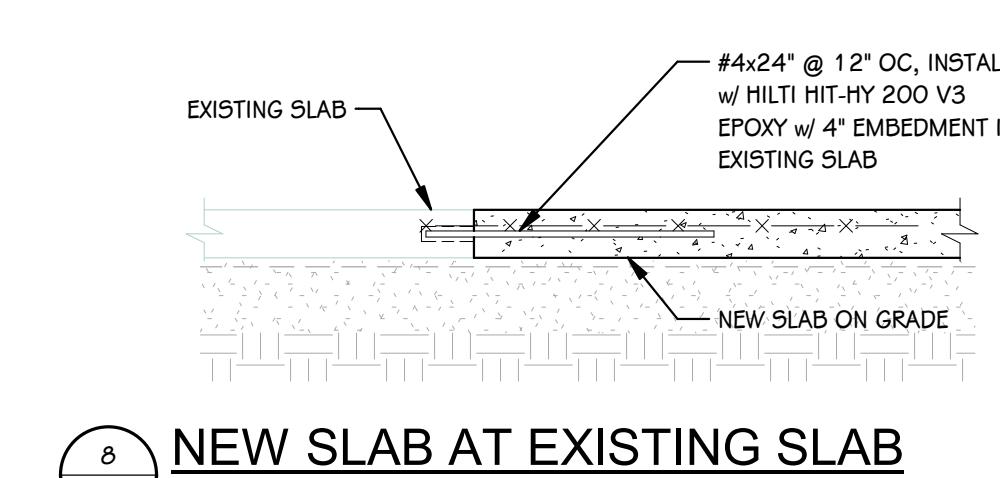


8 NEW SLAB AT EXISTING SLAB

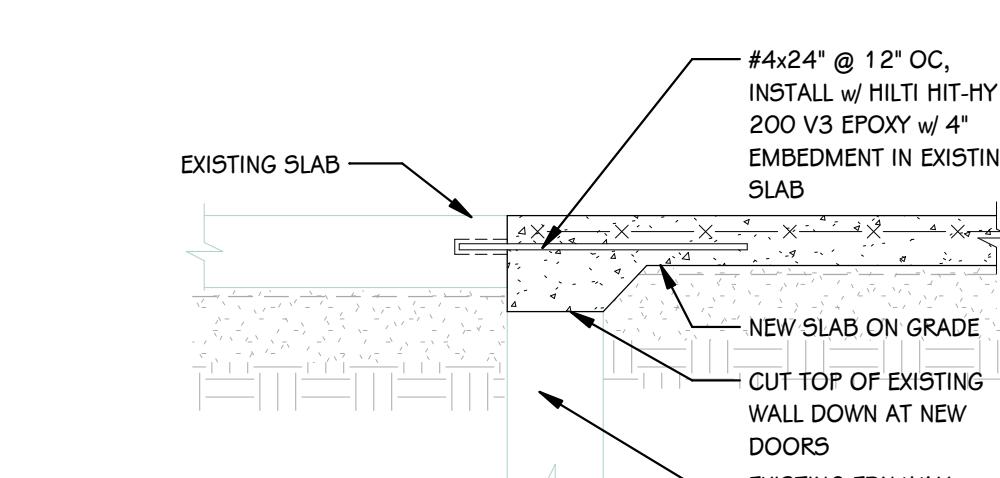


9 TYPICAL DOORWAY SLAB

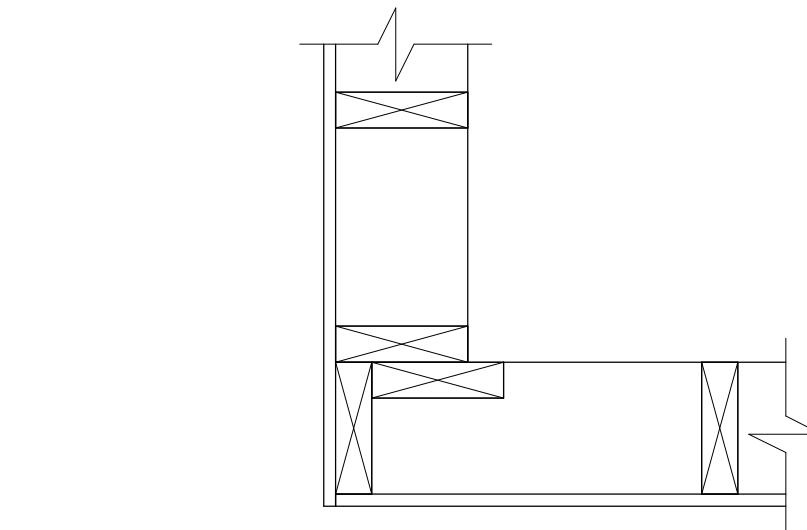


10 STUD WALL CORNER FRAMING

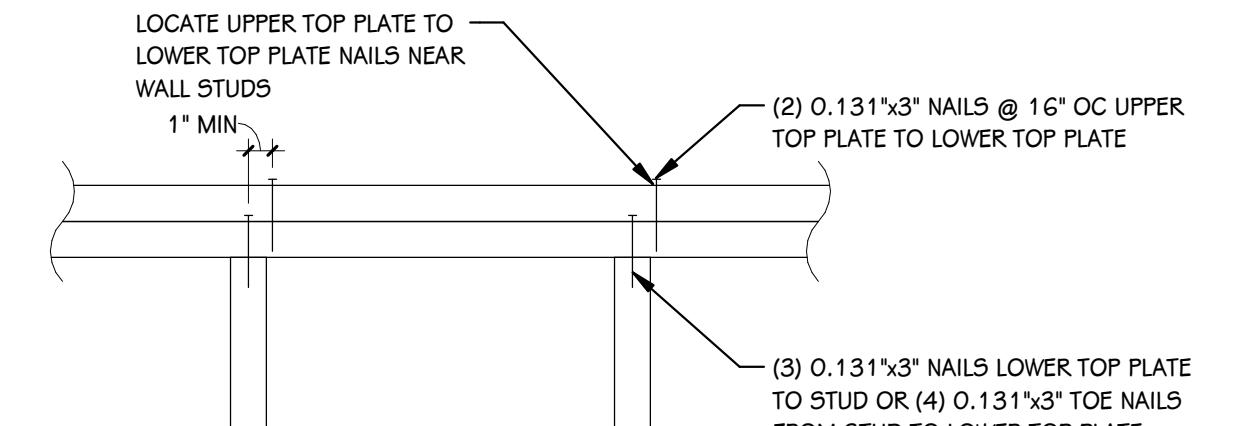


11 STUD WALL DOUBLE TOP PLATE NAILING

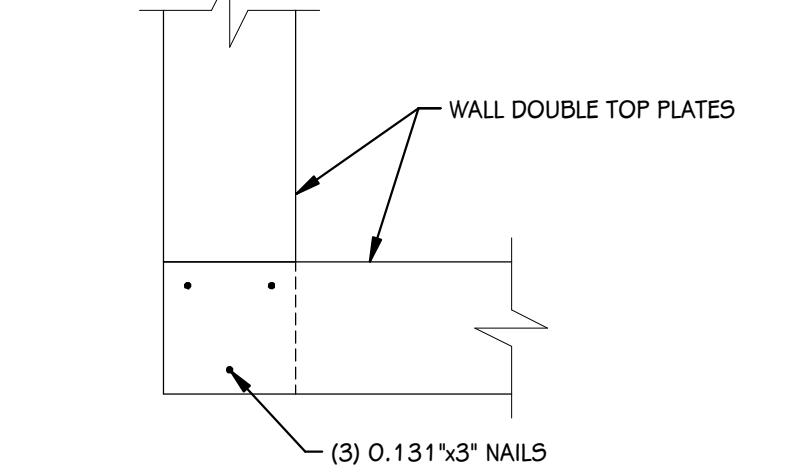


12 STUD WALL DOUBLE TOP PLATE LAP

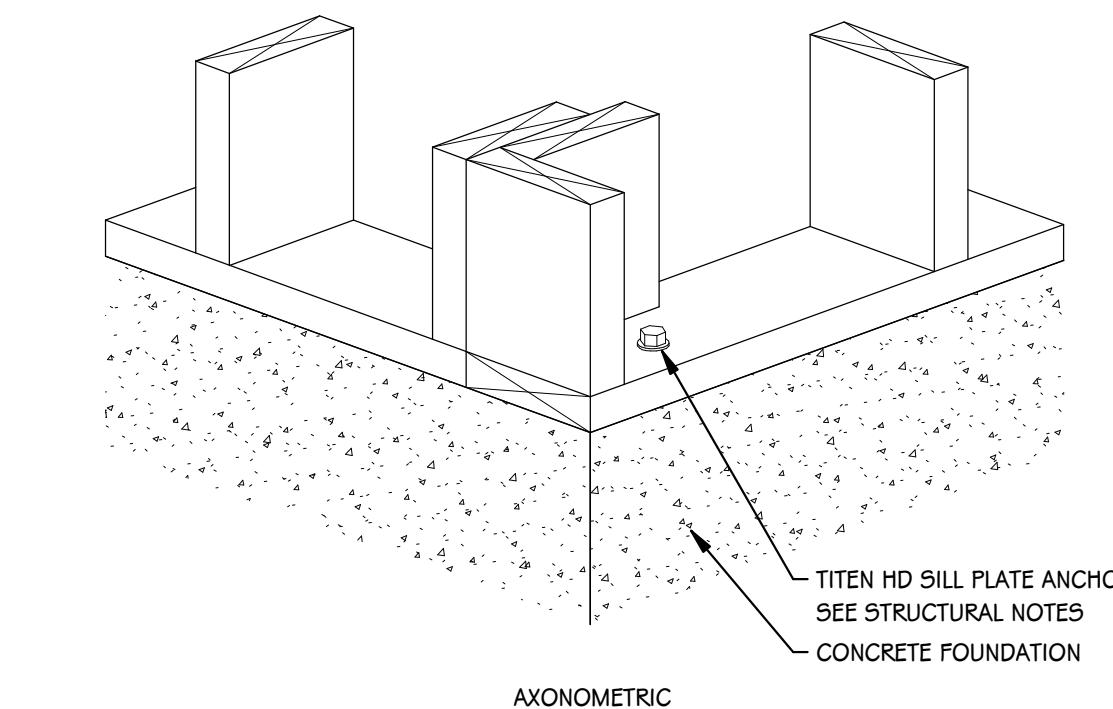




10 STUD WALL CORNER FRAMING

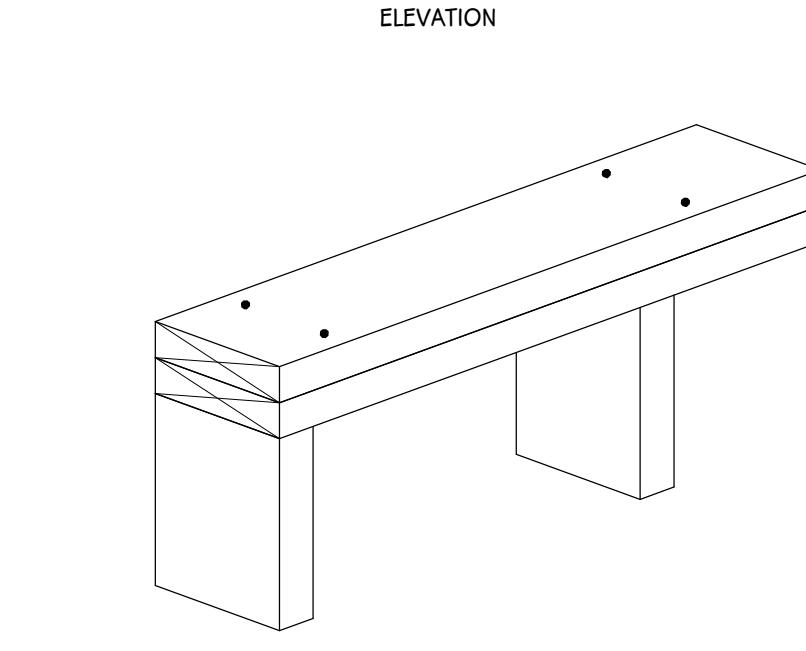


11 STUD WALL DOUBLE TOP PLATE NAILING

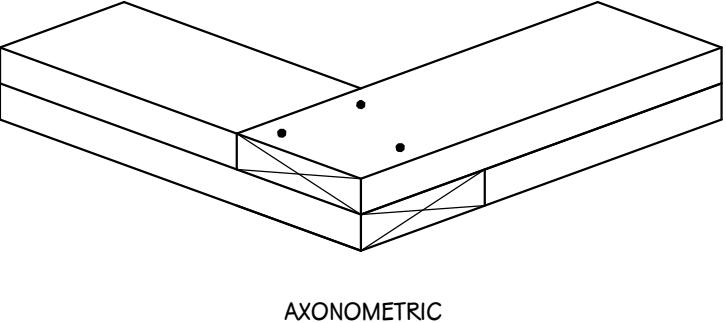


12 STUD WALL DOUBLE TOP PLATE LAP

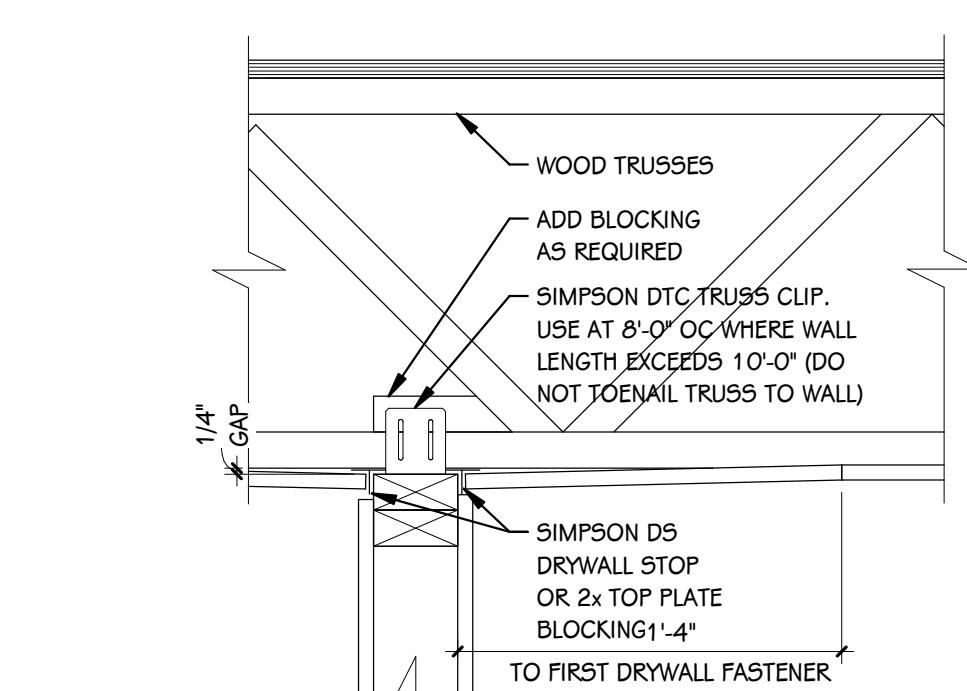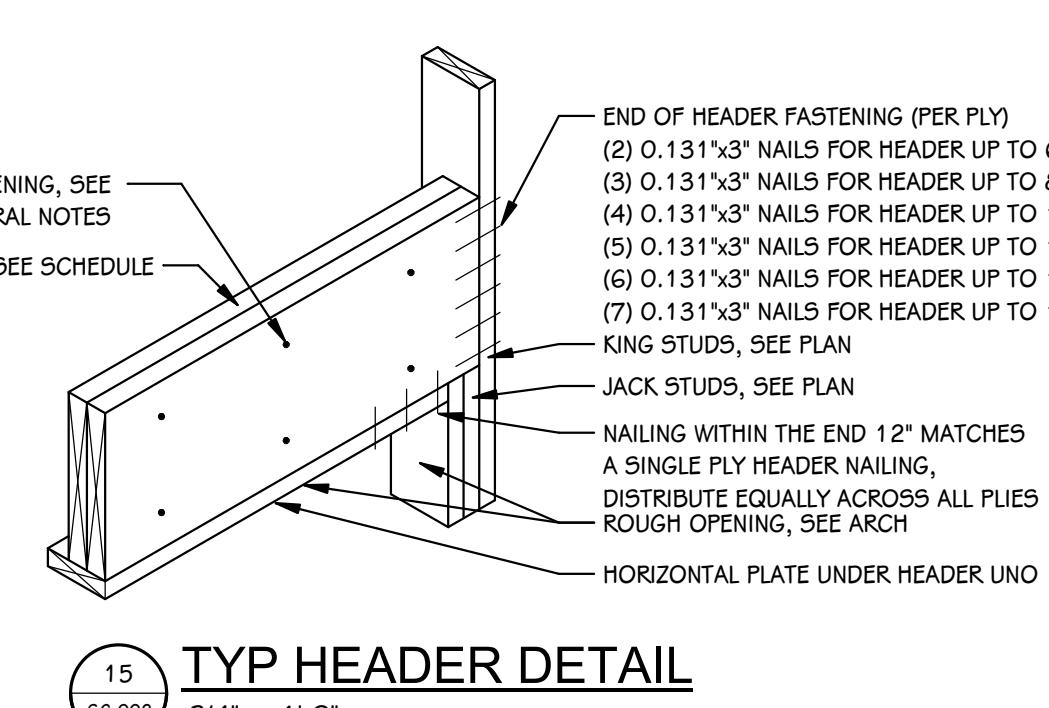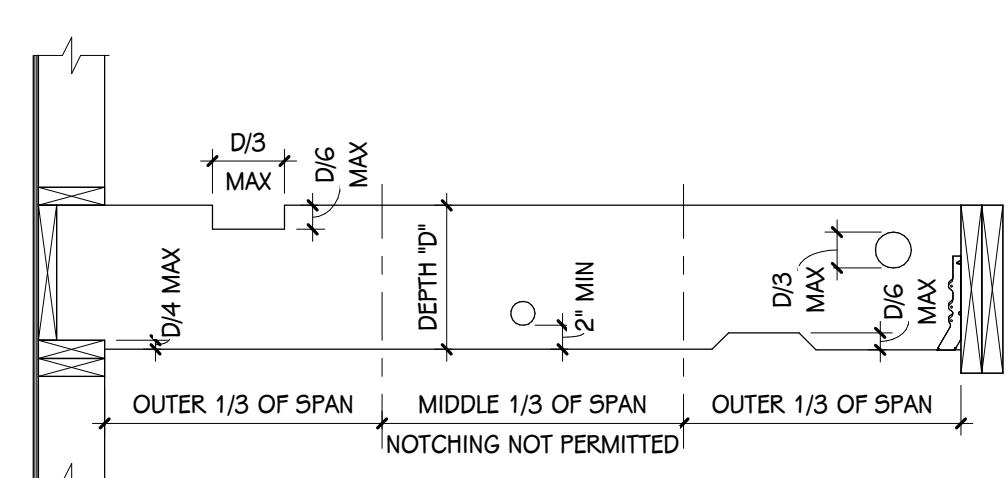


16 INTERIOR NON-BEARING WALL

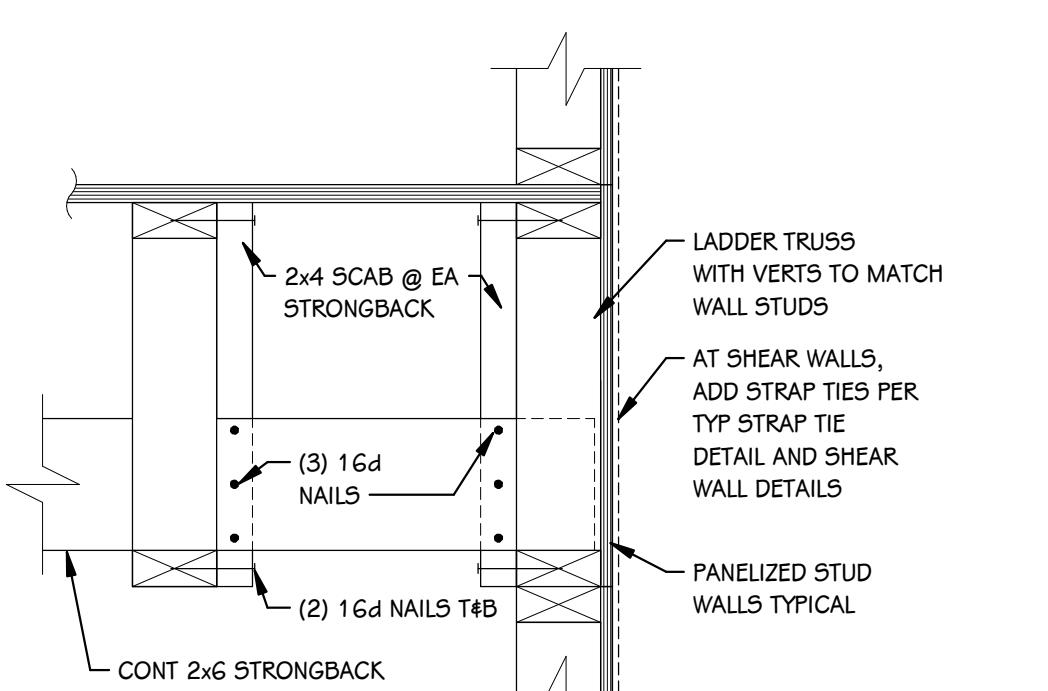


17 STRONGBACK DETAIL

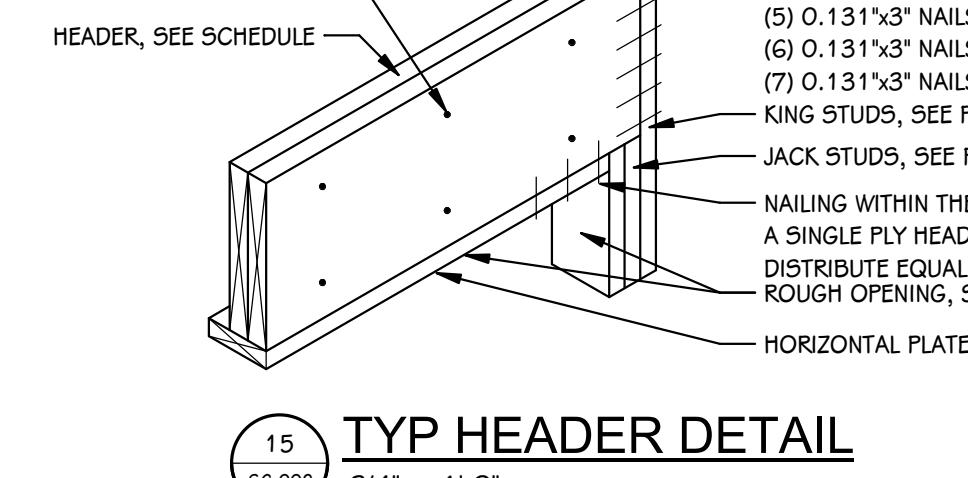


15 TYPICAL HEADER DETAIL

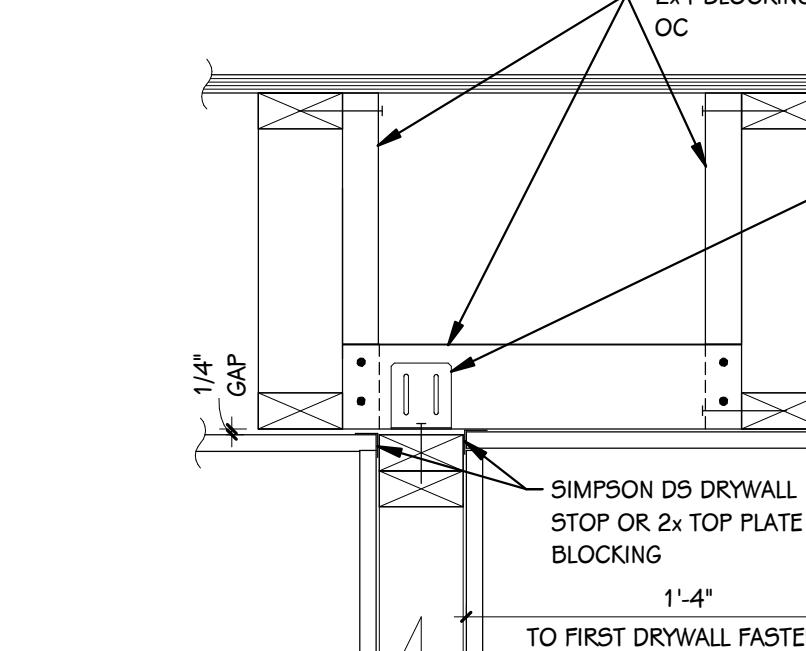


FLOOR TRUSS

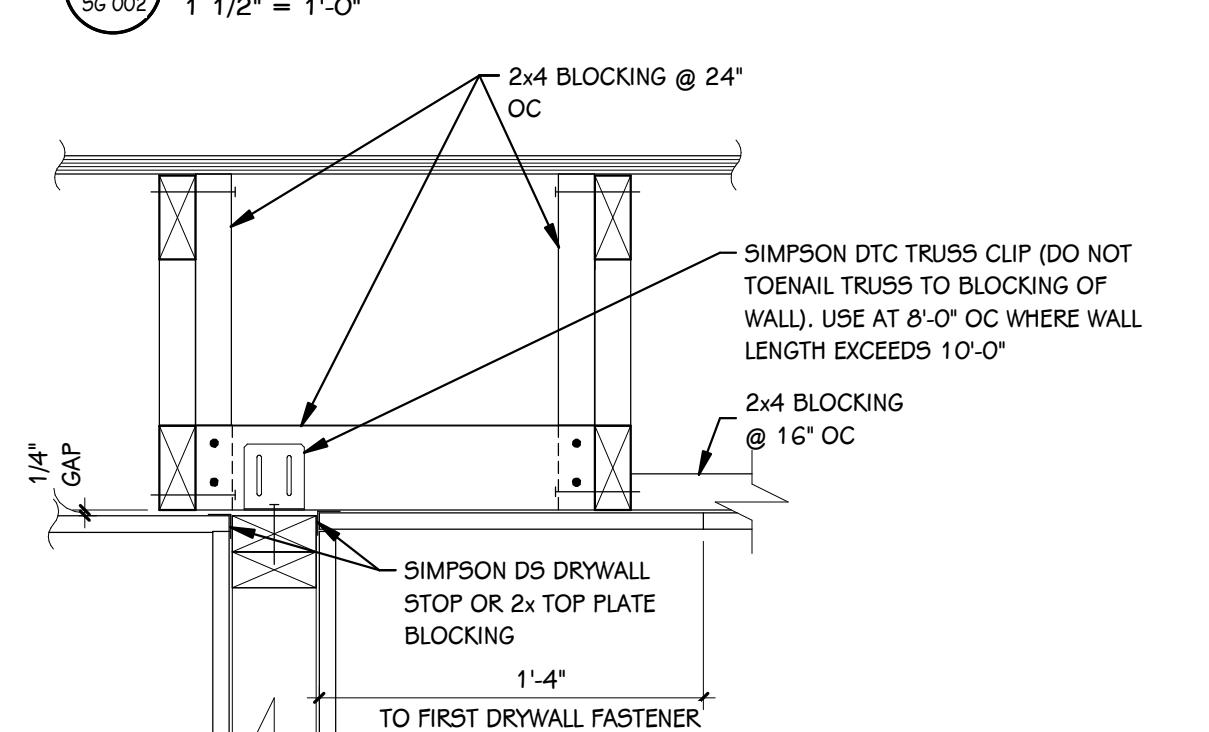


19 INTERIOR NON-BEARING WALL

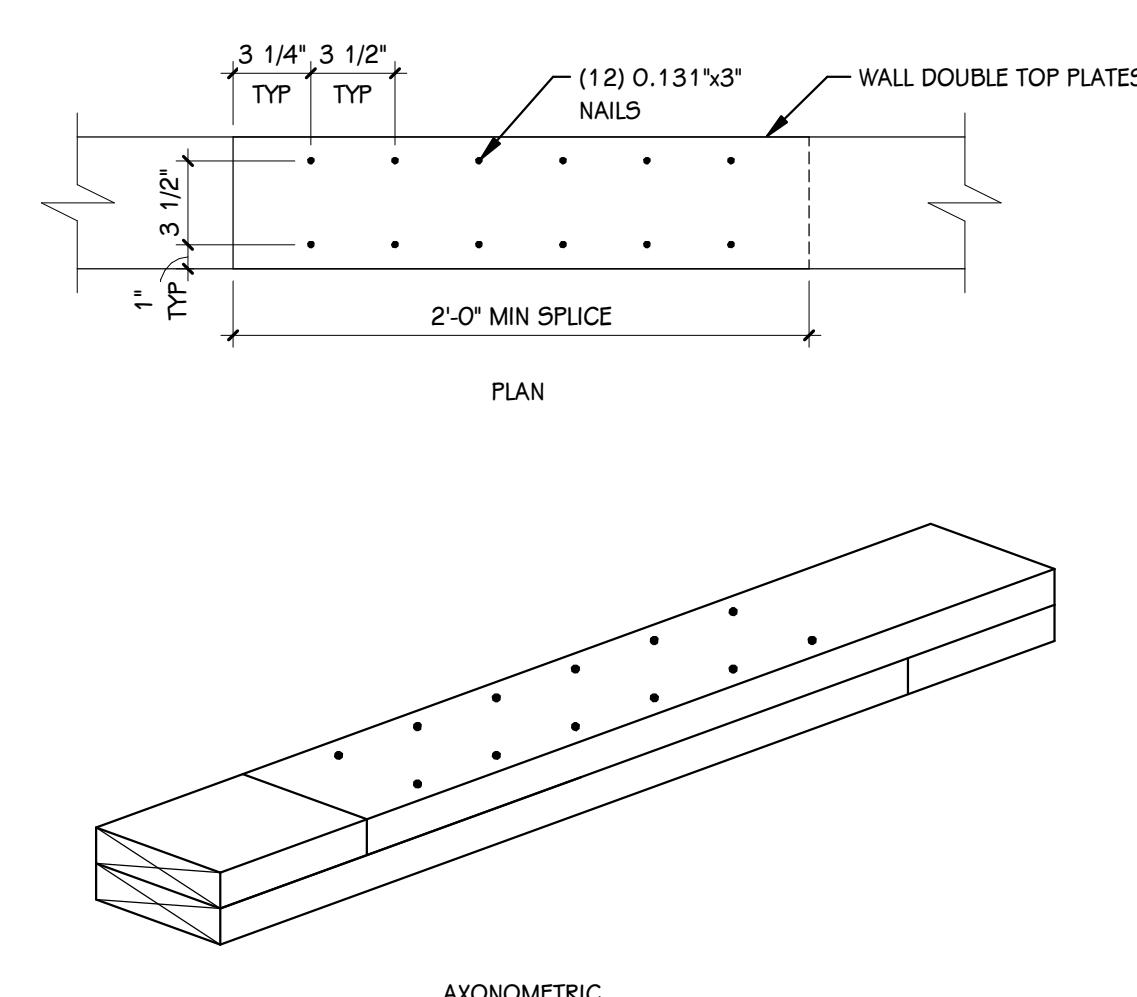


13 STUD WALL DOUBLE TOP PLATE SPLICE

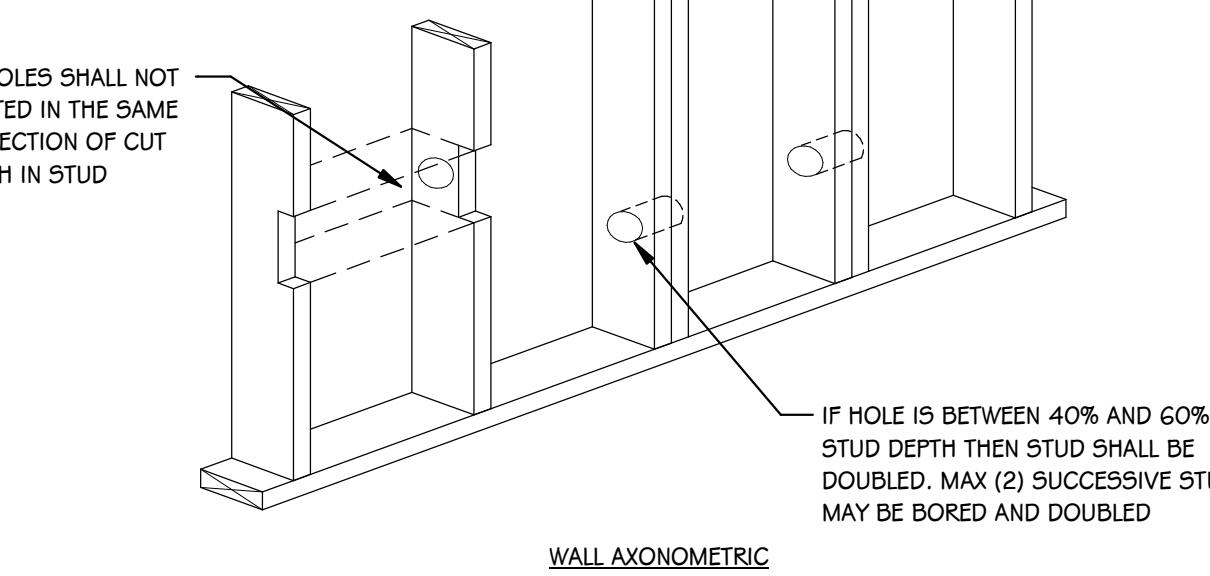


14 NOTCHING AND BORED HOLE LIMITS

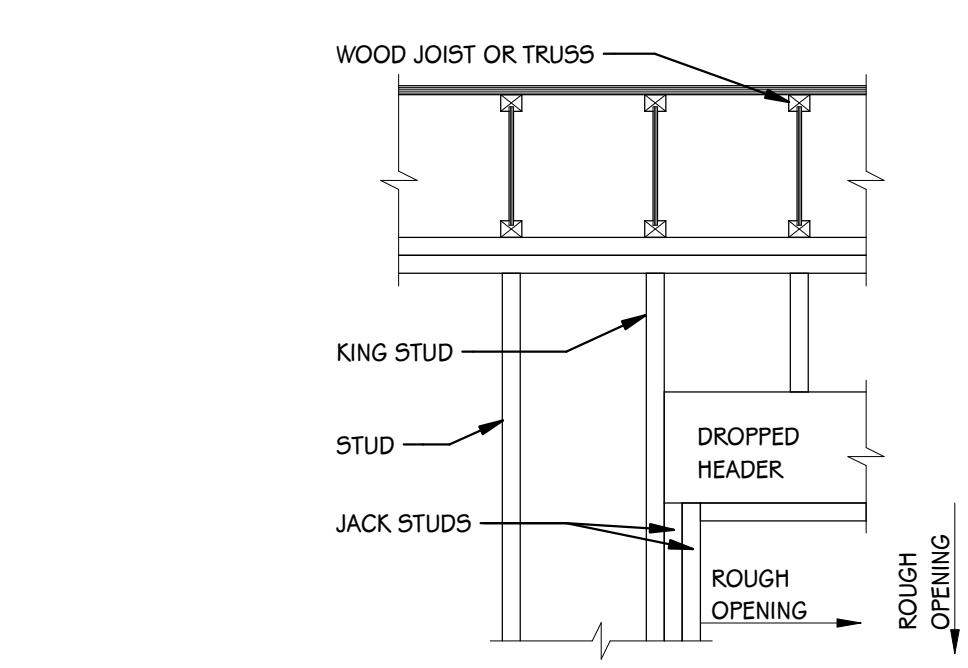


18 TYPICAL DROPPED HEADER

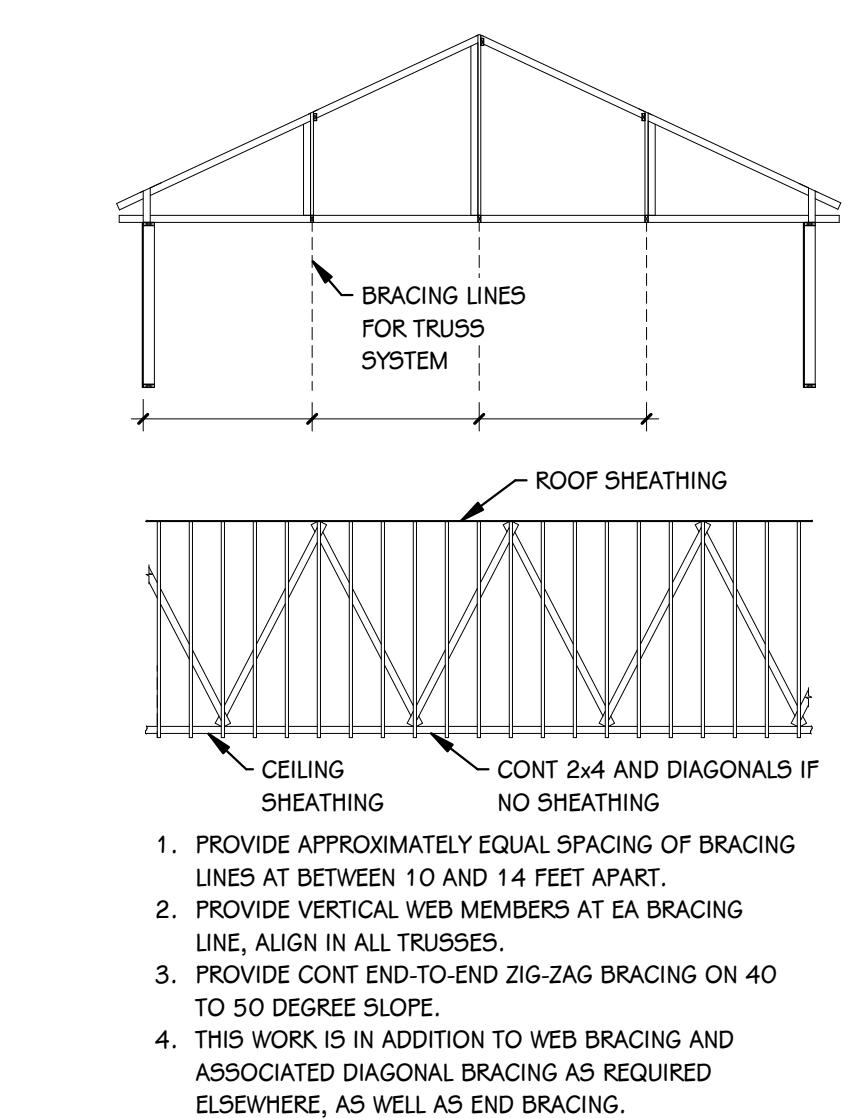


TYP WOOD TRUSS BRACING

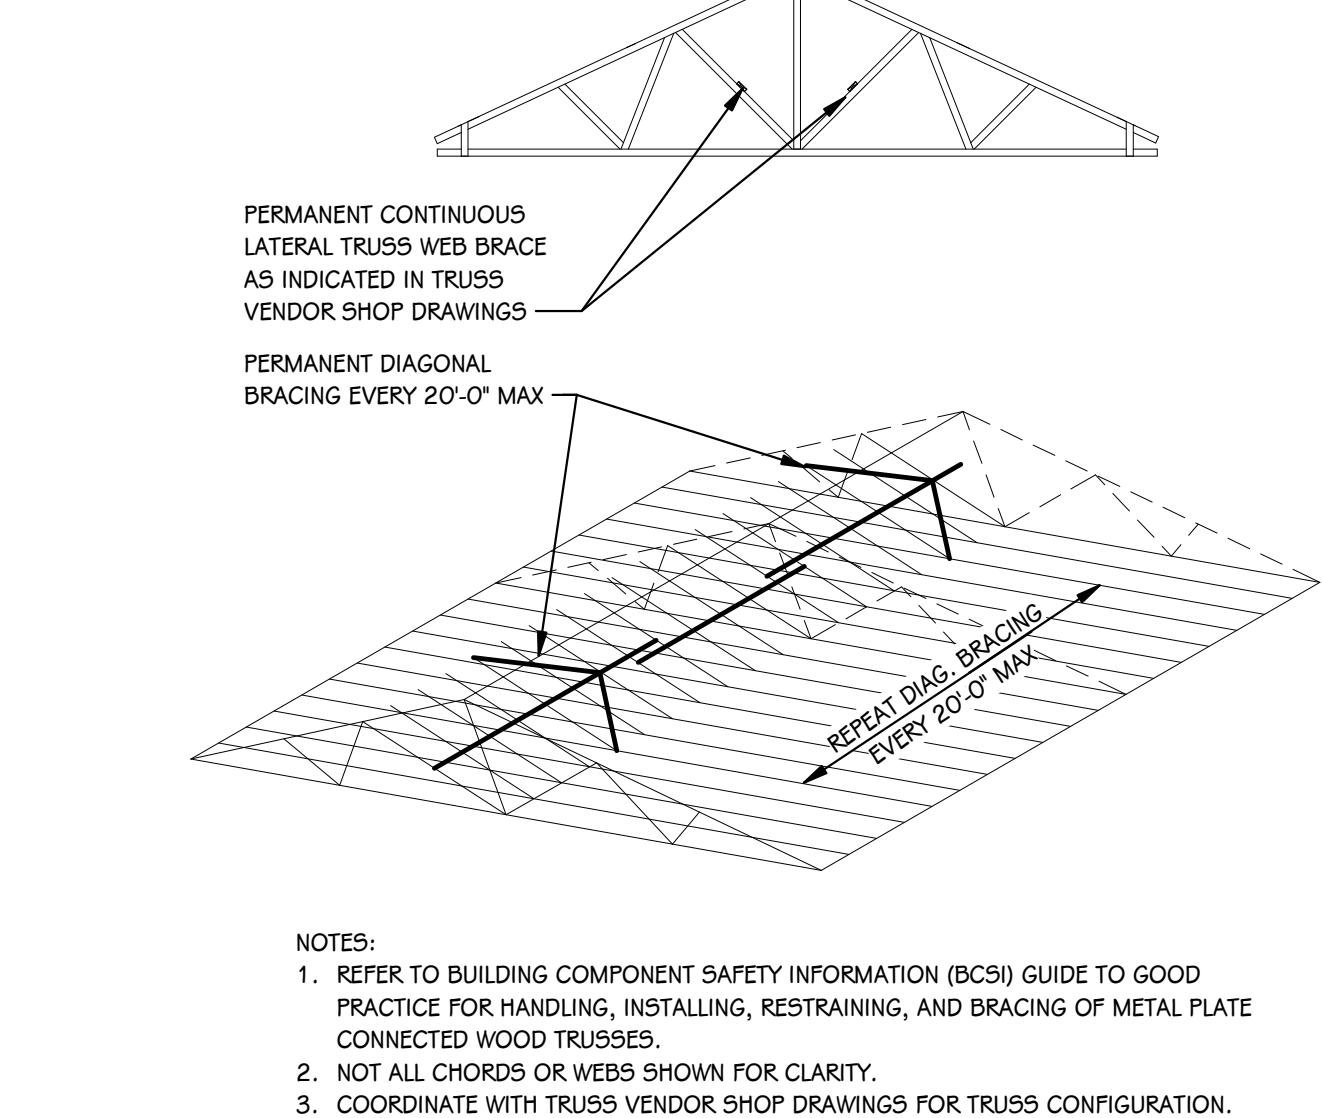


TYP PERMANENT CONTINUOUS LATERAL TRUSS WEB BRACING

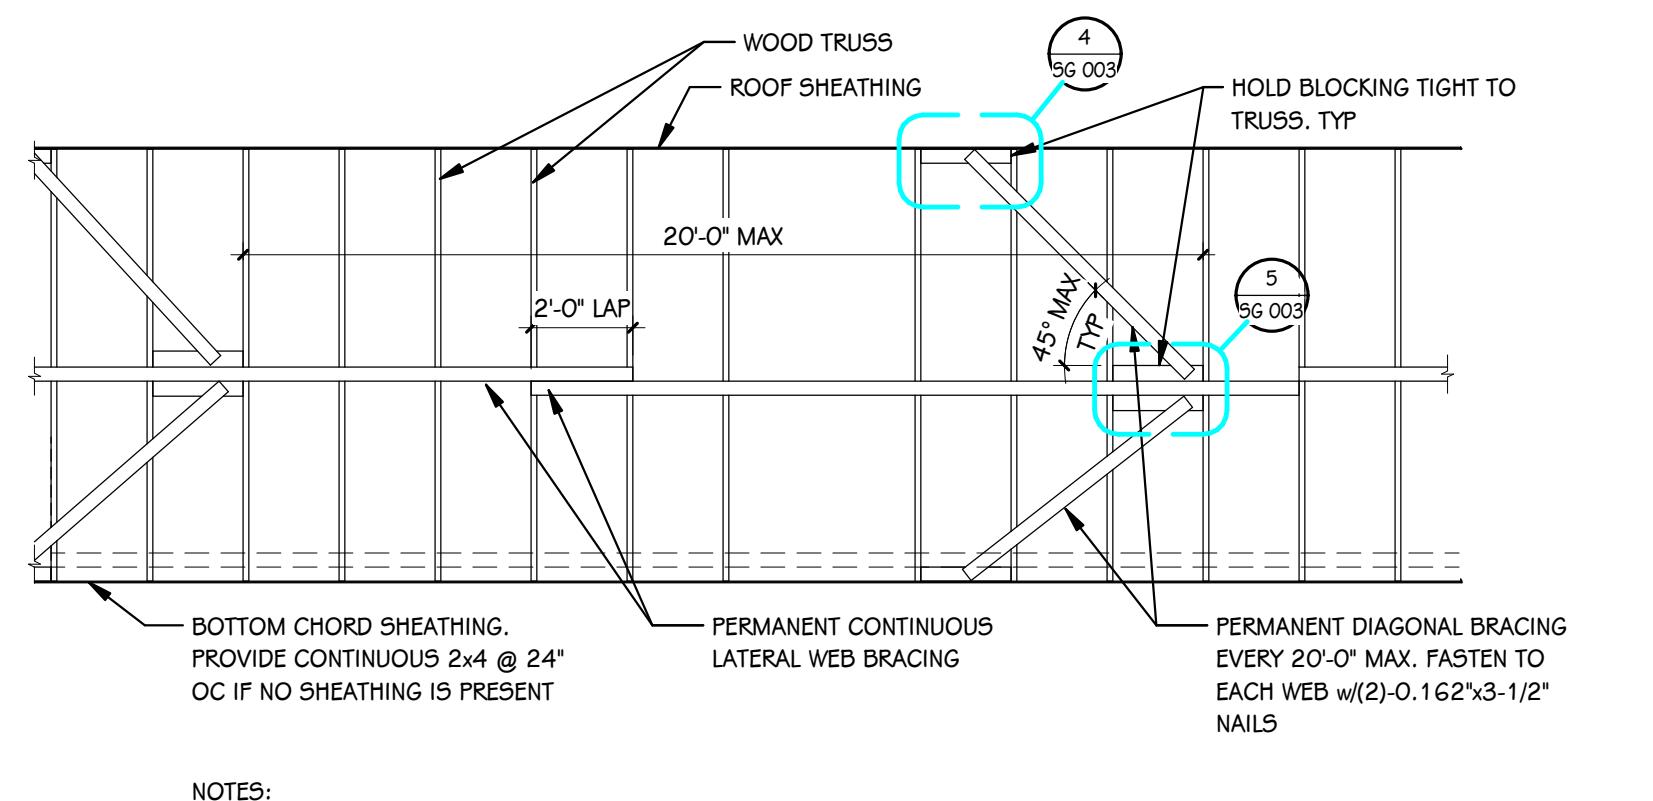


TYP PERMANENT CONTINUOUS LATERAL TRUSS WEB BRACING DETAIL

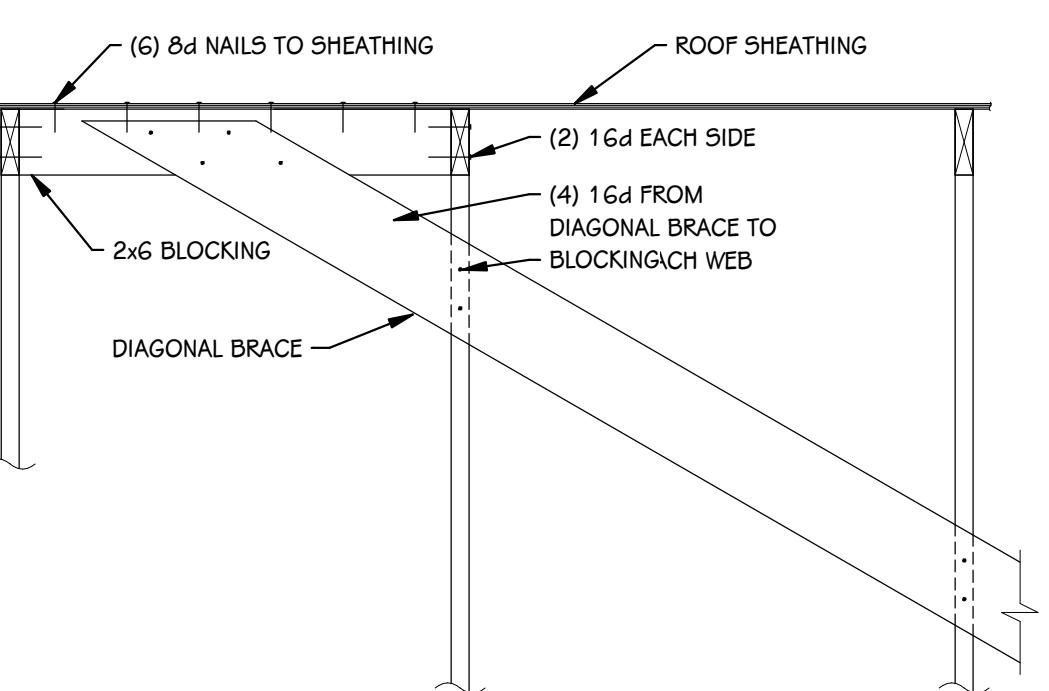


BLOCKING DETAIL 'A'

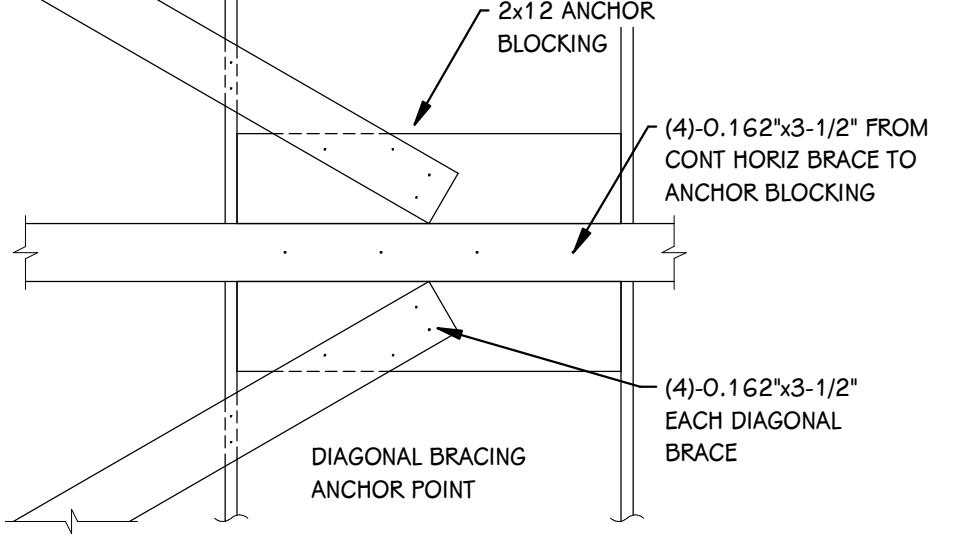

BLOCKING DETAIL 'B'

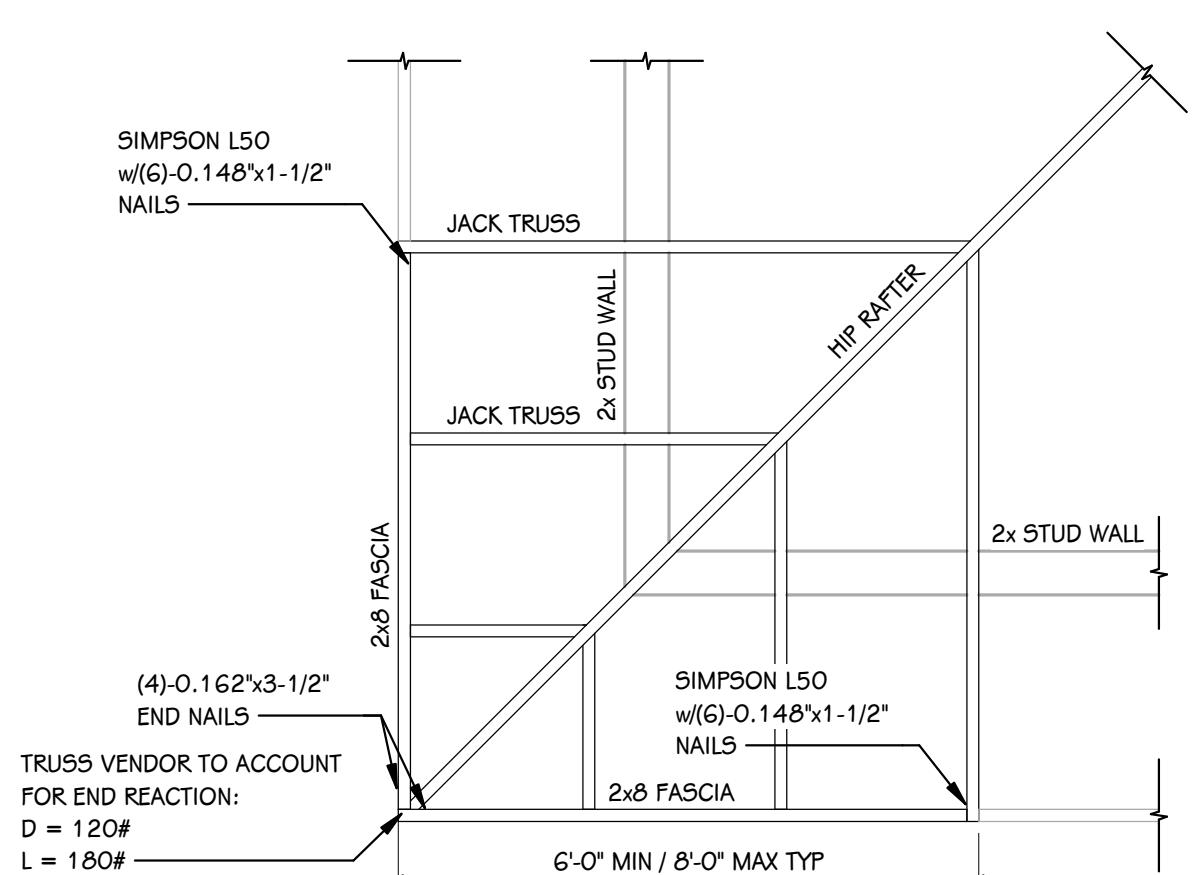

TYP HIP TRUSS DETAIL AT OVERHANG CORNER

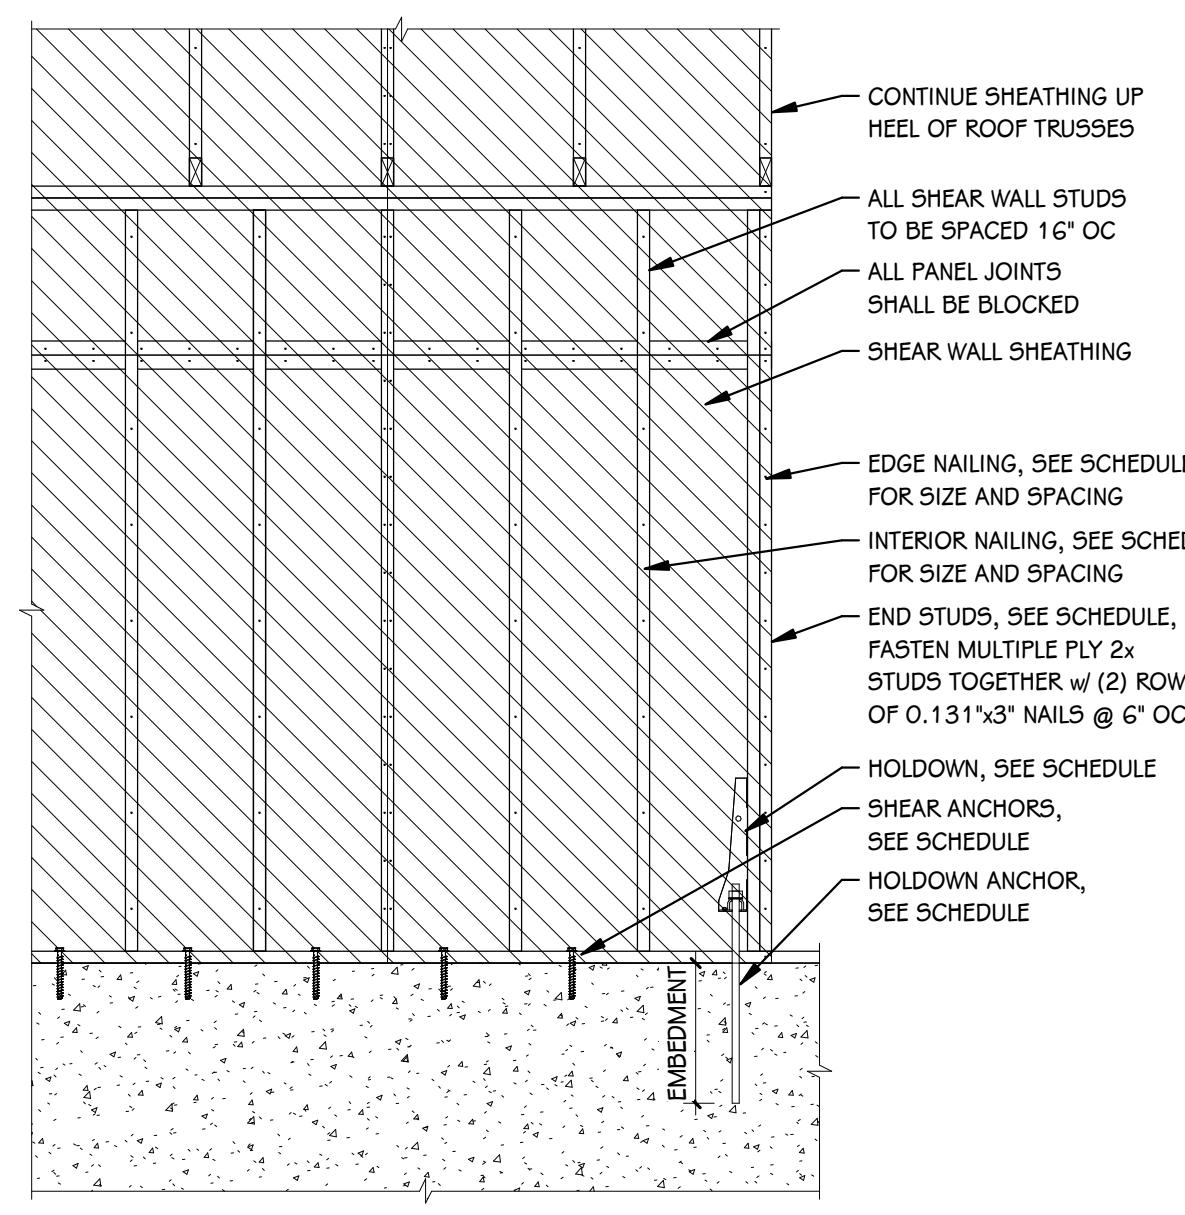

TYP WOOD SHEAR WALL

ISSUED FOR DATE

PROJECT TITLE TEAMSTERS LOCAL 2727


OWNER TEAMSTERS LOCAL 2727

SHEET TITLE TYPICAL STRUCTURAL DETAILS

DATE JANUARY 9, 2026

4810 N Preston Hwy
Sheppardsville, KY

SHEET NUMBER SG 003
25-376.000

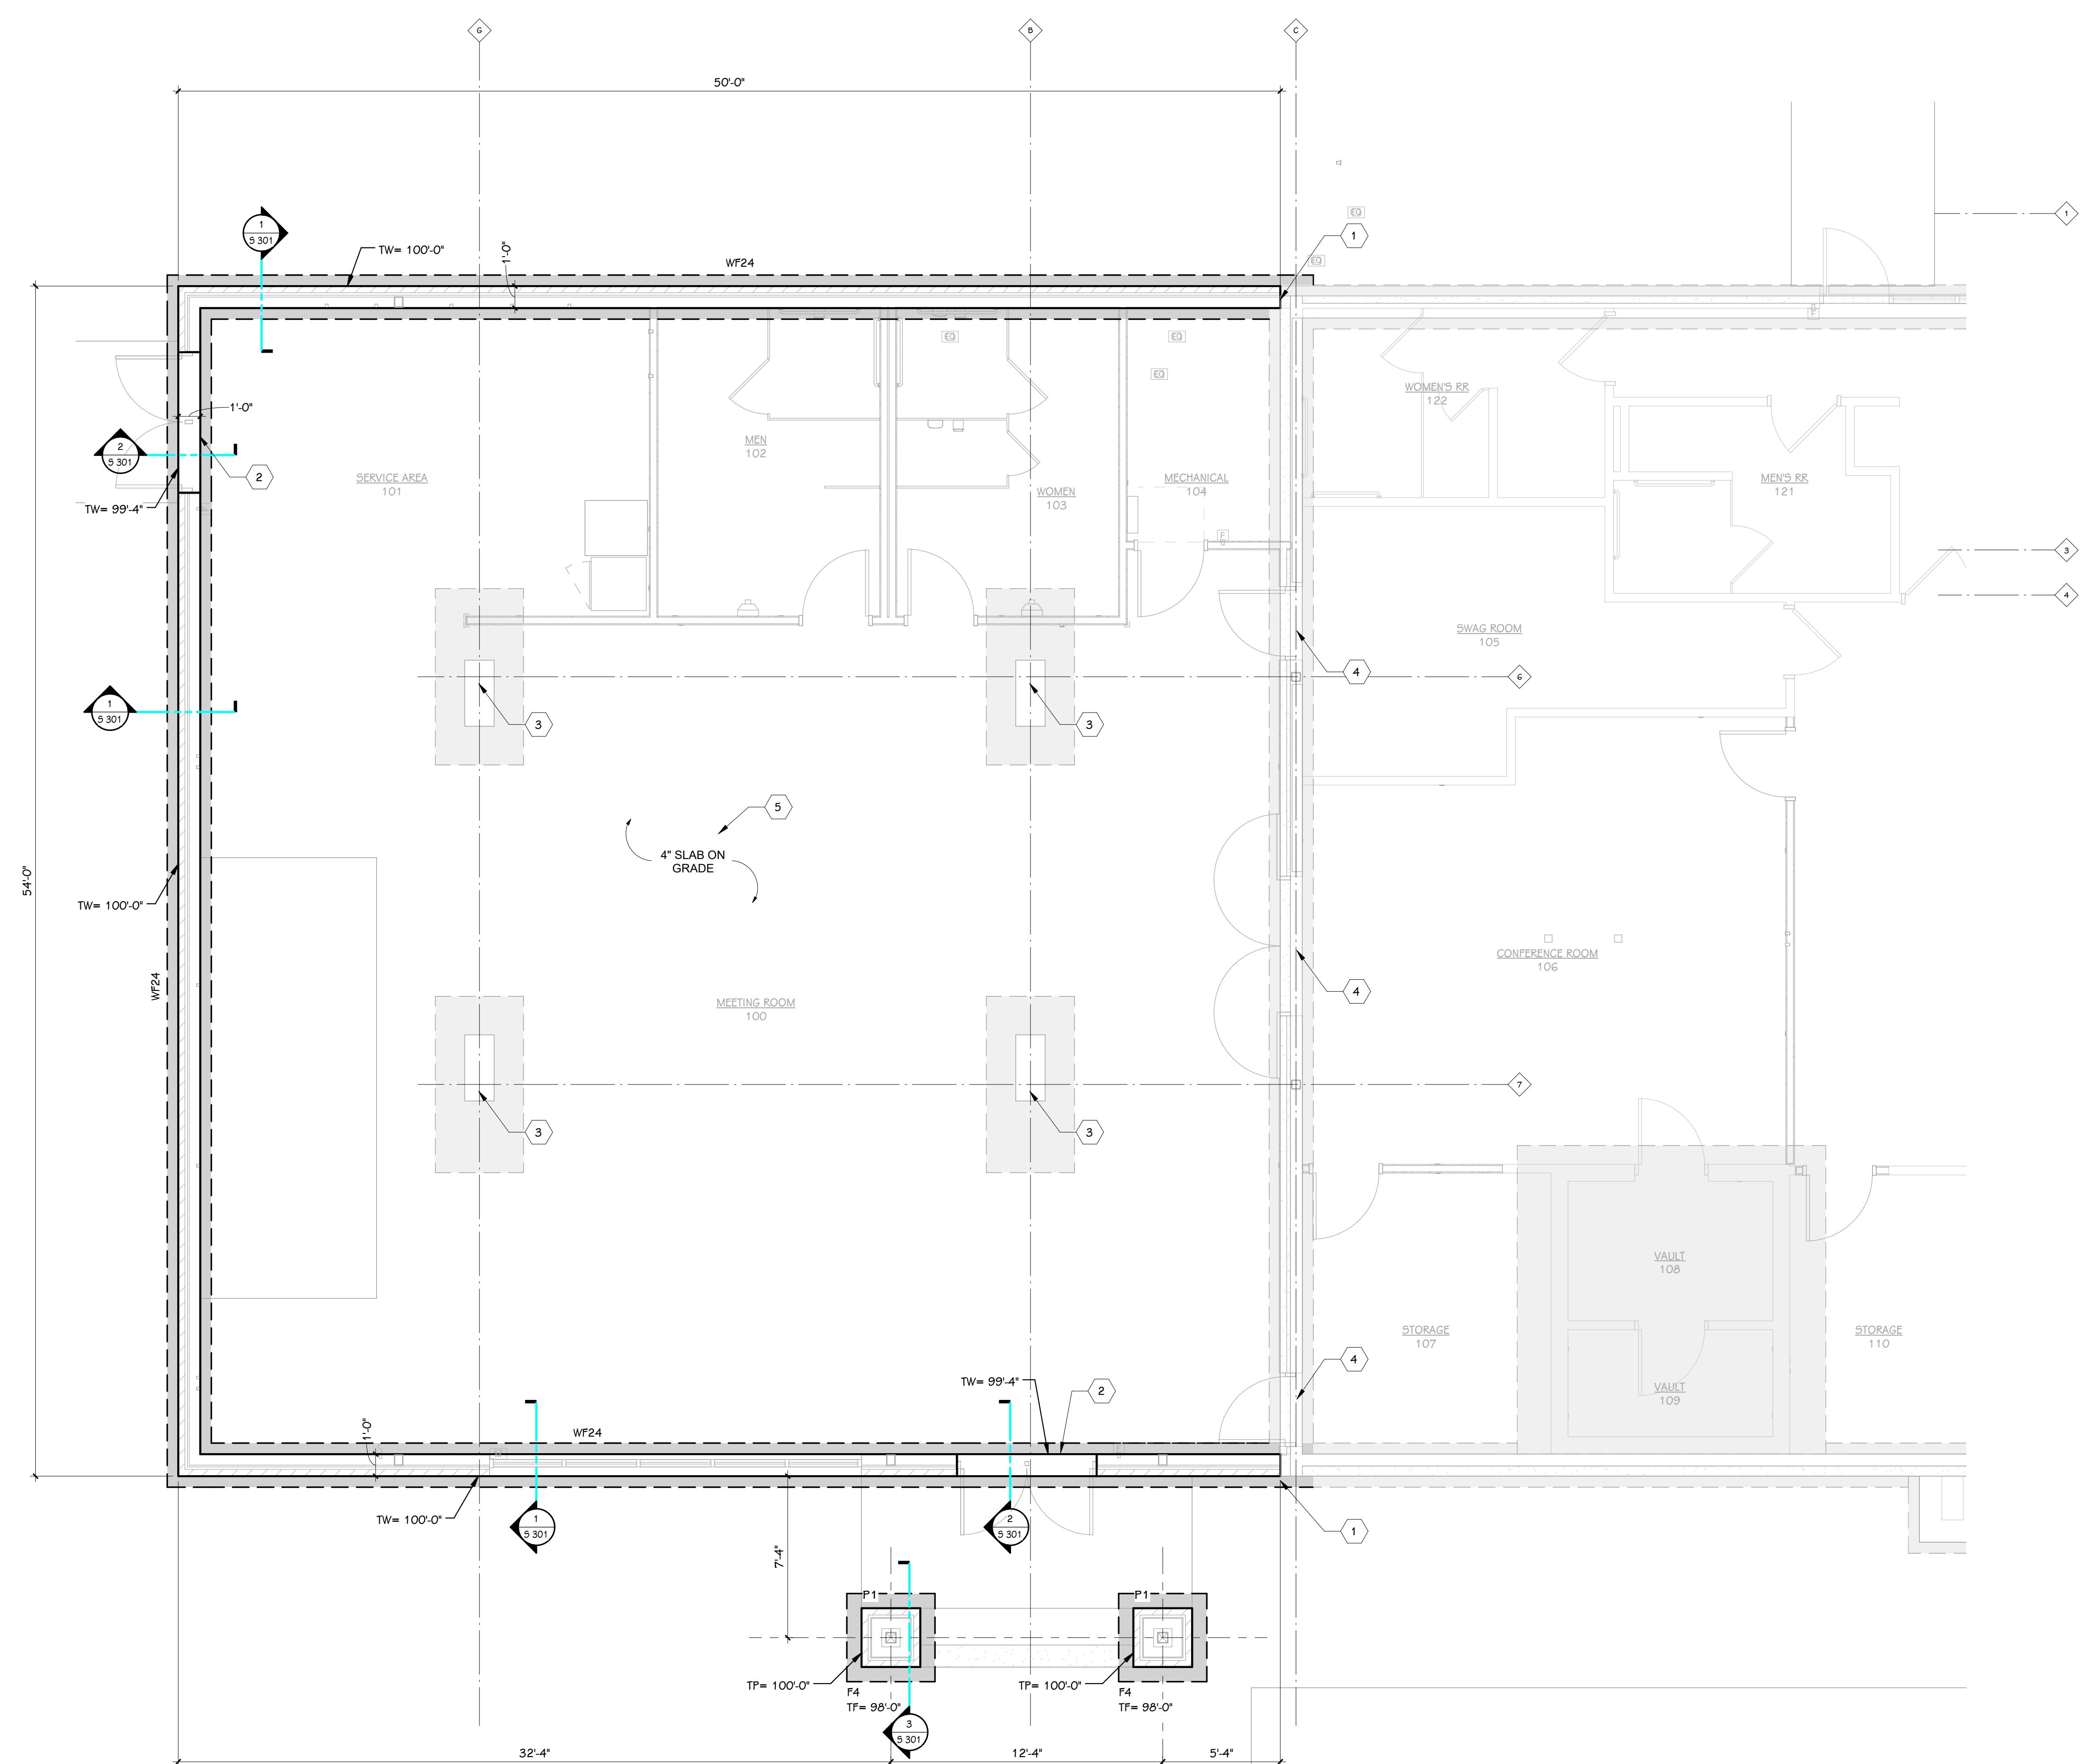

 **FOUNDATION PLAN**
1/4" = 1'-0"

NOTES - STRUCTURAL - FOUNDATION

- 1 FLOOR CONSTRUCTION, UNO: 4" SLAB ON GRADE WITH 6x6-W1.4xW1.4 WWF. REFER TO TYPICAL DETAILS FOR ADDITIONAL REQUIREMENTS
- 2 TOP OF SLAB-ON-GRADE ELEVATION = 100'-0", UNO
- 3 TOP OF PIER ELEVATION = 100'-0", UNO
- 4 TOP OF FOOTING ELEVATION = 97'-0" UNO. ALL EXTERIOR FOOTINGS TO EXTEND A MINIMUM OF 3'-0" BELOW FINISHED GRADE.
- 5 REFER TO GENERAL NOTES FOR DESIGN SOIL BEARING CAPACITY
- 6 REFER TO TYPICAL DETAIL FOR PIPE CROSSINGS AT FOUNDATIONS, STEP FOOTINGS AS REQUIRED TO ALLOW PIPE TO PASS THROUGH FOUNDATION WALL. REFER TO MECHANICAL FOR SIZES AND LOCATIONS OF PIPING, COORDINATE FINAL SIZES AND ELEVATIONS WITH MECHANICAL SUPPLIER.
- 7 VERIFY LOCATIONS OF COLUMNS, WALLS, OPENINGS, ETC. WITH ARCHITECTURAL DRAWINGS BEFORE PLACING FOUNDATIONS.
- 8 COORDINATE WITH ALL DRAWINGS FOR LOCATION OF OPENINGS, SLEEVES, AND UNDER FLOOR PIPES, CONDUITS, DRAINS, DEPRESSIONS, ETC.
- 9 SHORING, BRACING AND/OR SHEETING MAY BE REQUIRED WHEN EXCAVATION ADJACENT TO THE EXISTING STRUCTURE. DESIGN AND INSTALLATION OF SUCH SHORING, BRACING AND/OR SHEETING IS THE RESPONSIBILITY OF THE CONTRACTOR.



DATE: 01/08/2006
EXPIRES: 06/30/2007

ISSUED FOR DATE

PROJECT TITLE
TEAMSTERS LOCAL 2727


OWNER
TEAMSTERS LOCAL 2727

SHEET TITLE
FOUNDATION PLAN
SHEET NUMBER
S 101
25-376.000

4810 N Preston Hwy
Sheppardsville, KY

DATE
JANUARY 9, 2006

SPREAD FOOTING SCHEDULE				
MARK	THICKNESS	WIDTH	LENGTH	FOOTING REINFORCING
F4	12"	4'-0"	4'-0"	(4) #5 BOTTOM BARS EACH WAY, EQUALLY SPACED
WALL FOOTING SCHEDULE				
MARK	SIZE	REINFORCEMENT		
WF24	24" x 12"	LONGITUDINAL	TRANSVERSE	(2) #5

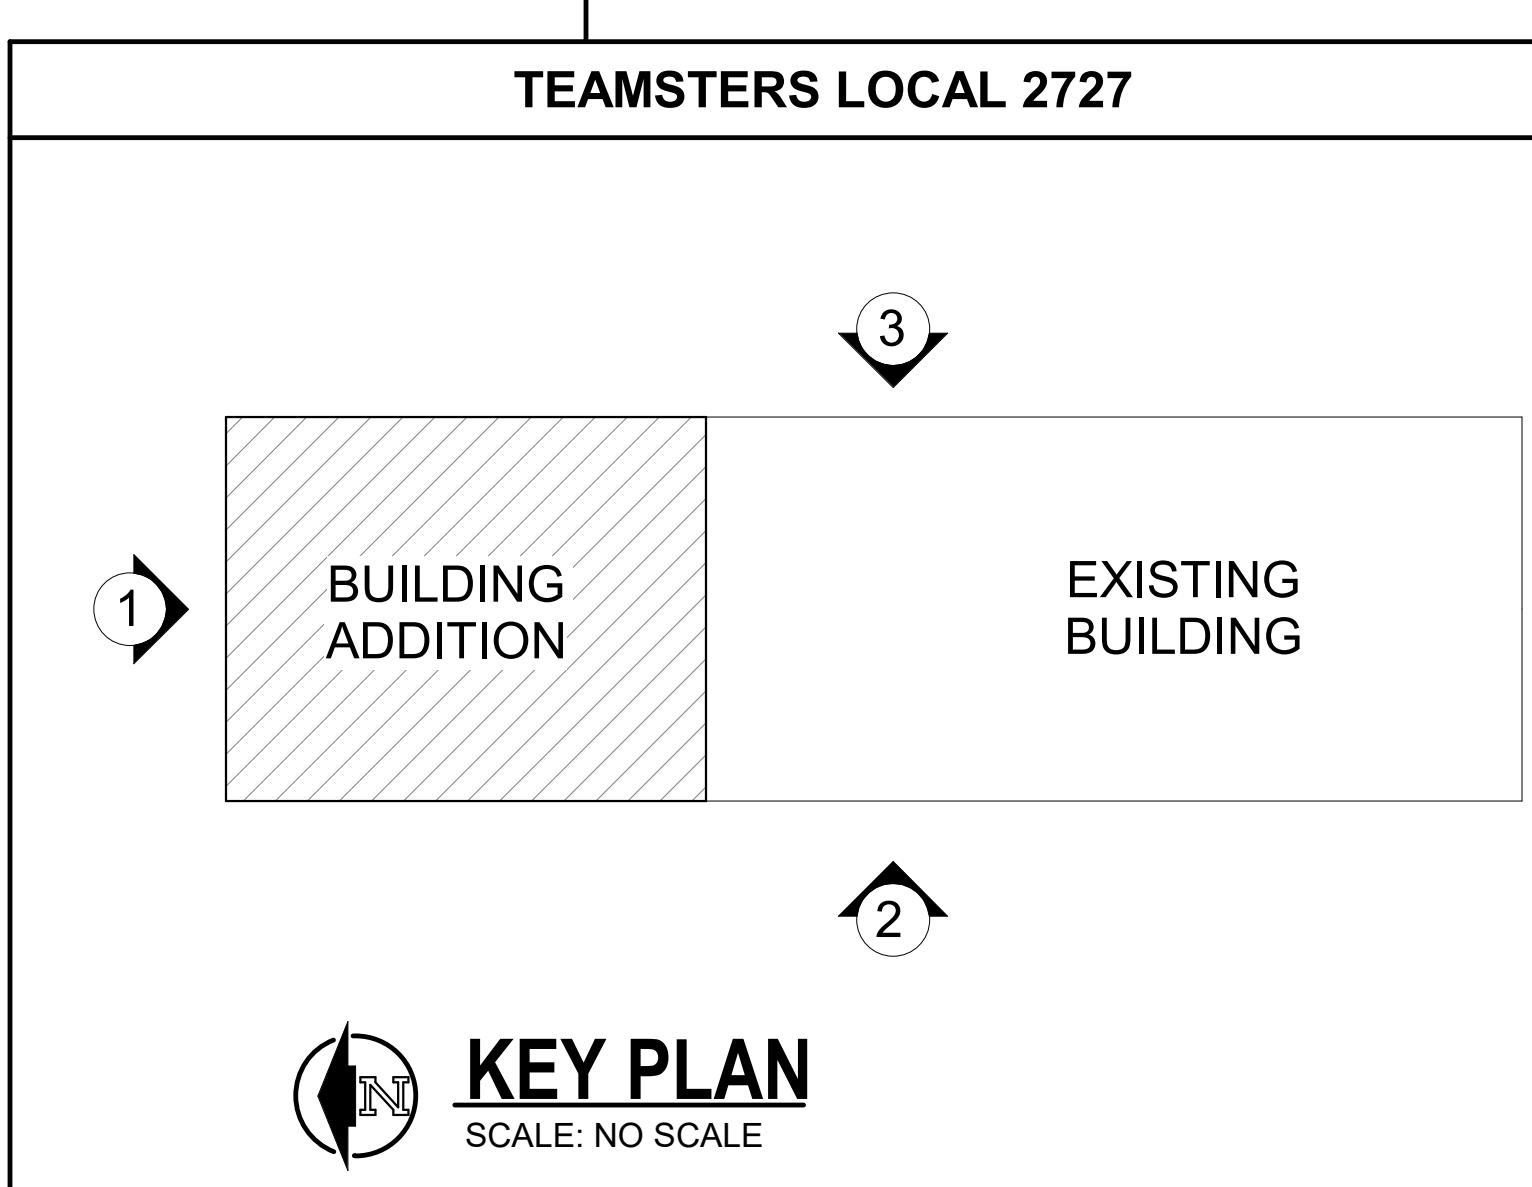

 **KEY PLAN**
SCALE: NO SCALE

PROJECT TITLE
TEAMSTERS LOCAL 2727

OWNER
TEAMSTERS LOCAL 2727

4810 N Preston Hwy
Sheppardsville, KY


SHEET TITLE
ROOF FRAMING PLAN

DATE
JANUARY 9, 2026

SHEET NUMBER
S 201

SCALE: NO SCALE

25-376.000

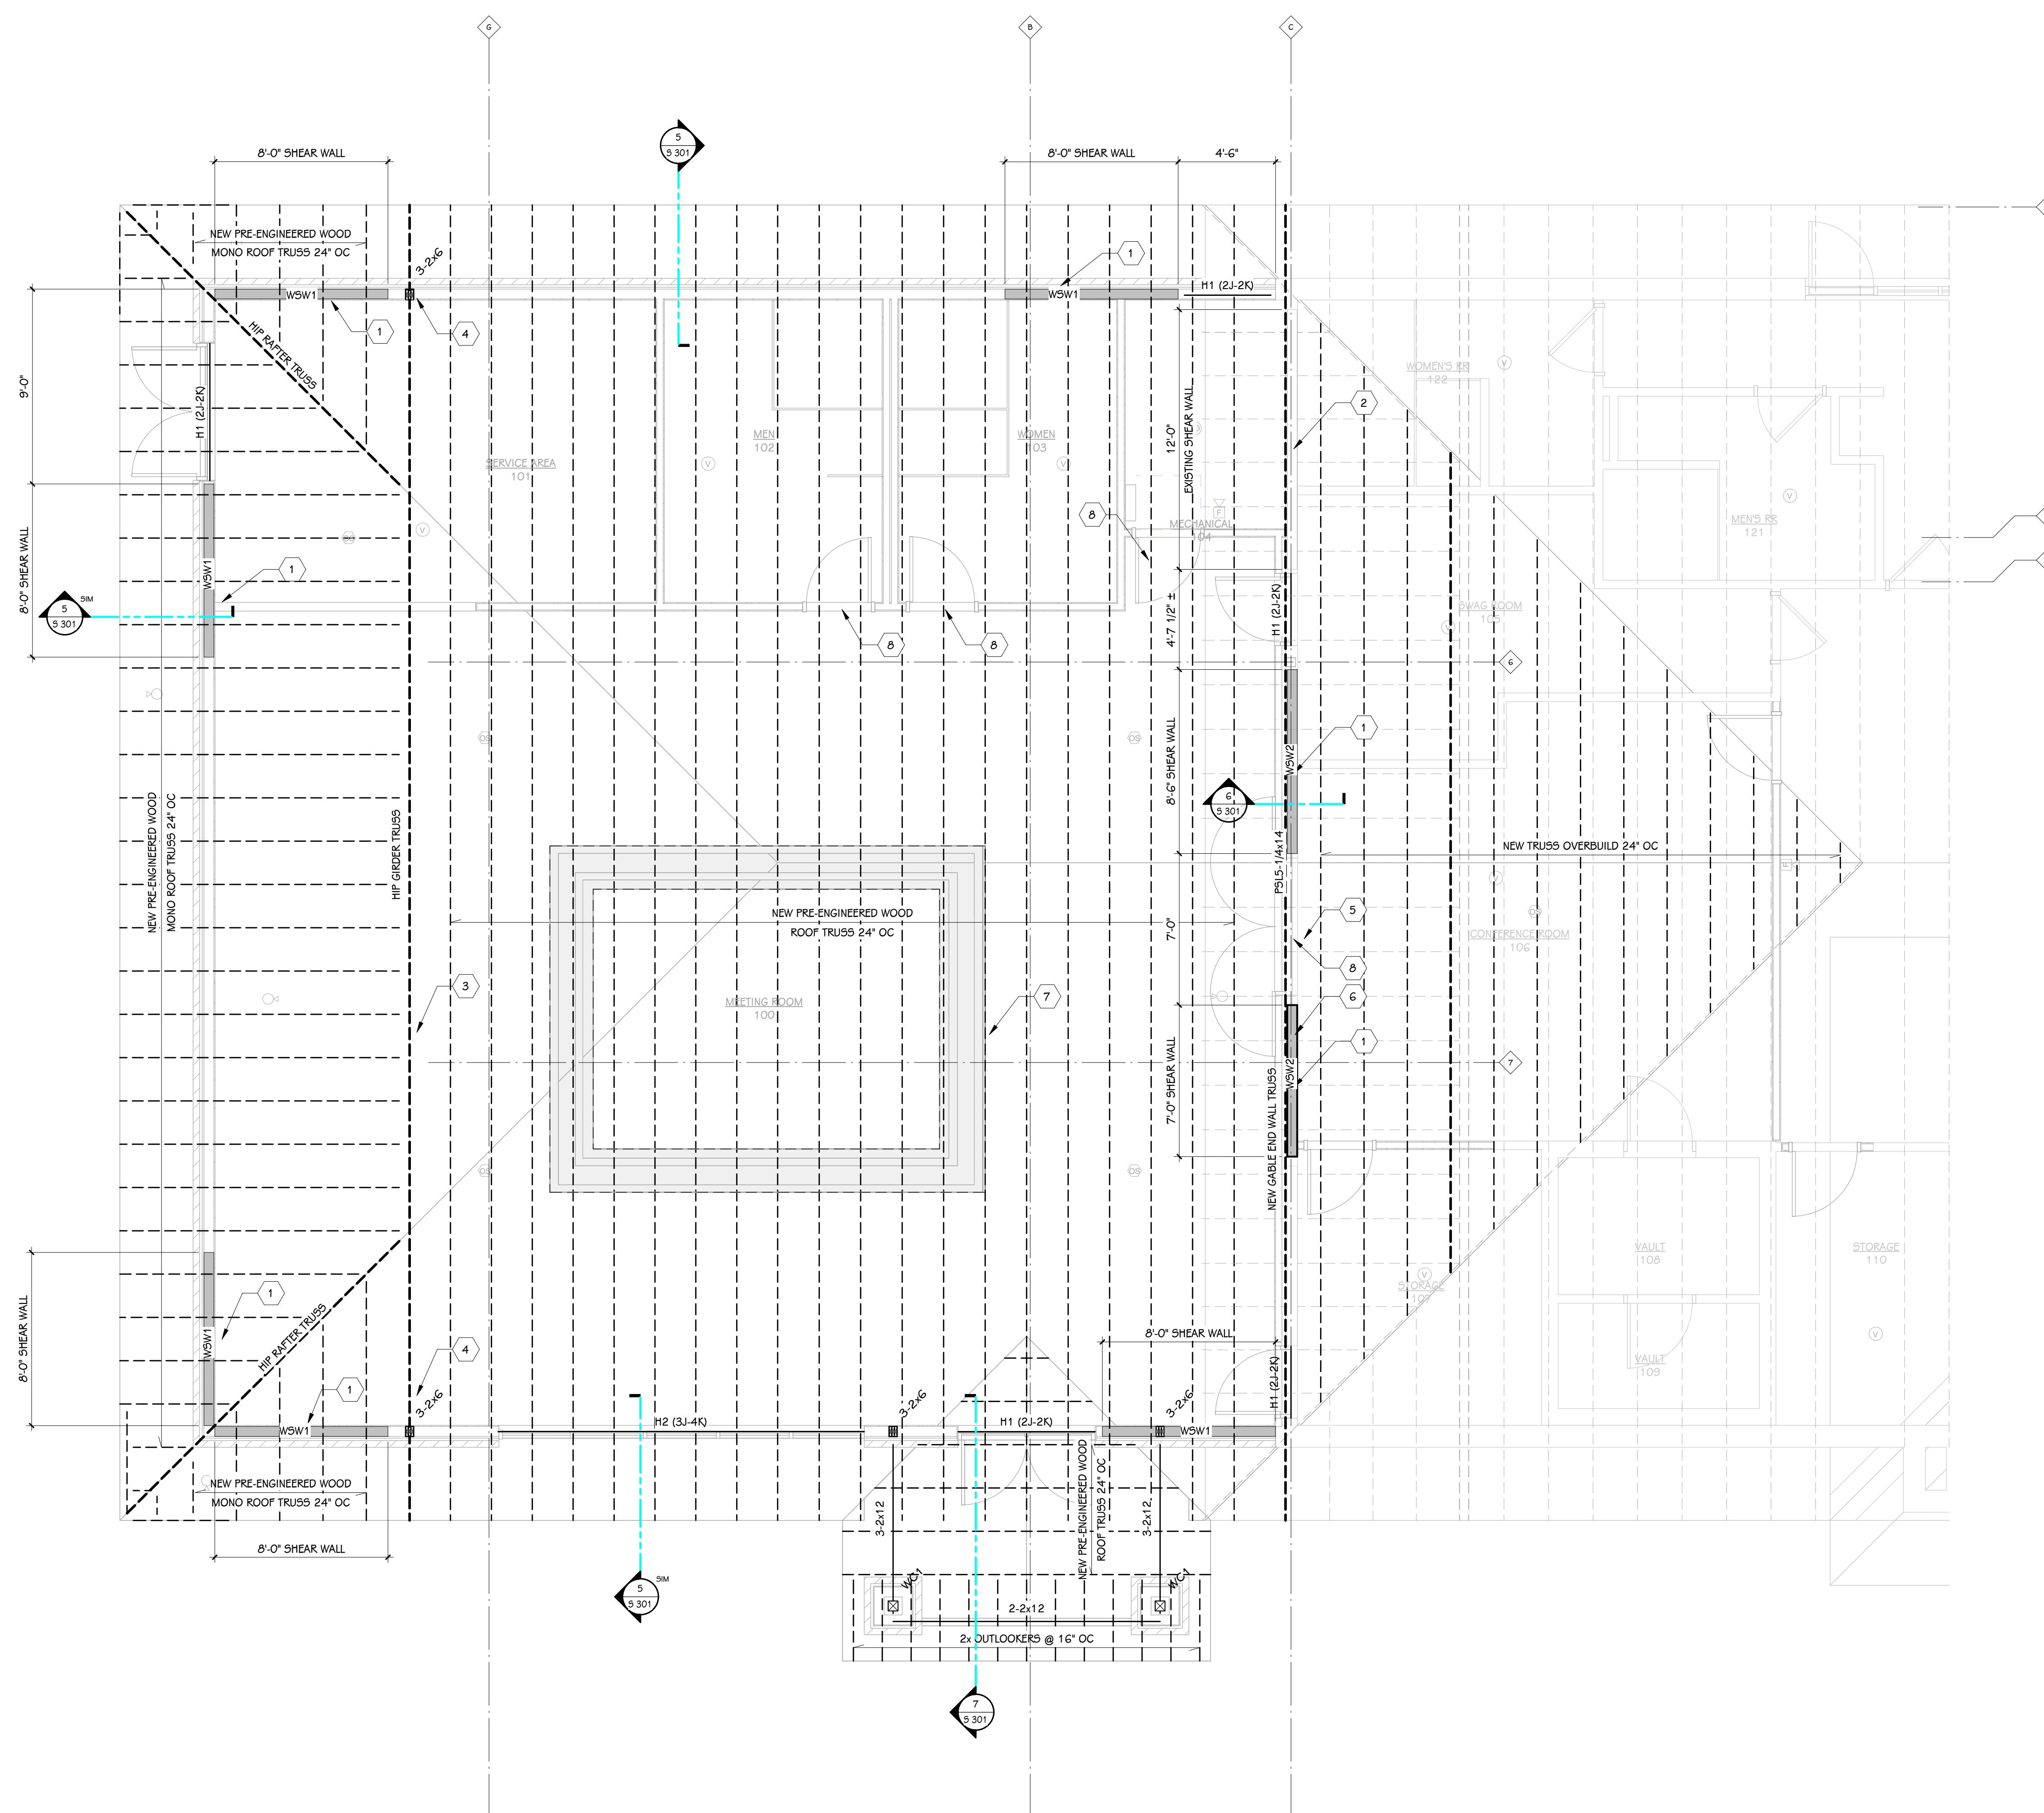

ROOF FRAMING PLAN
1/4" = 1'-0"


WOOD HEADER SCHEDULE	
MARK	HEADER SIZE
H1	(2) 2x10
H2	(3) 18" LVL

MARK	SIZE	CONNECTORS		NOTES
		BASE	TOP	
WC1	6x6	ABW662 POST BASE w/ (12) 0.162" x 3-1/2" NAILS EMBEDDED 10" w/SIMPSON SD5 SCREWS	PCG62 POST CAP w/ (10) 0.148" x 3" BEAM AND (8) 0.148" x 3" POST NAILS	

WOOD SHEAR WALL SCHEDULE

MARK	SHEATHING	PANEL NAILING		CHORD	HOLDOWN	HOLDOWN ANCHORS	SHEAR CONNECTORS		NOTES
		EDGE	INTERIOR				BASE	TOP	
W5W1	ZIP-R6	0.131" x 3" @ 4" OC	0.131" x 3" @ 12" OC	(3) 2x6	HDU4 SD52.5 w/ (10) 1/4" x 2 1/2" 5/8" DIA. THREADED ROD EMBEDDED 10" w/SIMPSON SD5 SCREWS	1/2" x 8" SIMPSON TITEN HD SCREW ANCHORS @ 24" OC	-	-	
W5W2	15/32" OSB	0.131" x 2" @ 4" OC	0.131" x 2" @ 12" OC	(3) 2x6	HDU8 SDP2.5 w/ (20) 1/4" x 2 1/2" 7/8" DIA. THREADED ROD EMBEDDED 17 1/2" w/SIMPSON SD8 SCREWS	1/2" x 8" SIMPSON TITEN HD SCREW ANCHORS @ 24" OC	-	-	

TEAMSTERS LOCAL 2727

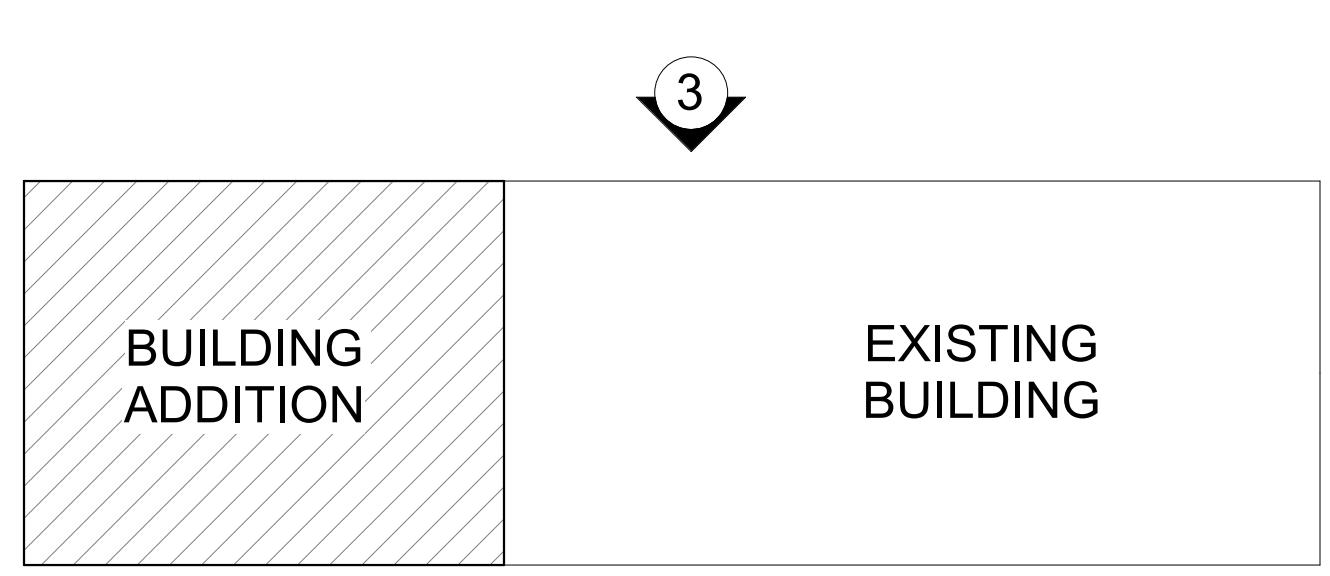


KEY PLAN
SCALE: NO SCALE

NOTES - STRUCTURAL - FRAMING

- 1 ROOF TRUSSES TO BE SLOPED AS REQUIRED. REFER TO ARCHITECTURAL DRAWINGS FOR SLOPE REQUIREMENTS.
- 2 REFER TO ARCHITECTURAL DRAWINGS FOR INSULATION REQUIREMENTS.
- 3 REFER TO ARCHITECTURAL DRAWINGS FOR APPLICATION OF ICE AND WATER SHIELD TO BE APPLIED AT EAVES AND VALLEYS.
- 4 COORDINATE SIZE AND LOCATIONS OF ROOF OPENINGS WITH HVAC CONTRACTOR.
- 5 ALL BEARING WALLS, EXTERIOR WALLS, AND WALLS CONTAINING SHEAR WALLS, SHALL BE FRAMED WITH 2x6 STUDS @ 16" OC.

KEYED NOTES - STRUCTURAL - FRAMING


- 1 NEW SHEAR WALL PER TYPICAL DETAILS
- 2 EXISTING SHEAR WALL TO REMAIN
- 3 NEW HIP GIRDER TRUSS. FINAL LOCATION PER TRUSS VENDOR.
- 4 PROVIDE BEARING STUDS BELOW HIP GIRDER
- 5 EXISTING PSL TO REMAIN
- 6 NEW FULL-LENGTH GABLE END WALL TRUSS ON EXISTING STUD WALL
- 7 DENOTES EXTENT OF ADDITIONAL CEILING FRAMING. SEE ARCH DRAWINGS FOR EXTENTS. TRUSS VENDOR TO PROVIDE ADDITIONAL 5 PSF LOADING TO AFFECTED TRUSS MEMBERS
- 8 PROVIDE (2) 2x6 AT DOOR HEAD. SEE ARCH DRAWINGS

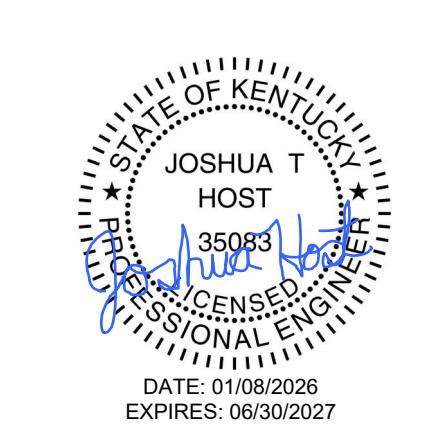


PROJECT TITLE
TEAMSTERS LOCAL 2727

OWNER
4810 N Preston Hwy
Sheppardsville, KY


SHEET TITLE
FOUNDATION AND FRAMING DETAILS
SHEET NUMBER
S 301
25-376.000

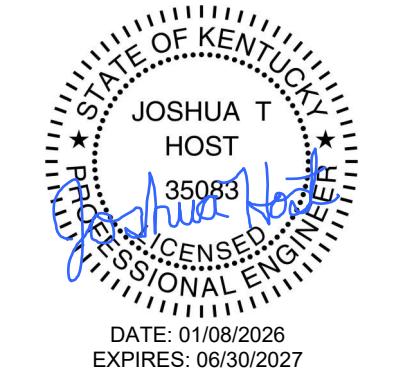


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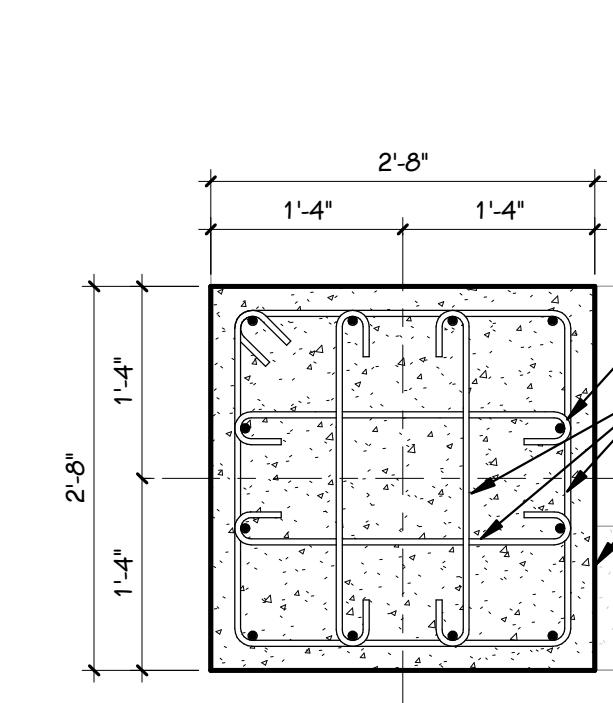
1 TYP WALL FOUNDATION
5 301 3/4" = 1'-0"

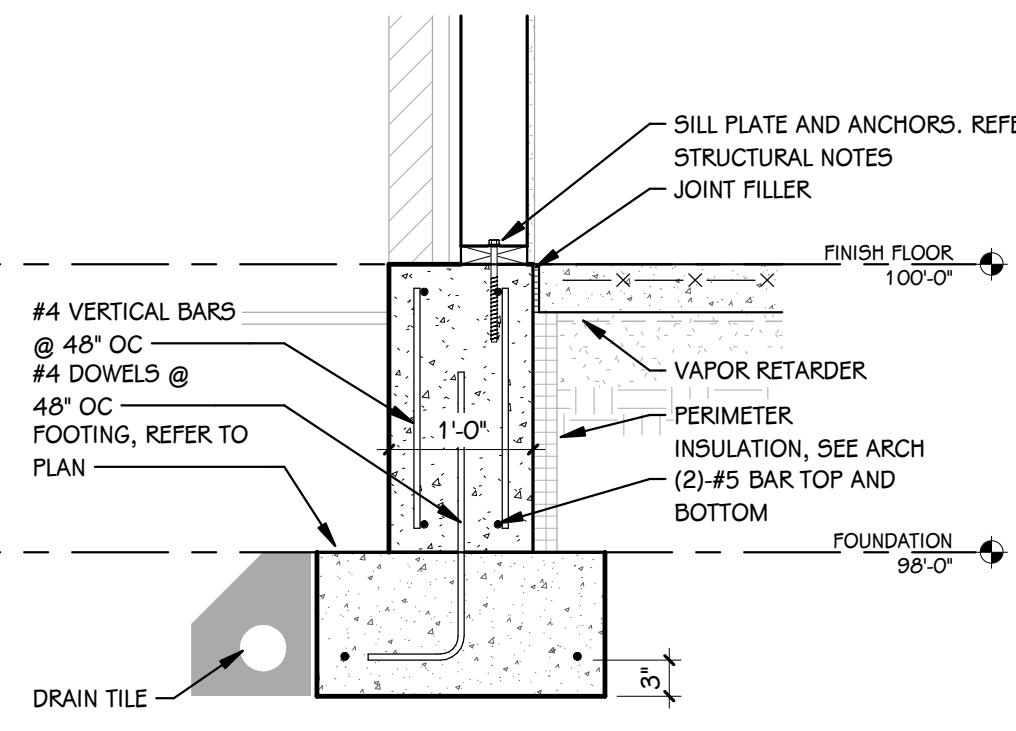


2 WALL FOUNDATION AT THRESHOLD
5 301 3/4" = 1'-0"

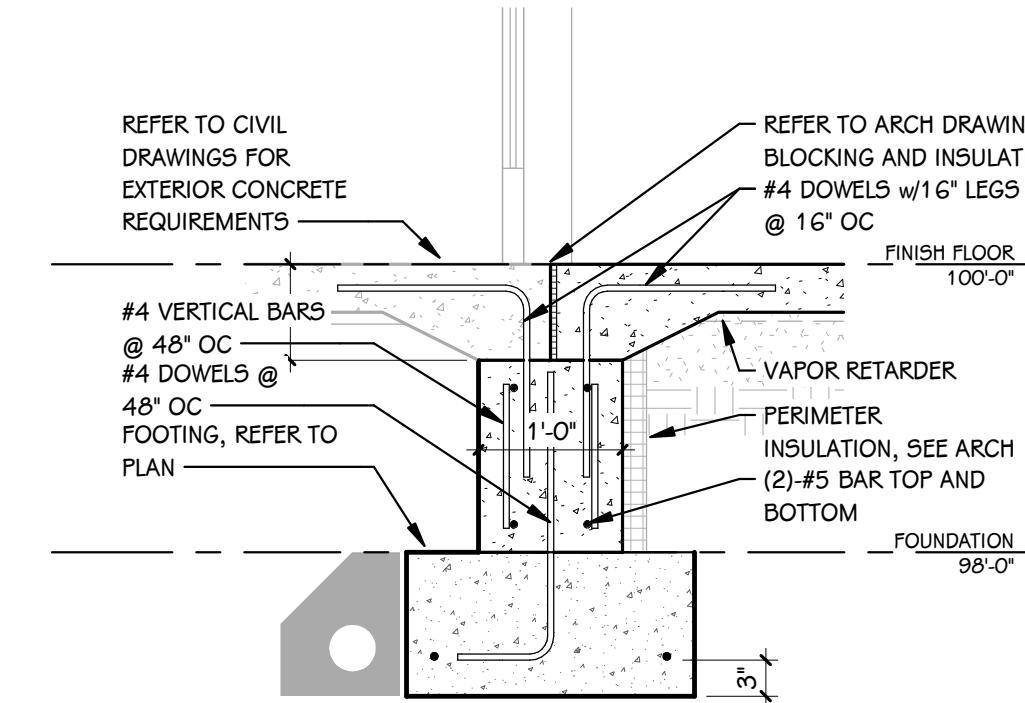


3 TYP PIER FOUNDATION
5 301 3/4" = 1'-0"

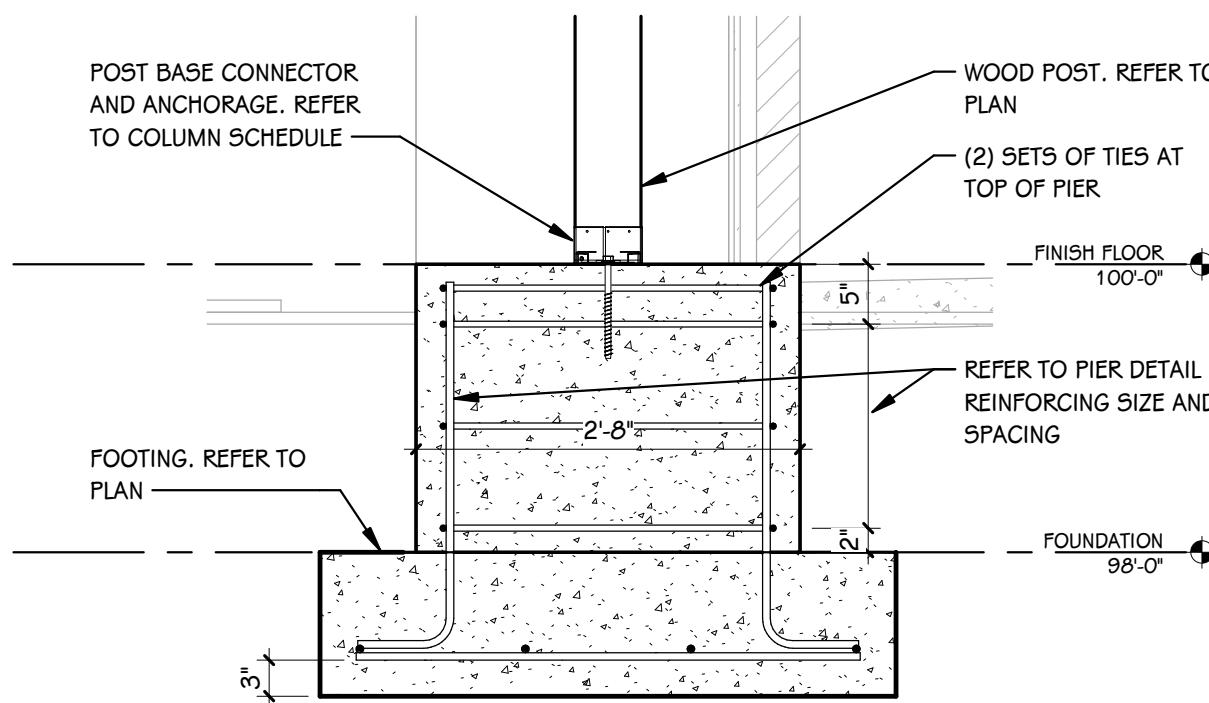


4 PIER "P1"
5 301 3/4" = 1'-0"

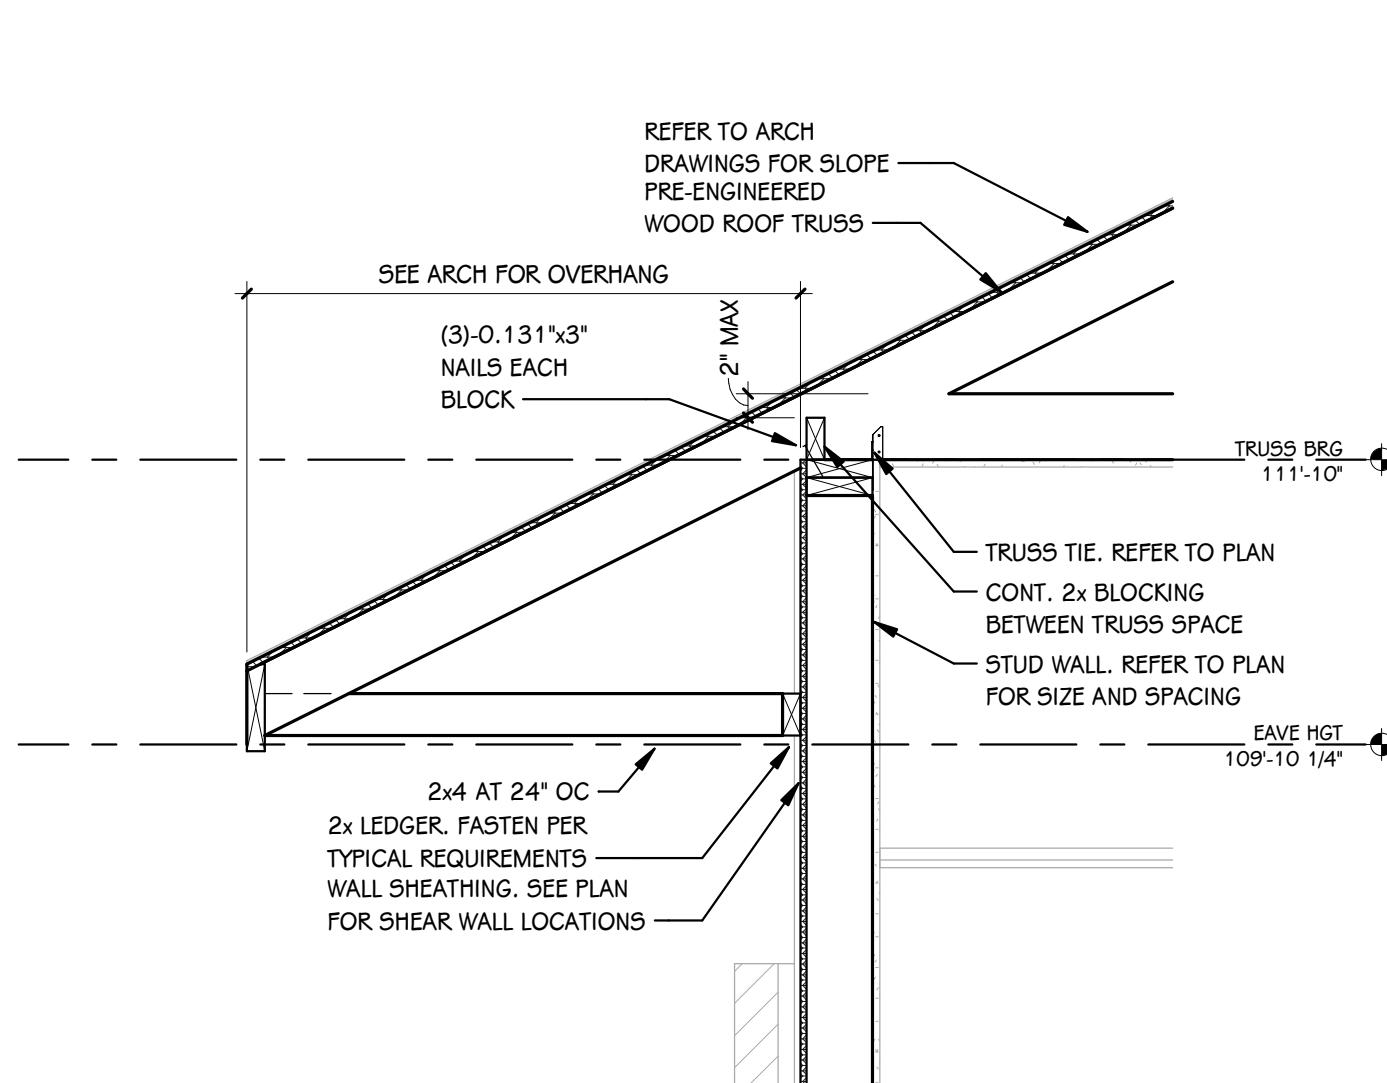

5 TYP FRAMING SECTION AT EAVE
5 301 3/4" = 1'-0"

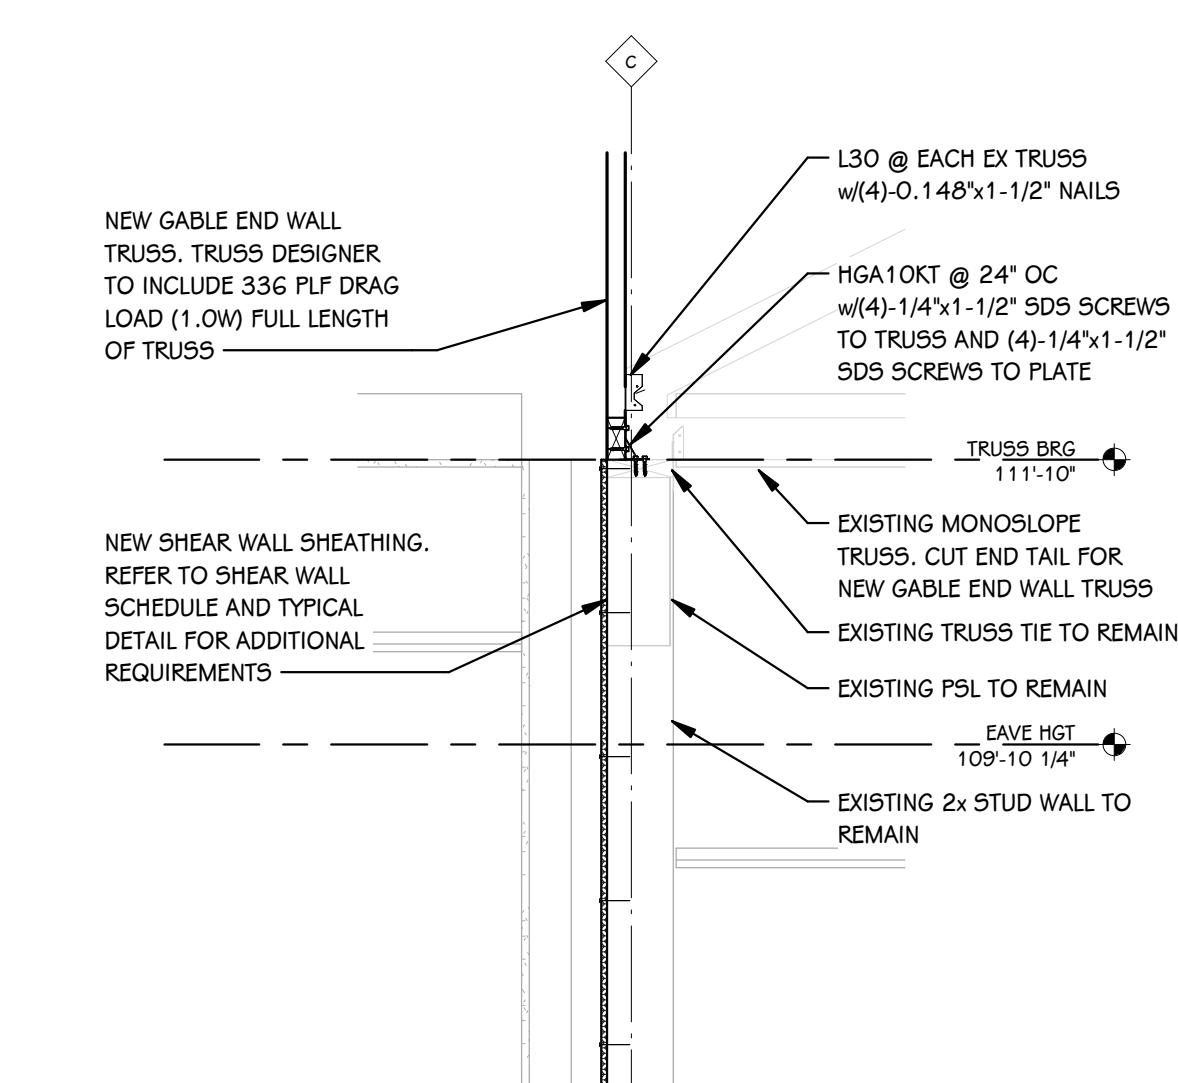

6 FRAMING SECTION AT NEW GABLE END WALL
5 301 3/4" = 1'-0"

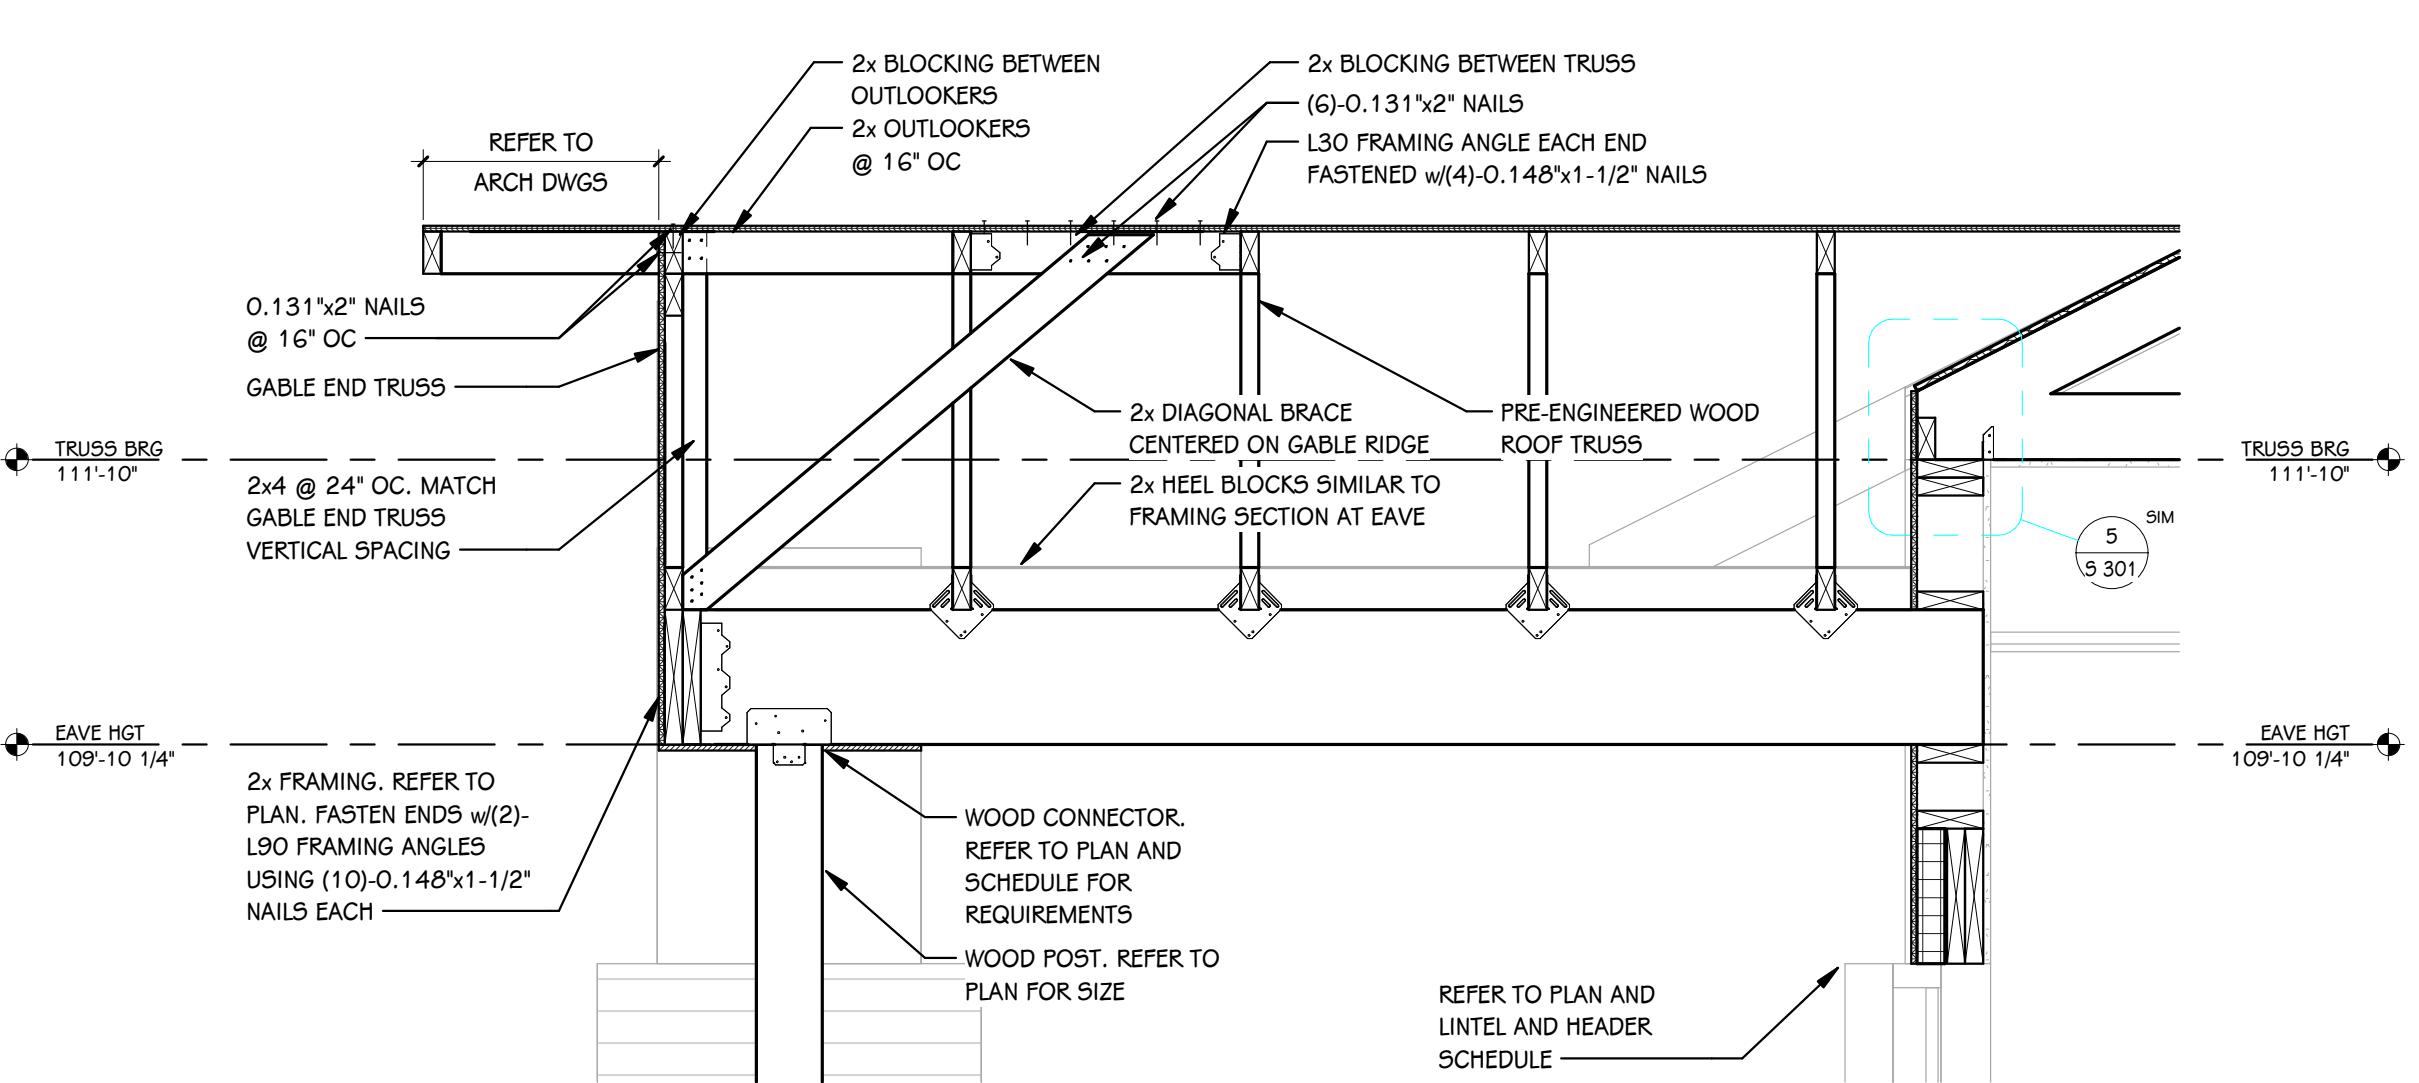

7 FRAMING SECTION AT NEW ENTRYWAY
5 301 3/4" = 1'-0"

PROJECT TITLE
TEAMSTERS LOCAL 2727
BUILDING ADDITION

OWNER
TEAMSTERS LOCAL 2727
4810 N Preston Hwy
Shepherdsville, KY


DATE
JANUARY 9, 2026
SHEET TITLE
DEMOLITION FLOOR PLAN
SHEET NUMBER
AD 101
25-376.000

KEYED NOTES - ARCHITECTURAL - DEMOLITION

- 1 COMPLETELY REMOVE EXISTING STUD PARTITION WALL IN IT'S ENTIRETY (INCLUDING, BUT NOT LIMITED TO: DOORS, FRAMES, HARDWARE, WINDOWS, WALL BASE, AND ALL SURFACE MOUNTED ITEMS). EXISTING COLUMNS TO REMAIN. SEE PLUMBING, MECHANICAL, AND ELECTRICAL FOR ADDITIONAL WORK. PREP FOR NEW CONSTRUCTION.
- 2 COMPLETELY REMOVE BROADLOOM CARPET, MASTIC AND WALL BASE. PREP FOR NEW FINISH.
- 3 REMOVE PORTION OF TILE FLOORING, MORTAR AND TILE BASE. PREP FOR NEW CONSTRUCTION.
- 4 COMPLETELY REMOVE EXISTING CASEWORK IN ITS ENTIRETY. PREP FOR NEW CONSTRUCTION.
- 5 REMOVE PORTION OF BRICK AND STUD WALL AS REQUIRED FOR INSTALLATION OF NEW DOOR AND FRAME. PREP FOR NEW CONSTRUCTION. SEE UNTIL SCHEDULE.
- 6 OWNER TO REMOVE EXTERIOR BANKTELLER WINDOW. CONTRACTOR TO COORDINATE THE REMOVAL WITH OWNER. CONTRACTOR TO REMOVE PORTION OF WALL BELOW FOR THE INSTALLATION OF NEW DOOR AND FRAME.
- 7 COMPLETELY REMOVE RECESSED NIGHT DEPOSIT BOX FROM WALL. INFILL THE OPENING WITH MATCHING CONSTRUCTION AND PREP FOR NEW FINISH AS SCHEDULED. TURN OVER REMOVED EQUIPMENT TO THE OWNER.
- 8 REMOVE EXISTING CASED OPENING TRIM WORK. ENLARGE OPENING AS REQUIRED TO INSTALL SALVAGED DOOR AND FRAME IN NEW OPENING.
- 9 EXISTING TILE TO REMAIN. PROTECT DURING CONSTRUCTION.
- 10 CAREFULLY REMOVE VINYL WALLCOVERING FROM ENTIRE ROOM. PREP FOR NEW WALL FINISHES.
- 11 EXISTING CARPETING TO REMAIN. PROTECT DURING CONSTRUCTION.
- 12 REMOVE EXISTING CONCRETE PAD, CONCRETE ISLANDS, BOLLARDS, CONCRETE CURBS, ETC. COMPLETE. PREP AREA FOR NEW CONSTRUCTION.
- 13 REMOVE EXISTING BRICK MASONRY COLUMN COMPLETE. REMOVE EXISTING STEEL COLUMN AND CONCRETE PIER TO A MIN. 12" BELOW FINISH FLOOR. THE EXISTING FOOTING MAY BE ABANDONED IN PLACE. REFER TO STRUCTURAL DRAWING FOR ADDITIONAL INFORMATION.
- 14 SAWCUT EXISTING FLOOR SLAB AS REQUIRED FOR INSTALLATION OF NEW POWER OUTLETS. FIELD VERIFY EXACT LOCATION PRIOR TO SAWCUTTING. REFER TO ELECTRICAL DRAWINGS FOR ADDITIONAL INFORMATION. PATCH FLOOR BACK WITH MATCHING CONSTRUCTION (REFER TO A15G002 FOR DOWELS INTO EXISTING SLAB) AND PREP FOR NEW FINISH AS.
- 15 REMOVE BRICK VENEER AND E.I.F.S. COMPLETE.
- 16 SALVAGE DOOR AND FRAME. REINSTALL IN NEW OPENING SEE NOTE 8 AND DOOR SCHEDULE FOR ADDITIONAL INFORMATION.
- 17 BASE BID: EXISTING VCT FLOORING AND WALL BASE TO REMAIN. PROTECT DURING CONSTRUCTION. ALTERNATE 4- REMOVE VCT FLOORING, MASTIC AND WALL BASE. PREP FOR NEW FINISHES.


KEYED NOTES - ARCHITECTURAL - DEMOLITION

- 9 EXISTING TILE TO REMAIN. PROTECT DURING CONSTRUCTION.
- 10 CAREFULLY REMOVE VINYL WALLCOVERING FROM ENTIRE ROOM. PREP FOR NEW WALL FINISHES.
- 11 EXISTING CARPETING TO REMAIN. PROTECT DURING CONSTRUCTION.
- 12 REMOVE EXISTING CONCRETE PAD, CONCRETE ISLANDS, BOLLARDS, CONCRETE CURBS, ETC. COMPLETE. PREP AREA FOR NEW CONSTRUCTION.
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- 15 REMOVE BRICK VENEER AND E.I.F.S. COMPLETE.
- 16 SALVAGE DOOR AND FRAME. REINSTALL IN NEW OPENING SEE NOTE 8 AND DOOR SCHEDULE FOR ADDITIONAL INFORMATION.
- 17 BASE BID: EXISTING VCT FLOORING AND WALL BASE TO REMAIN. PROTECT DURING CONSTRUCTION. ALTERNATE 4- REMOVE VCT FLOORING, MASTIC AND WALL BASE. PREP FOR NEW FINISHES.

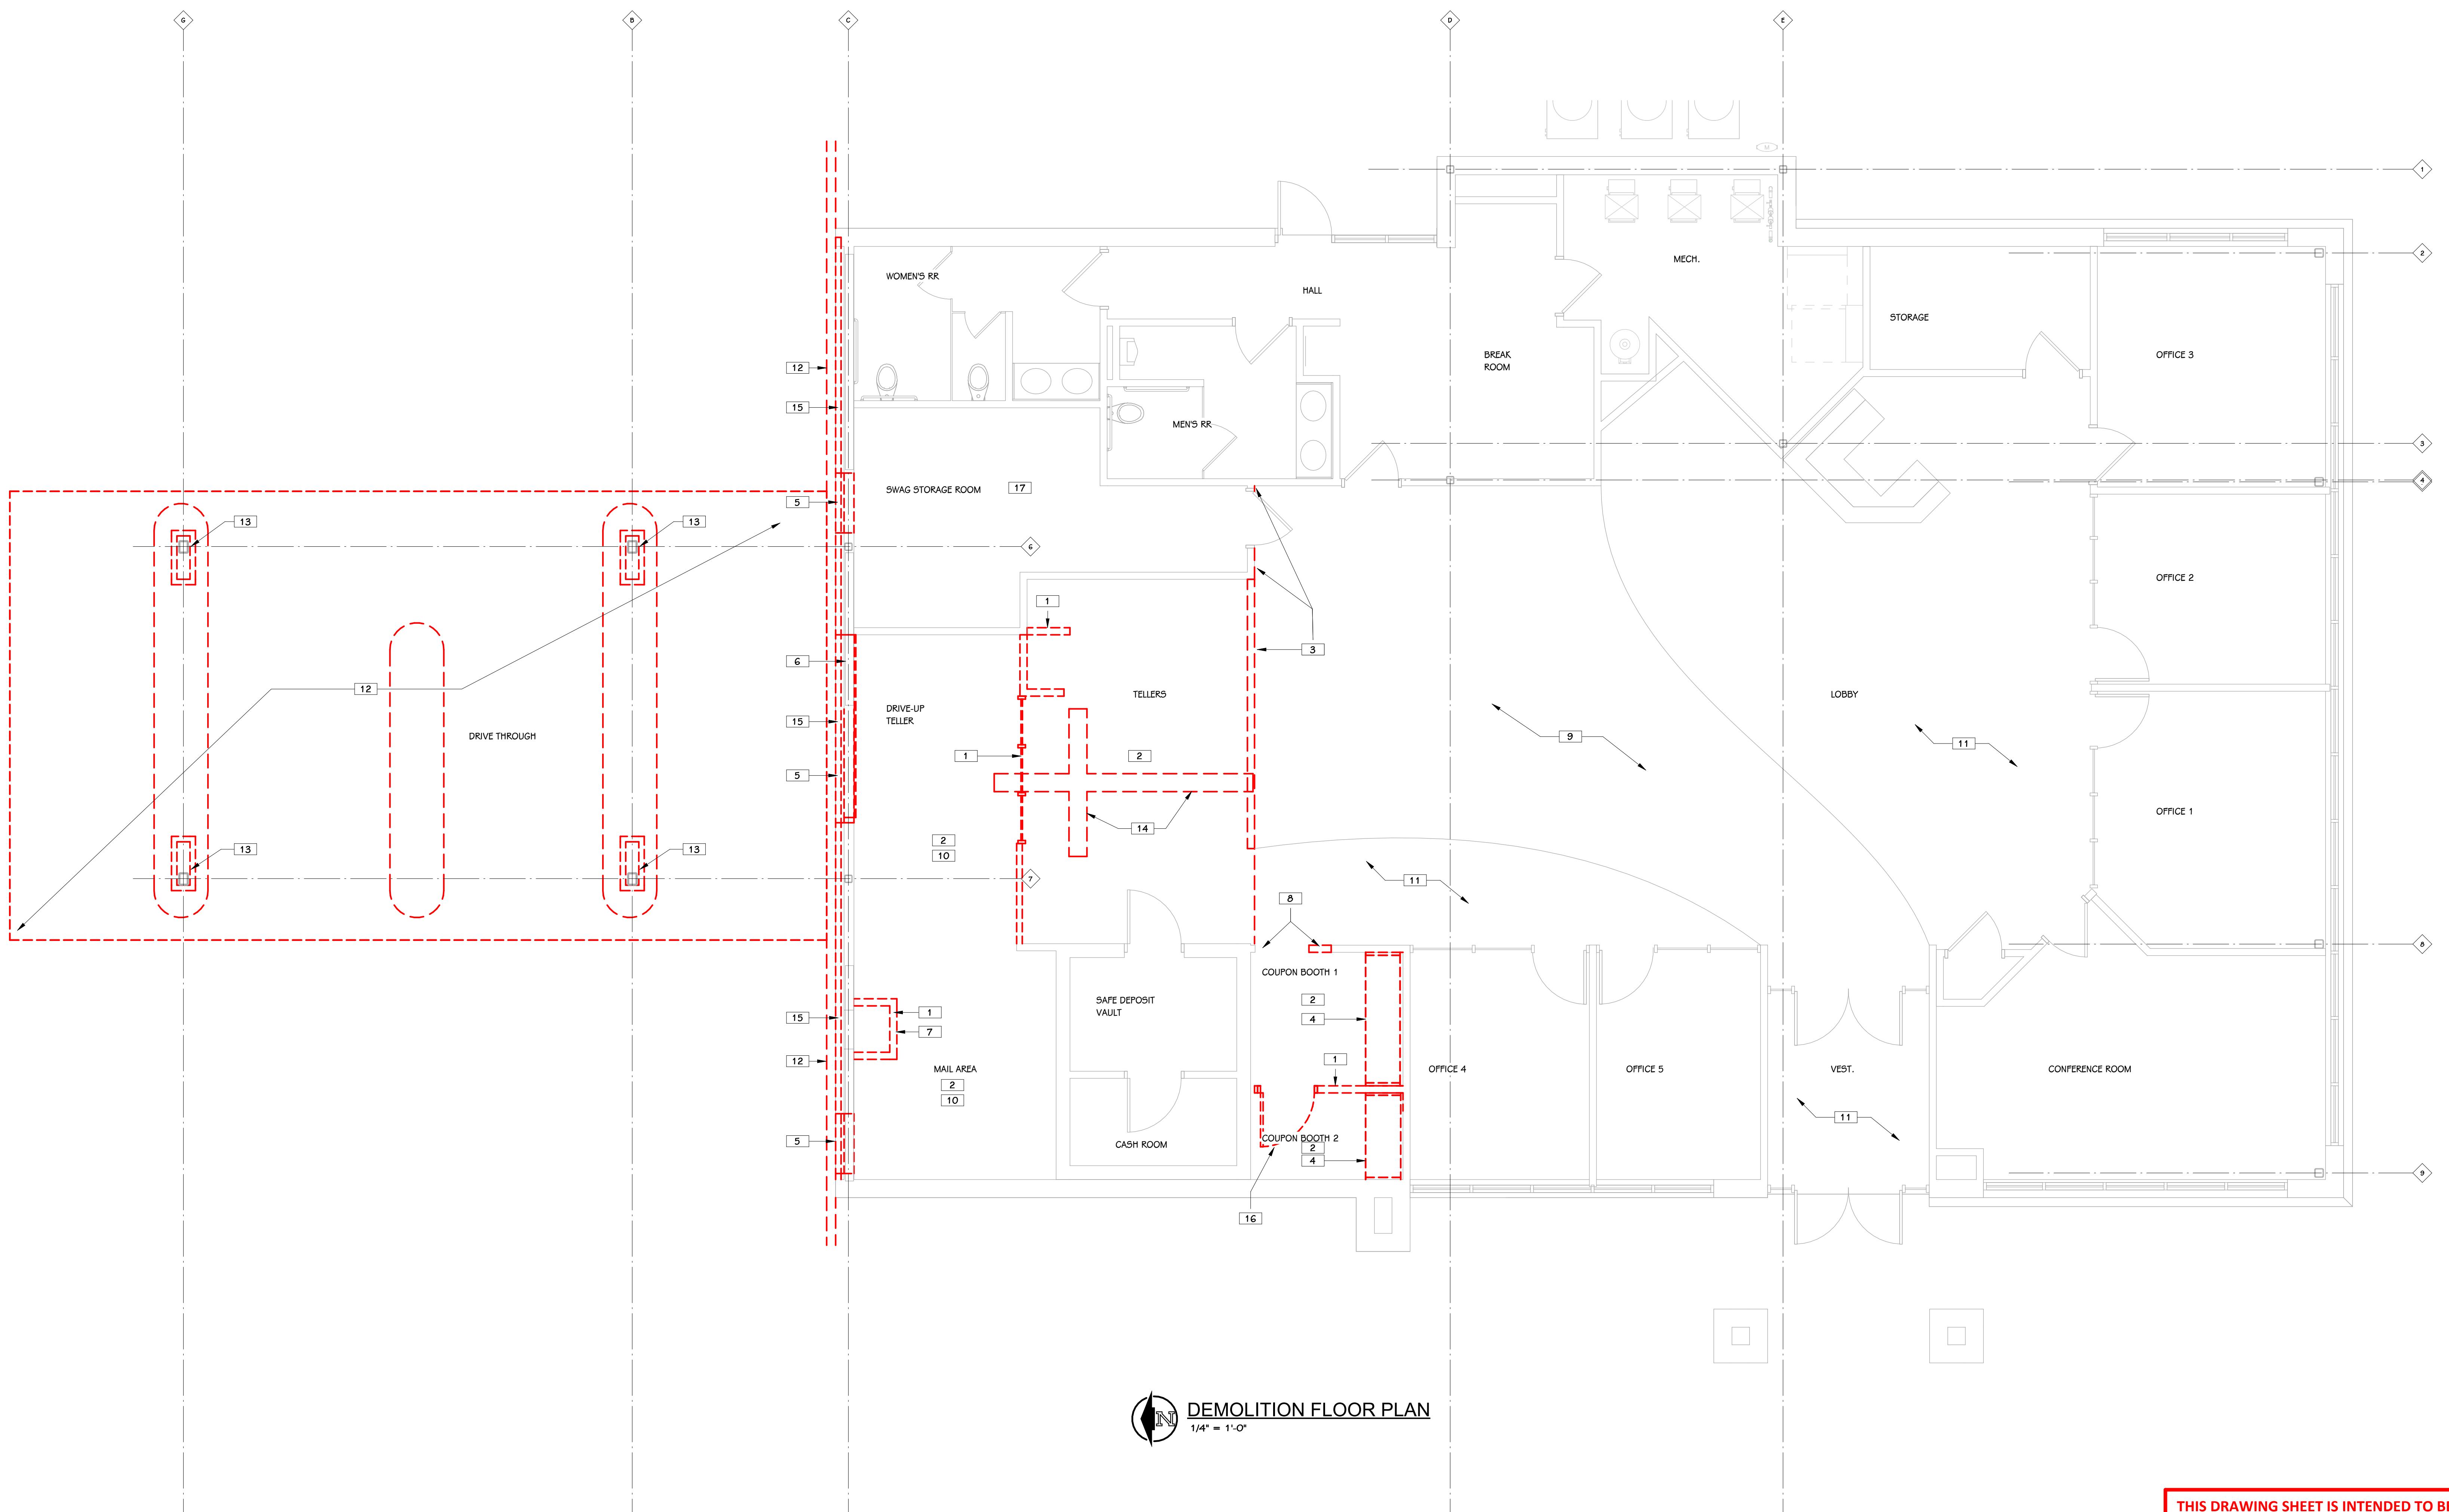


KEYED NOTED - ARCHITECTURAL ROOF - DEMOLITION	
1	REMOVE EXISTING CANOPY COMPLETE INCLUDING BUT NOT LIMITED TO COLUMNS, BRICK MASONRY PIERs, LIGHTING FIXTURES, ETC. REFER TO MECHANICAL, ELECTRICAL AND PLUMBING DRAWINGS FOR ADDITIONAL INFORMATION. CONTRACTOR SHALL MAINTAIN WEATHERPROOF BUILDING ENVELOPE DURING DEMOLITION WORK AND DURING THE DURATION OF THE CONSTRUCTION OF THE NEW ADDITION. COORDINATE ANY SHUT DOWN TIME OF EXISTING BUILDING SYSTEMS WITH THE OWNER TO MINIMIZE DISRUPTION OF OWNERS DAILY OPERATIONS.
2	REMOVE EXISTING ROOF OVERHANG COMPLETE INCLUDING BUT NOT LIMITED TO LIGHTING FIXTURES, ETC. REFER TO MECHANICAL, ELECTRICAL AND PLUMBING DRAWINGS FOR ADDITIONAL INFORMATION. CONTRACTOR SHALL MAINTAIN WEATHERPROOF BUILDING ENVELOPE DURING DEMOLITION WORK AND DURING THE DURATION OF THE CONSTRUCTION OF THE NEW ADDITION. COORDINATE ANY SHUT DOWN TIME OF EXISTING BUILDING SYSTEMS WITH THE OWNER TO MINIMIZE DISRUPTION OF OWNERS DAILY OPERATIONS.

PROJECT TITLE	ISSUED FOR	DATE
TEAMSTERS LOCAL 2727 BUILDING ADDITION		
	HEATHER D. GREEN	8728 COMMONWEALTH OF KENTUCKY ARCHITECT
	<i>Heather D. Green</i>	
OWNER	TEAMSTERS LOCAL 2727	
SHEET TITLE	DEMOLITION ROOF PLAN	
SHEET NUMBER	AD 102	JANUARY 9, 2026
DATE		
4810 N Preston Hwy Shepherdsville, KY		

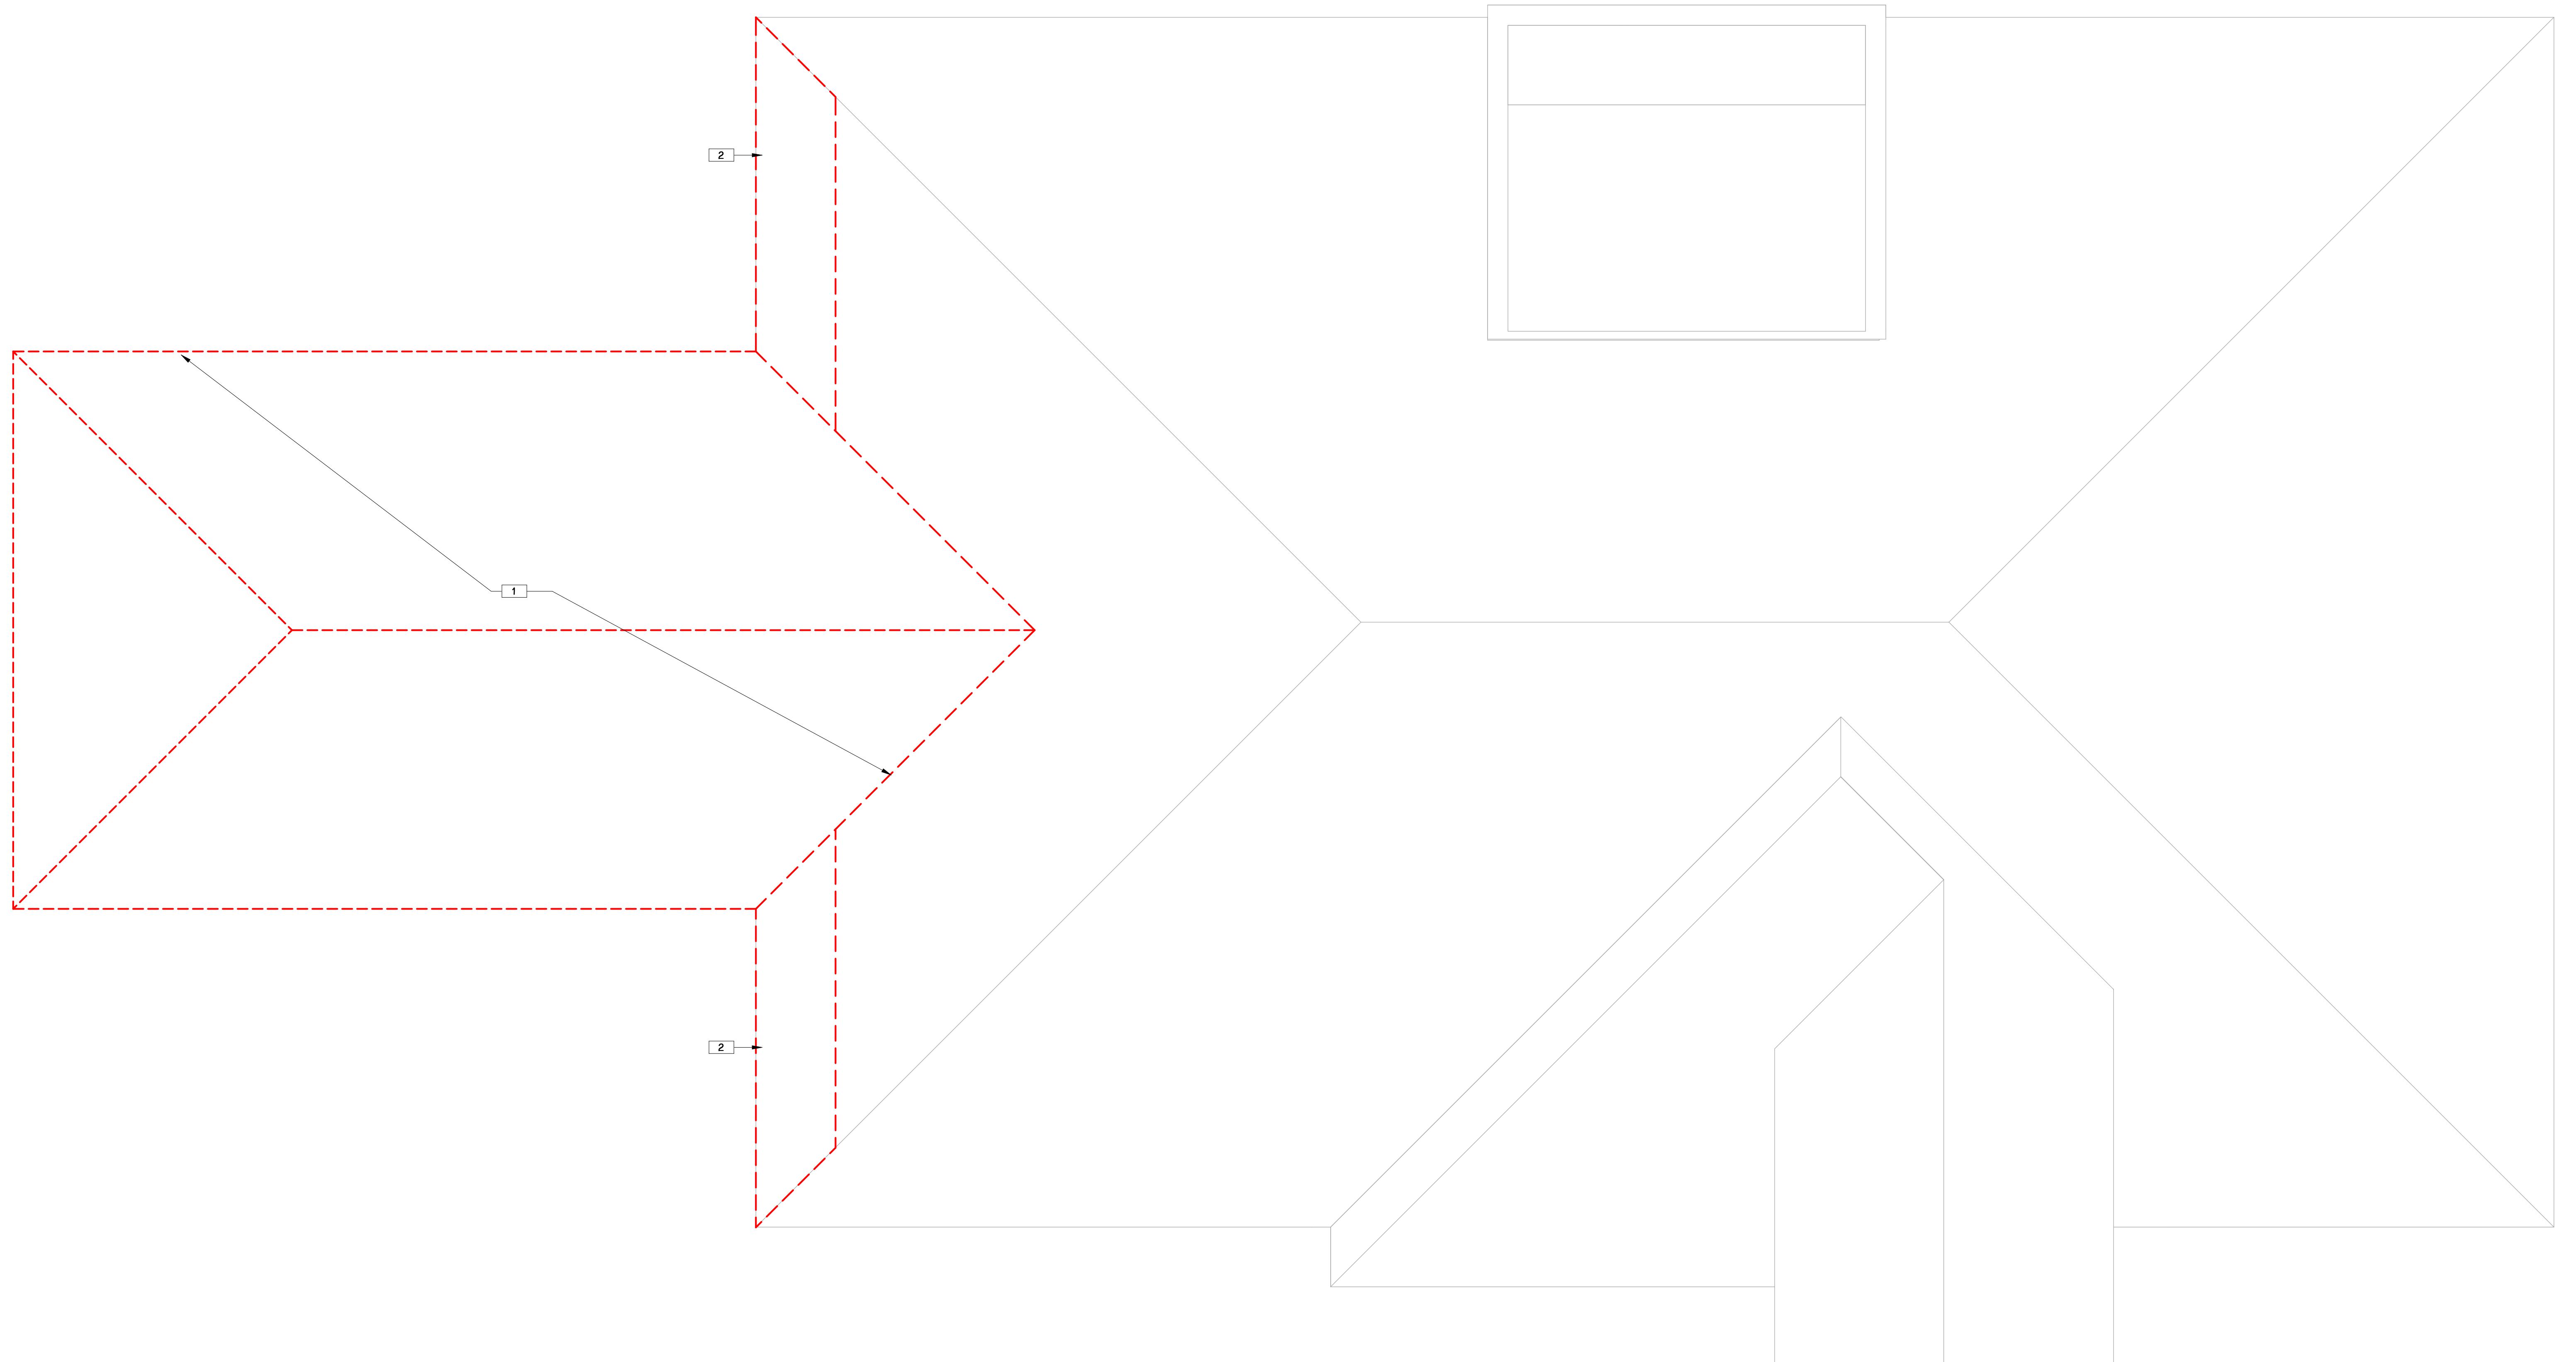

OVERALL ROOF DEMOLITION PLAN
1/4" = 1'-0"

THIS DRAWING SHEET IS INTENDED TO BE PLOTTED IN COLOR. IF THIS TEXT APPEARS IN BLACK AND WHITE, IT IS PLOTTED INCORRECTLY. DISCARD AND OBTAIN AN ACCURATE DRAWING

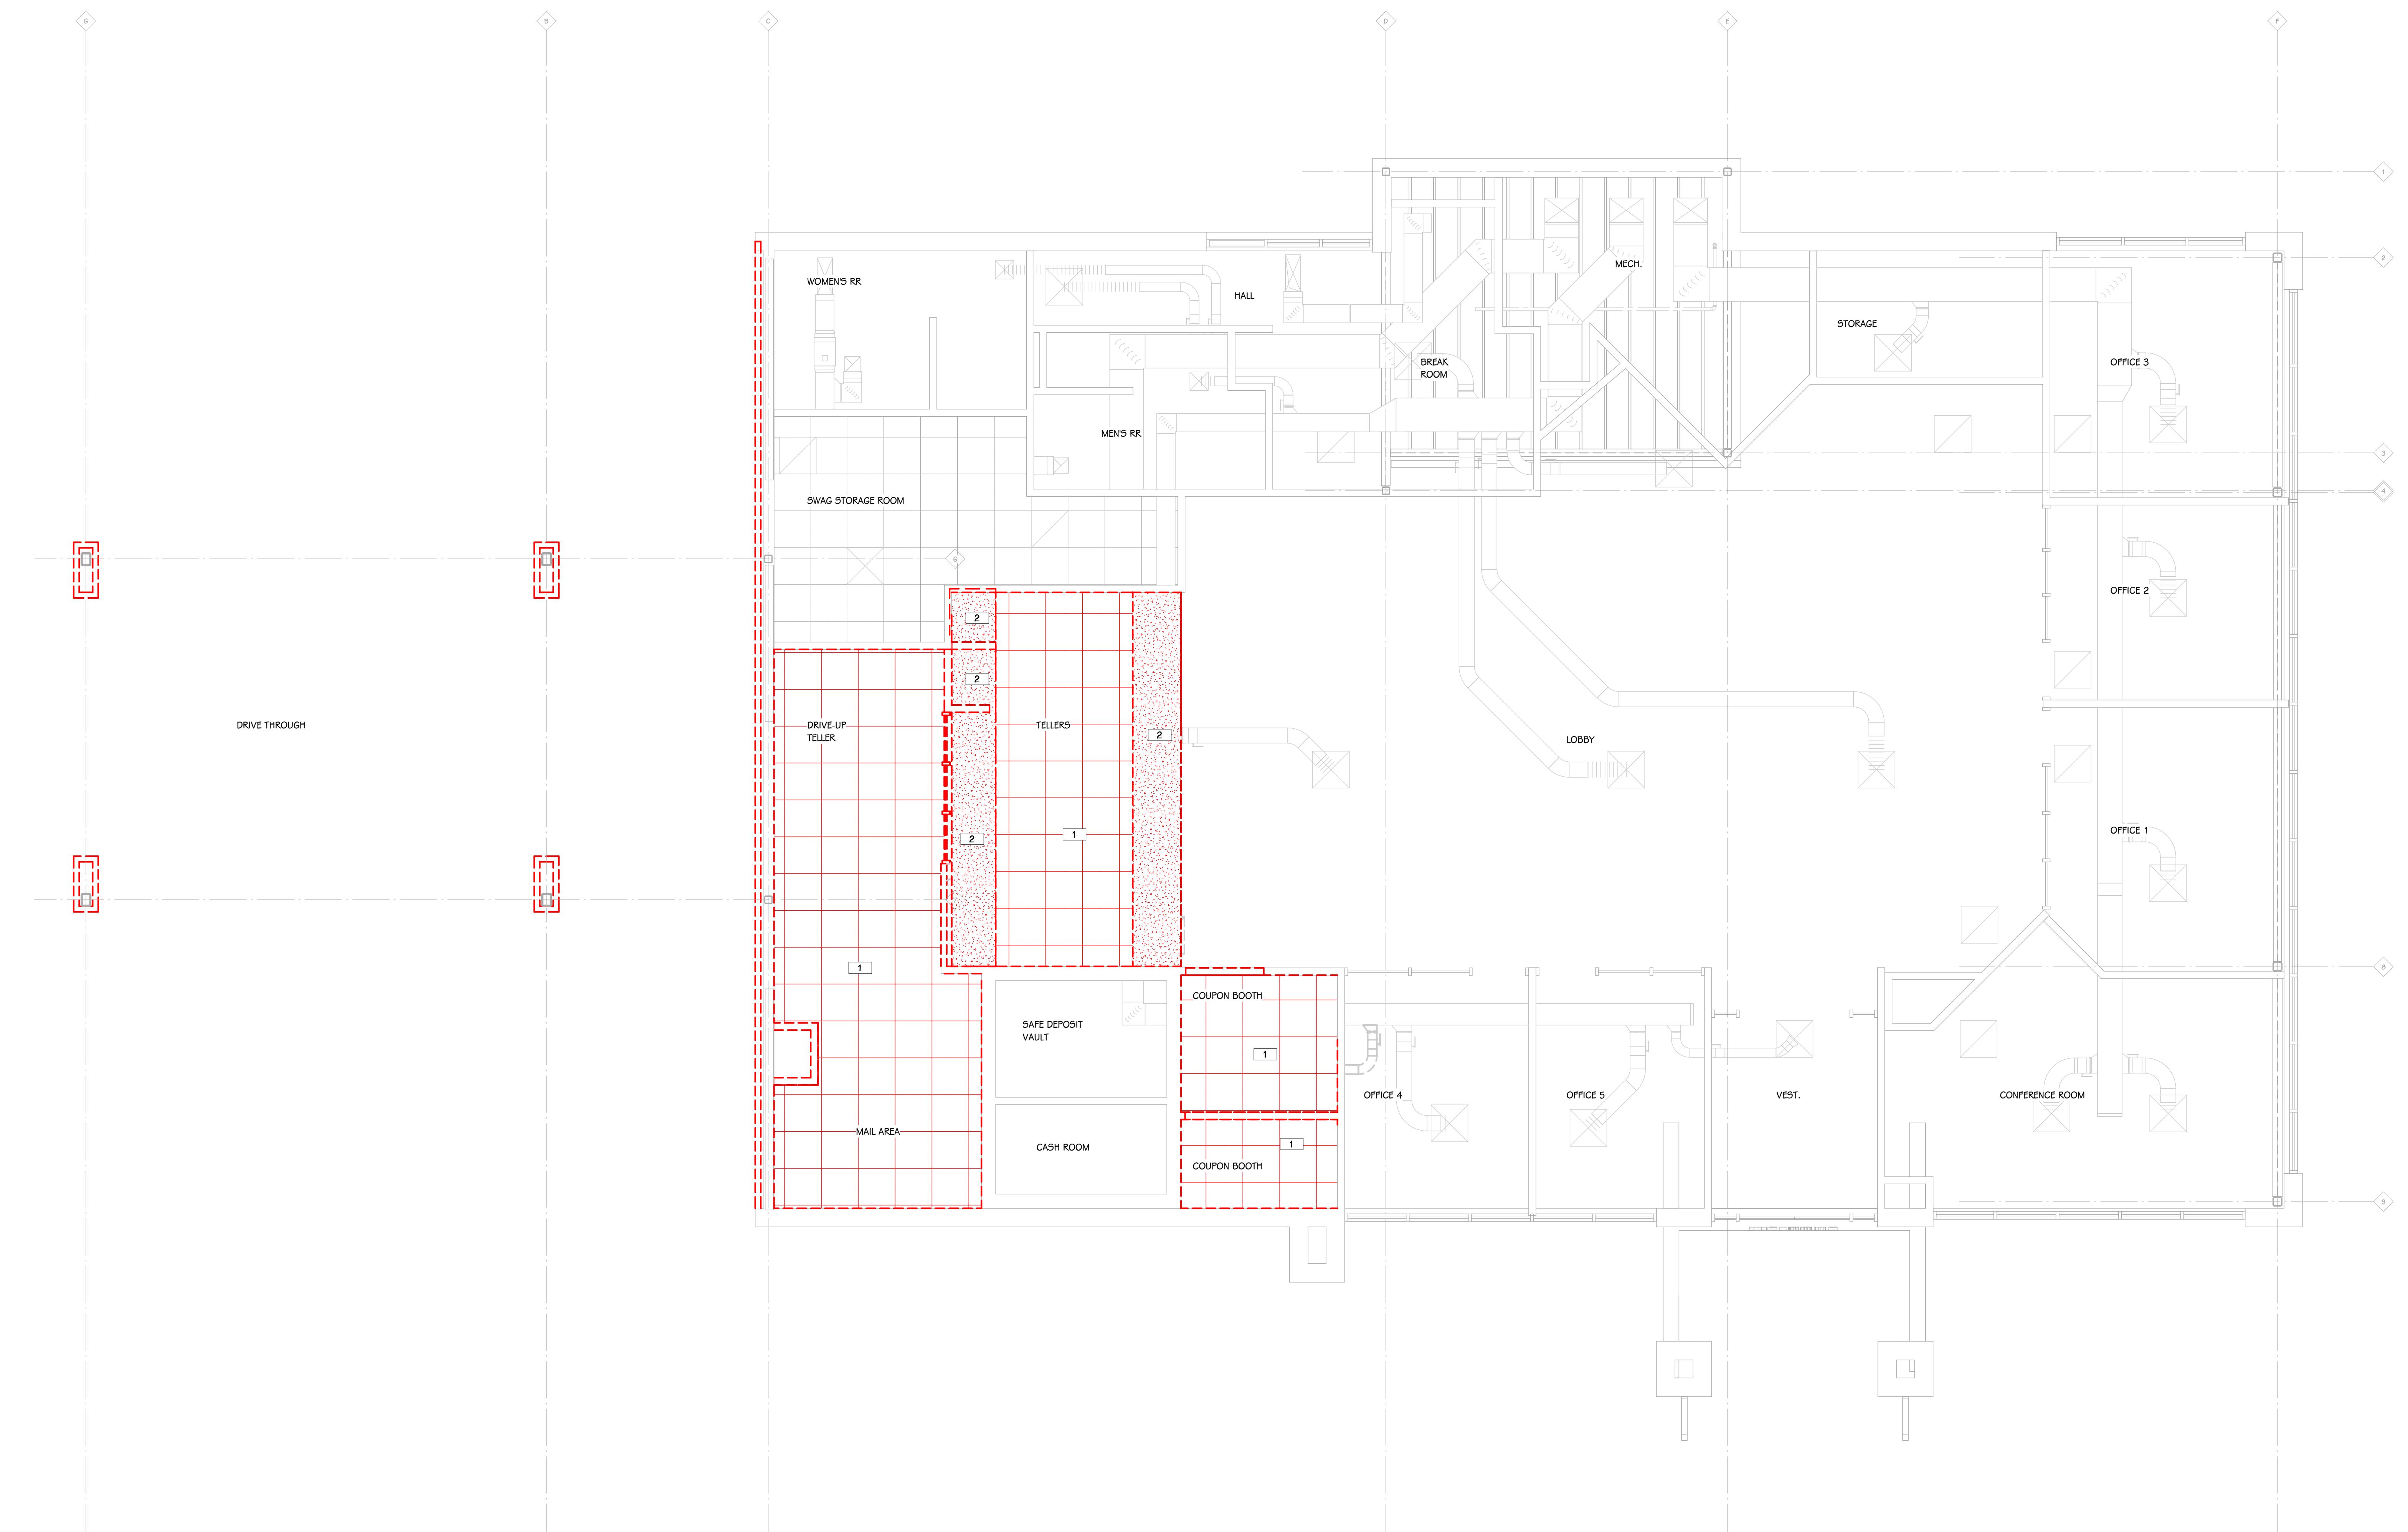

DEMOLITION REFLECTED CEILING PLAN

1/4" = 1'-0"

KEYED NOTES - REFLECTED CEILINGS - DEMOLITION	
1	COMPLETELY REMOVE CEILING TILE AND GRID SYSTEM FROM ENTIRE ROOM. SALVAGE CEILING TILE & REINSTALL IN NEW GRID. PROVIDE TEMPORARY SUPPORTS AS REQUIRED TO EXISTING STRUCTURE FOR LIGHTS, INTERCOM SPEAKERS, ETC. SEE ELECTRICAL, MECHANICAL, AND PLUMBING FOR ADDITION.
2	COMPLETELY REMOVE GYPSUM BOARD SOFFIT (INCLUDING ASSOCIATED FRAMING) IN ITS ENTIRETY.

PROJECT TITLE	OWNER	DATE
TEAMSTERS LOCAL 2727	TEAMSTERS LOCAL 2727	
BUILDING ADDITION		
	4810 N Preston Hwy Shepherdsville, KY	
SHEET TITLE		
DEMOLITION REFLECTED CEILING PLAN		
SHEET NUMBER		
AD 376.001		
DATE		
JANUARY 9, 2026		

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PROJECT TITLE
TEAMSTERS LOCAL 2727
BUILDING ADDITION


OWNER
TEAMSTERS LOCAL 2727

SHEET TITLE
OVERALL FLOOR PLAN
KEY PLAN

4810 N Preston Hwy
Shepherdsville, KY

DATE
JANUARY 9, 2026

SHEET NUMBER
A-100
25-376.000

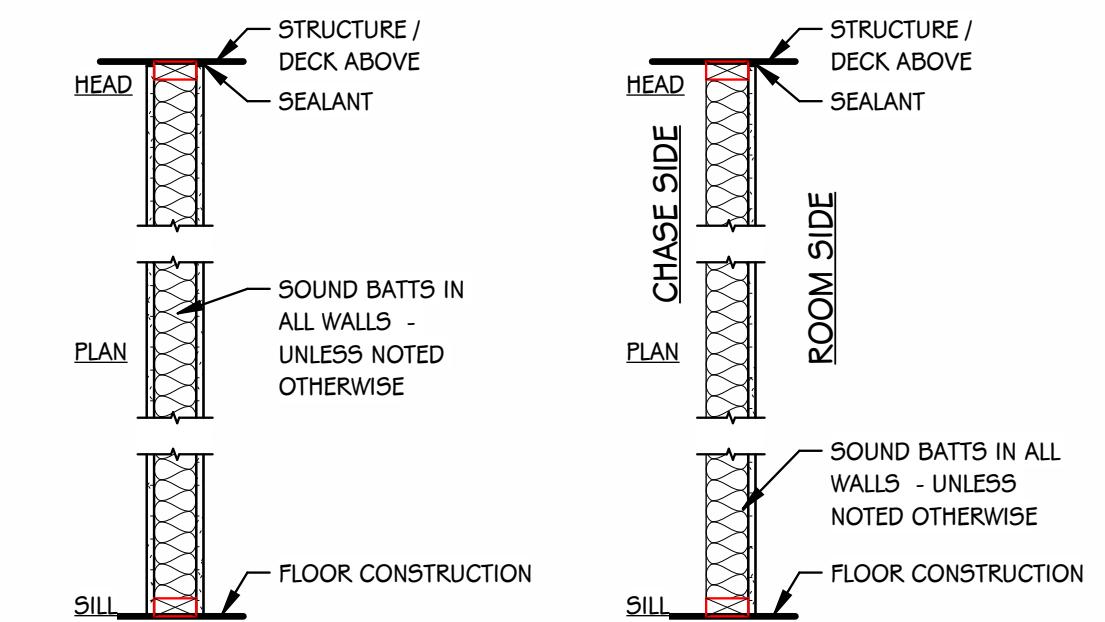

[14x] WOOD STUDS @ 16" O.C. WITH 5/8" GYPSUM BOARD BOTH SIDES; (1 HOUR FIRE) U.L. ASSEMBLY US05 WHERE NOTED ON PLANS


WOOD STUD WALL

[15x] WOOD STUDS @ 16" O.C. WITH 5/8" GYPSUM BOARD ON ROOM SIDE - BRACE WALL @ 4'-0" O.C. MAXIMUM.

WOOD STUD CHASE WALL

INTERIOR PARTITION TYPES

3/4" = 1'-0"

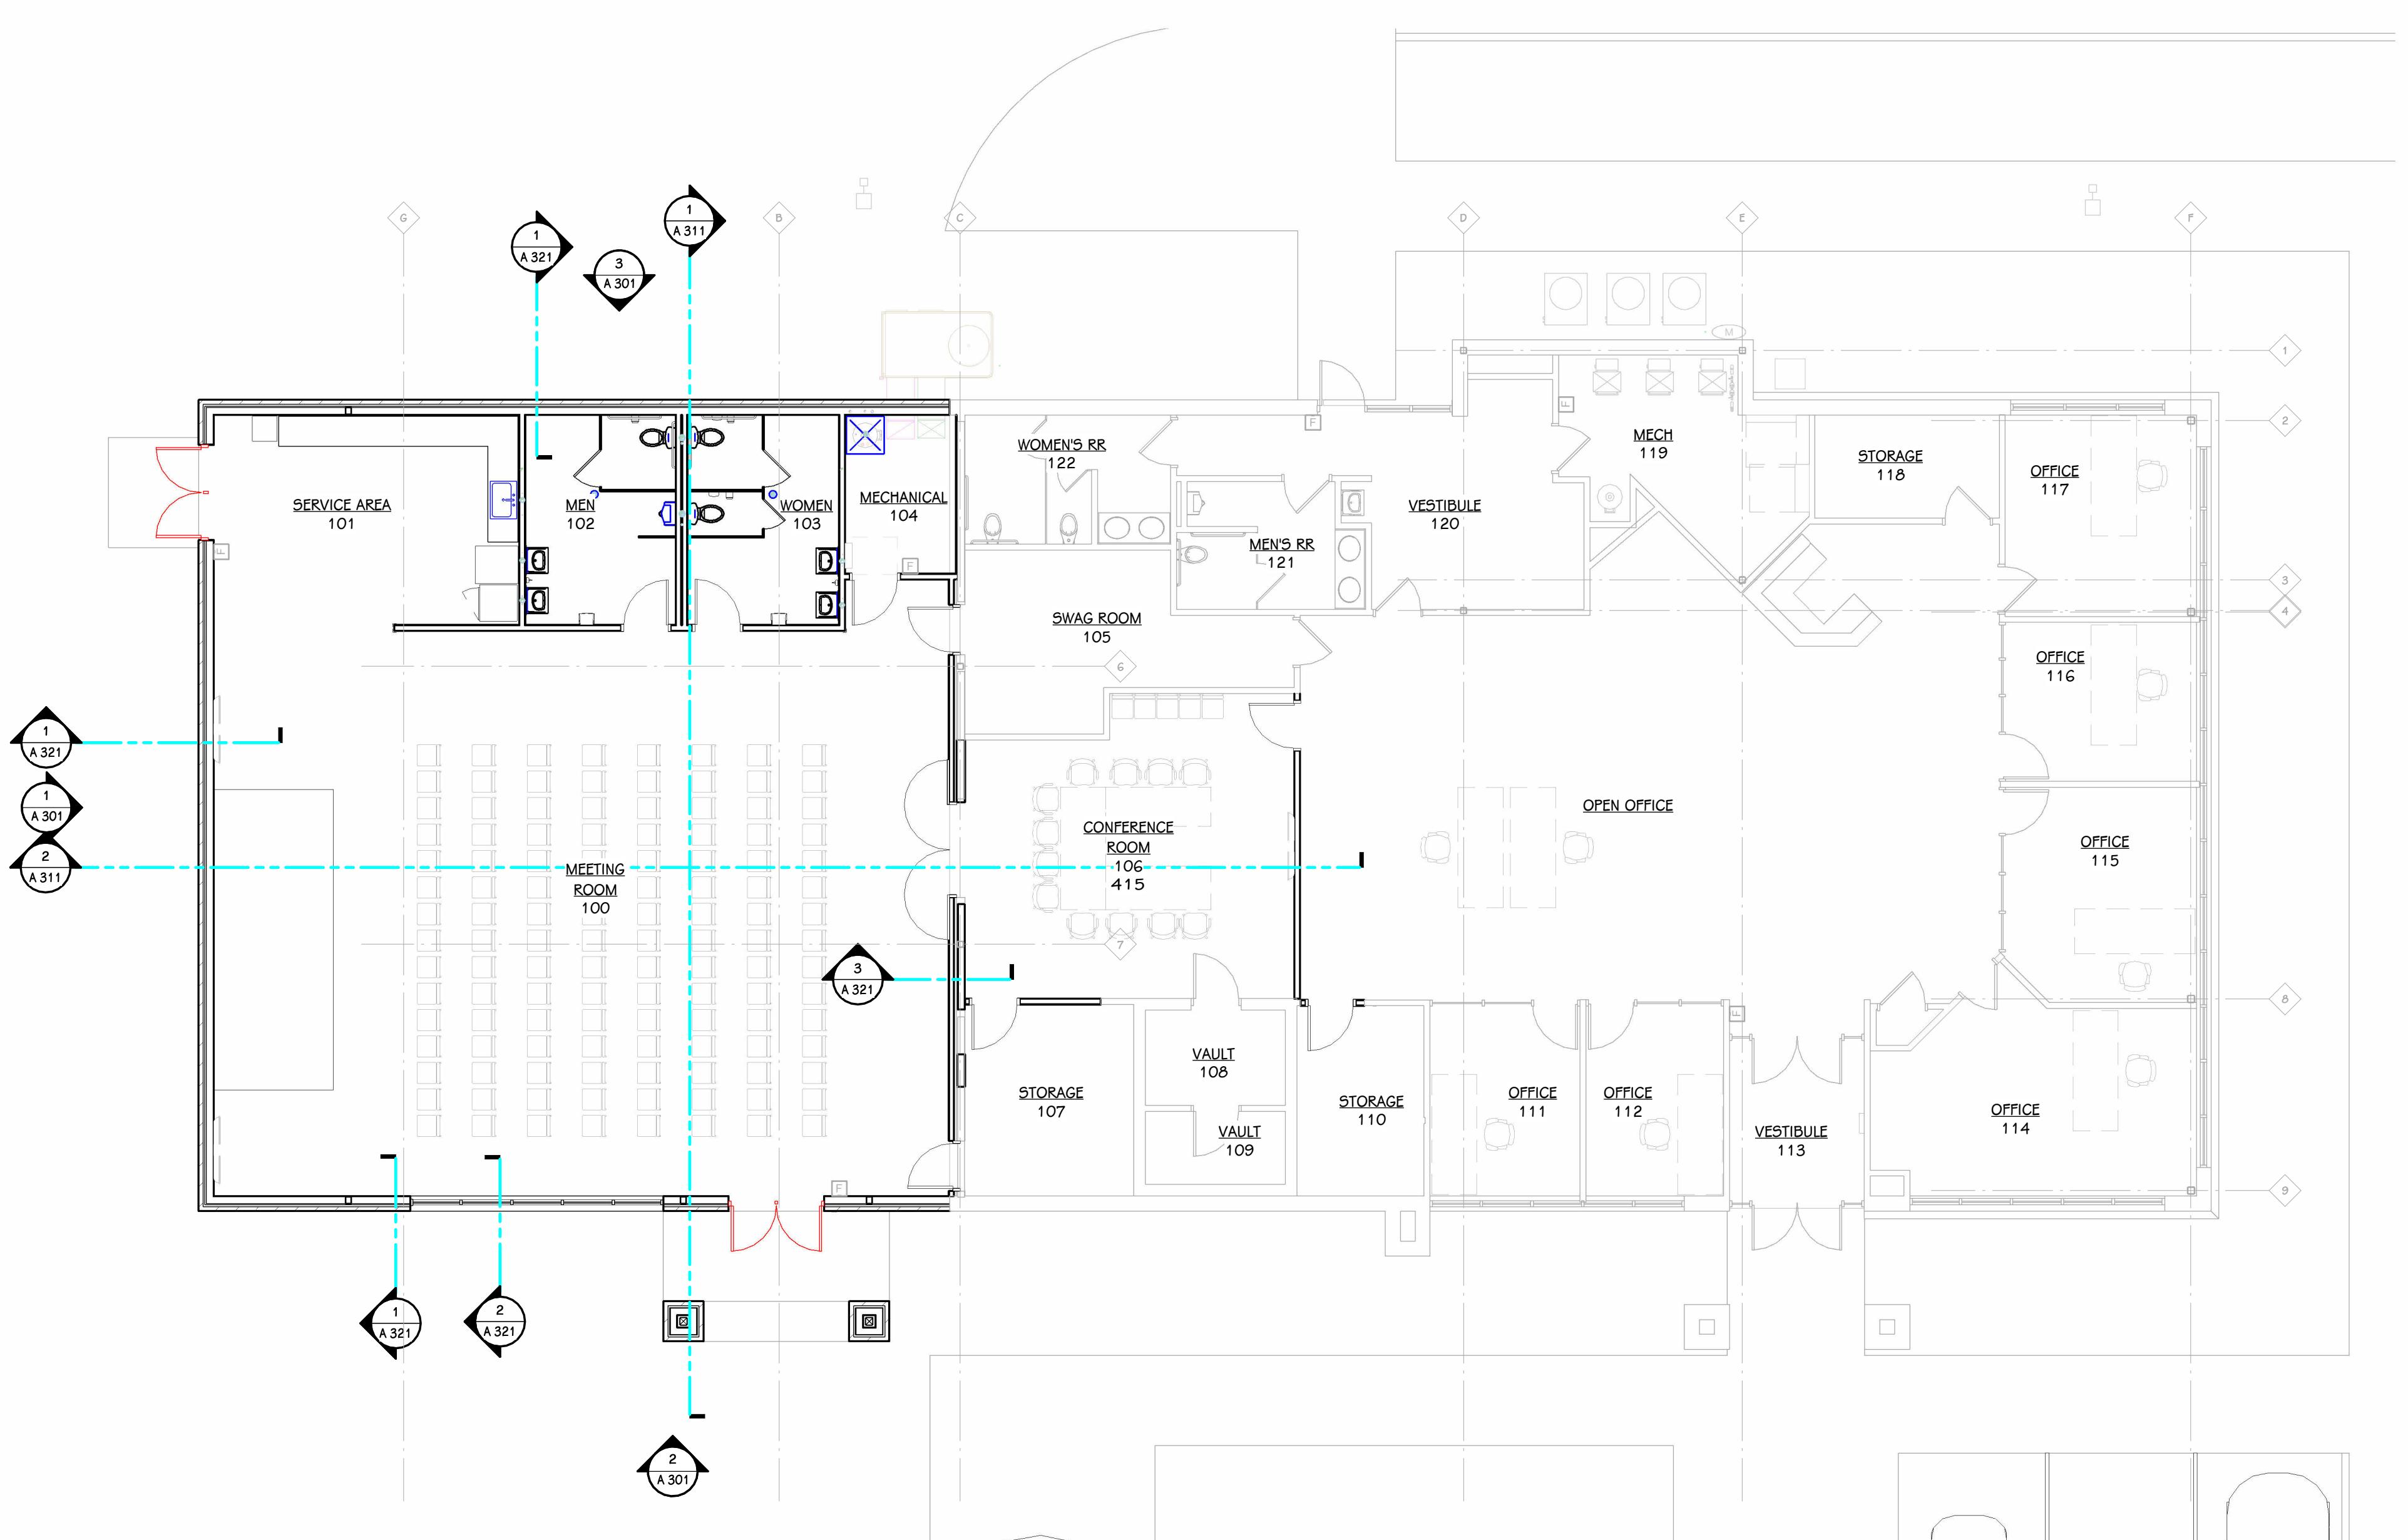

OVERALL FLOOR PLAN
1/8" = 1'-0"

NOTES - ARCHITECTURAL

- 1 REFER TO CODE COMPLIANCE PLAN FOR WALL RATING LINES.
- 2 REFER TO SHEET A401 FOR INTERIOR ELEVATION CALLOUTS.
- 3 REFER TO SHEET A 500's FOR WALL AND CEILING ACCESS55 PANEL INFORMATION.
- 4 ALL FURNITURE SHOWN IS FOR REFERENCE ONLY.

GENERAL NOTES - ARCHITECTURAL - PARTITIONS

GENERAL NOTES - ARCHITECTURAL - NEW CONSTRUCTION

PARTITION STUD KEY - METAL, CH, AND WOOD

METAL STUD/FURRING DESIGNATION	SIZE
A	GYPSUM BOARD DIRECT APPLIED TO CMU
B	7/8"
C	1 1/2"
D	1 5/8"
E	2 1/2"
F	3 1/2"
G	3 5/8"
H	4"
J	5 1/2"
K	6"
L	8"
M	10"
N	12"
P	OPEN
Q	OPEN


METAL STUD/FURRING DESIGNATION	SIZE
R	2 1/2"
S	4"
T	6"

WOOD STUD/FURRING DESIGNATION	SIZE
U	2"x4"
V	2"x6"
W	2"x8"

PARTITION TYPE TAG (REFER TO FLOOR PLANS)
PARTITION TYPE NUMBER — STUD SIZE DESIGNATION
FIRE RATING, IF REQUIRED

ISSUED FOR
DATE
HEATHER D. GRANGER
8728
COMMONWEALTH OF
KENTUCKY
ARCHITECT
Heather D. Granger

TEAMSTERS LOCAL 2727

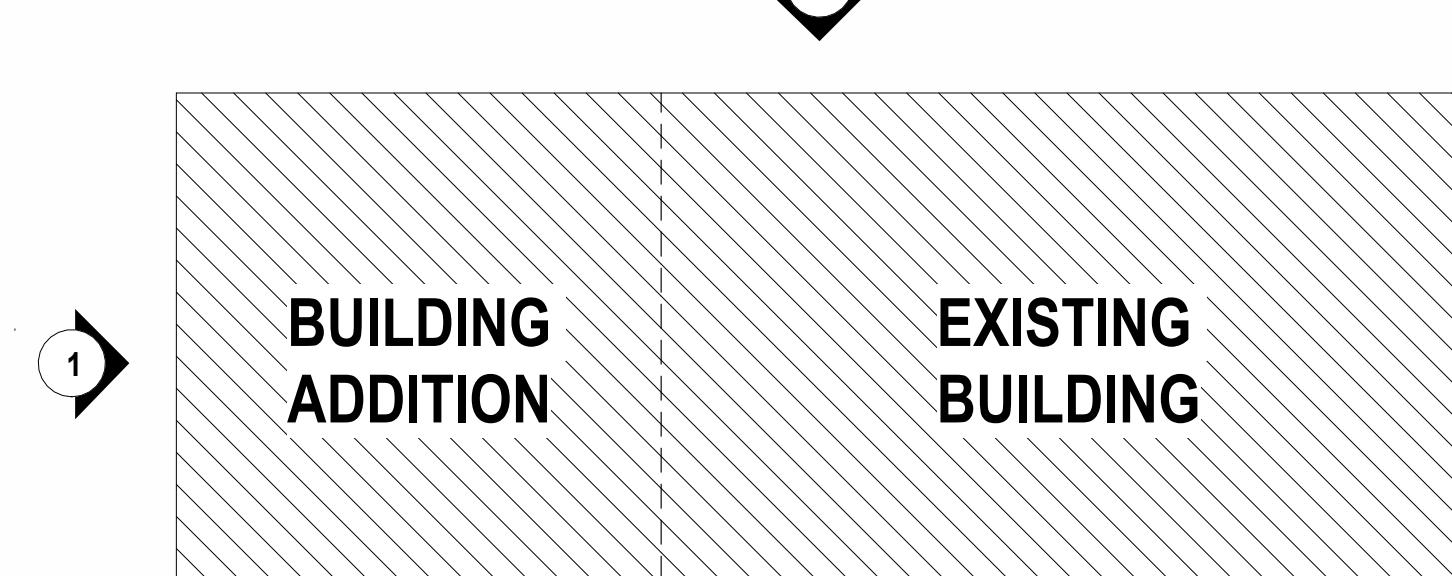

KEY PLAN

TowerPinkster

Architecture · Engineering · Interiors


TOWERPINKSTER.COM
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PROJECT TITLE
TEAMSTERS LOCAL 2727
BUILDING ADDITION

OWNER
TEAMSTERS LOCAL 2727
4810 N Preston Hwy
Shepherdsville, KY

SHEET TITLE
FLOOR PLAN - ADDITION
KEY PLAN
SHEET NUMBER
A-101
25-376.000

DATE
JANUARY 9, 2026

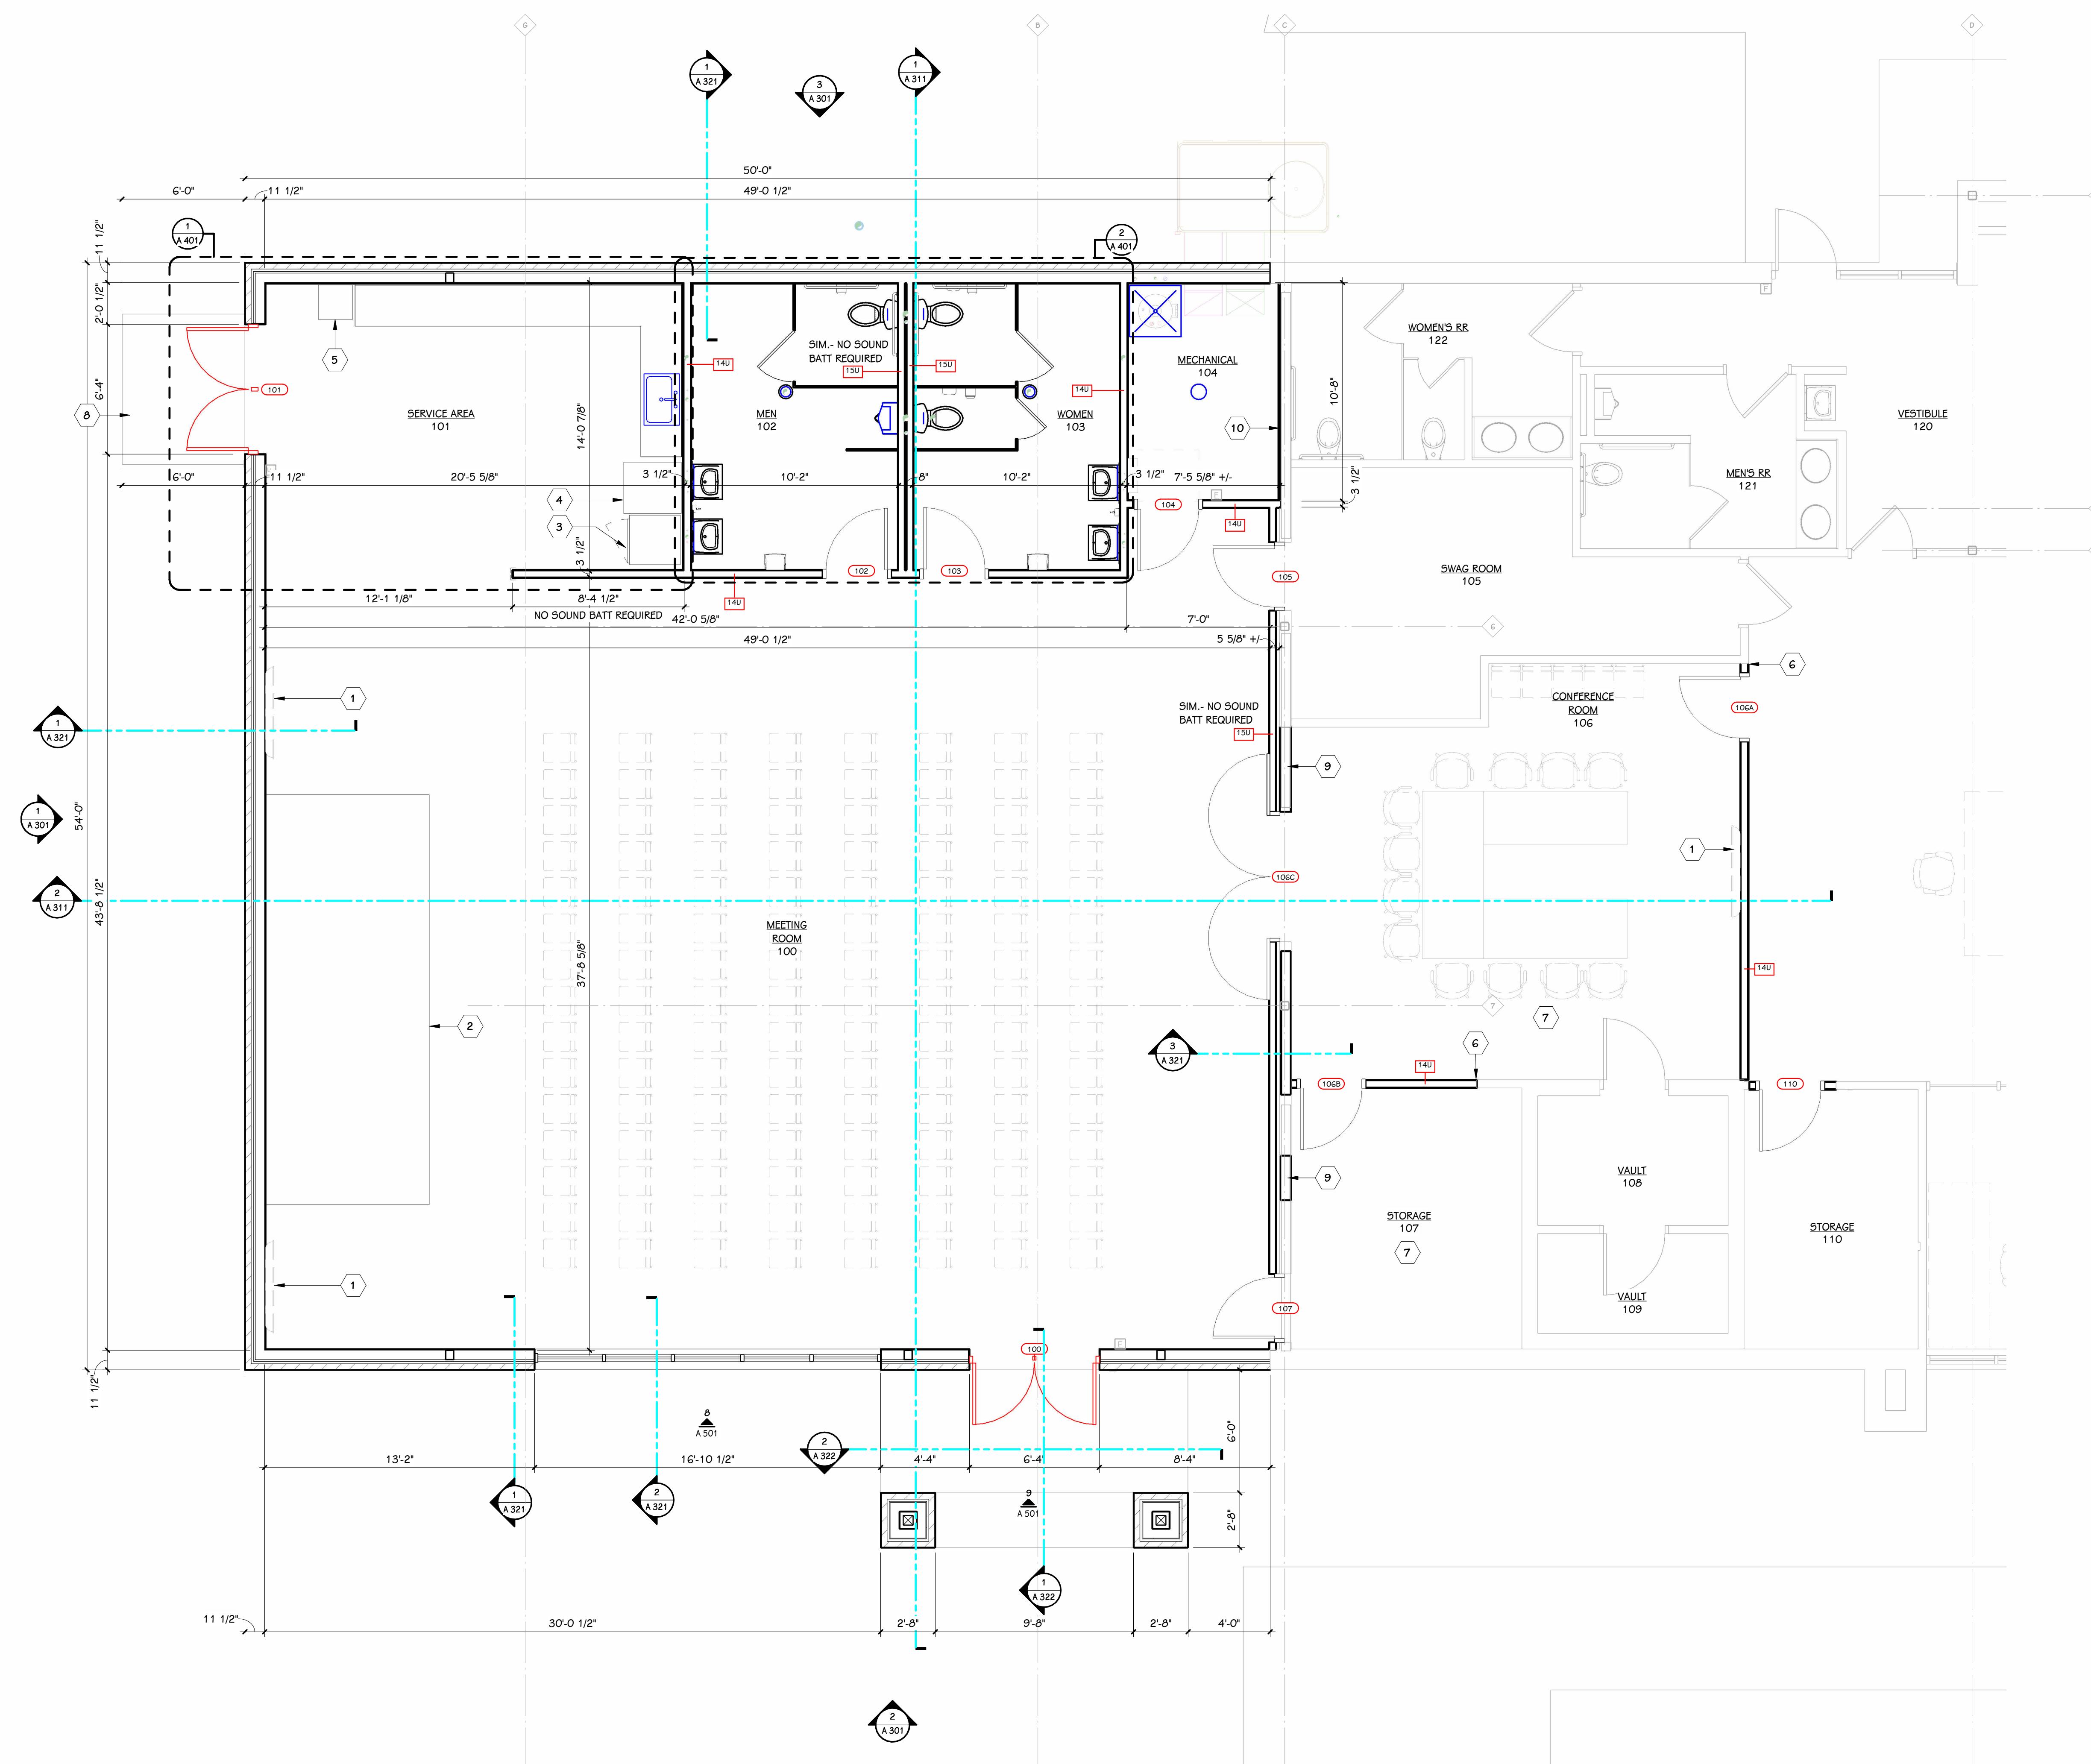

NOTES - ARCHITECTURAL	
1	REFER TO CODE COMPLIANCE PLAN FOR WALL RATING LINES.
2	REFER TO SHEET A401 FOR INTERIOR ELEVATION CALLOUTS.
3	REFER TO SHEET A500 FOR WALL AND CEILING ACCESS PANEL INFORMATION.
4	ALL FURNITURE SHOWN IS FOR REFERENCE ONLY.
KEYED NOTES - ARCHITECTURAL - CONSTRUCTION	
1	WALL MOUNTED TELEVISION, O.F.C.I. CONTRACTOR TO PROVIDE WOOD BLOCKING. CONTRACTOR TO VERIFY MOUNTING HEIGHT WITH THE OWNER.
2	PLATFORM, O.F.O.I.
3	COOLER, O.F.O.I.
4	ICE MACHINE, O.F.O.I.
5	FREESTANDING TRASHCAN, O.F.O.I.
6	FACE OF NEW GYPSUM WALL BOARD ON NEW PORTION OF WALL SHALL BE FLUSH WITH EXISTING GYPSUM WALL BOARD ON EXISTING WALL. BOTH SIDES IF APPLICABLE.
7	SKIM COAT ALL WALLS WHERE WALLCOVERING WAS REMOVED AS REQUIRED FOR NEW PAINTED WALL FINISH.
8	EXTERIOR CONCRETE SIDE WALK (SEE CIVIL).
9	INFILL EXISTING OPENING WITH MATCHING CONSTRUCTION AND PREP FOR NEW FINISH AS SCHEDULED.
10	5/8" GYPSUM WALL BOARD ON EXISTING FRAMING.

ISSUED FOR
HEATHER D. GREEN
8728
COMMONWEALTH OF KENTUCKY
ARCHITECT
Signature

DATE


PROJECT TITLE
TEAMSTERS LOCAL 2727
BUILDING ADDITION

 OWNER
TEAMSTERS LOCAL 2727
4810 N Preston Hwy
Shepherdsville, KY

SHEET NUMBER

 A 201
25-376.000

 REFLECTED CEILING PLAN - ADDITION
1/4" = 1'-0"

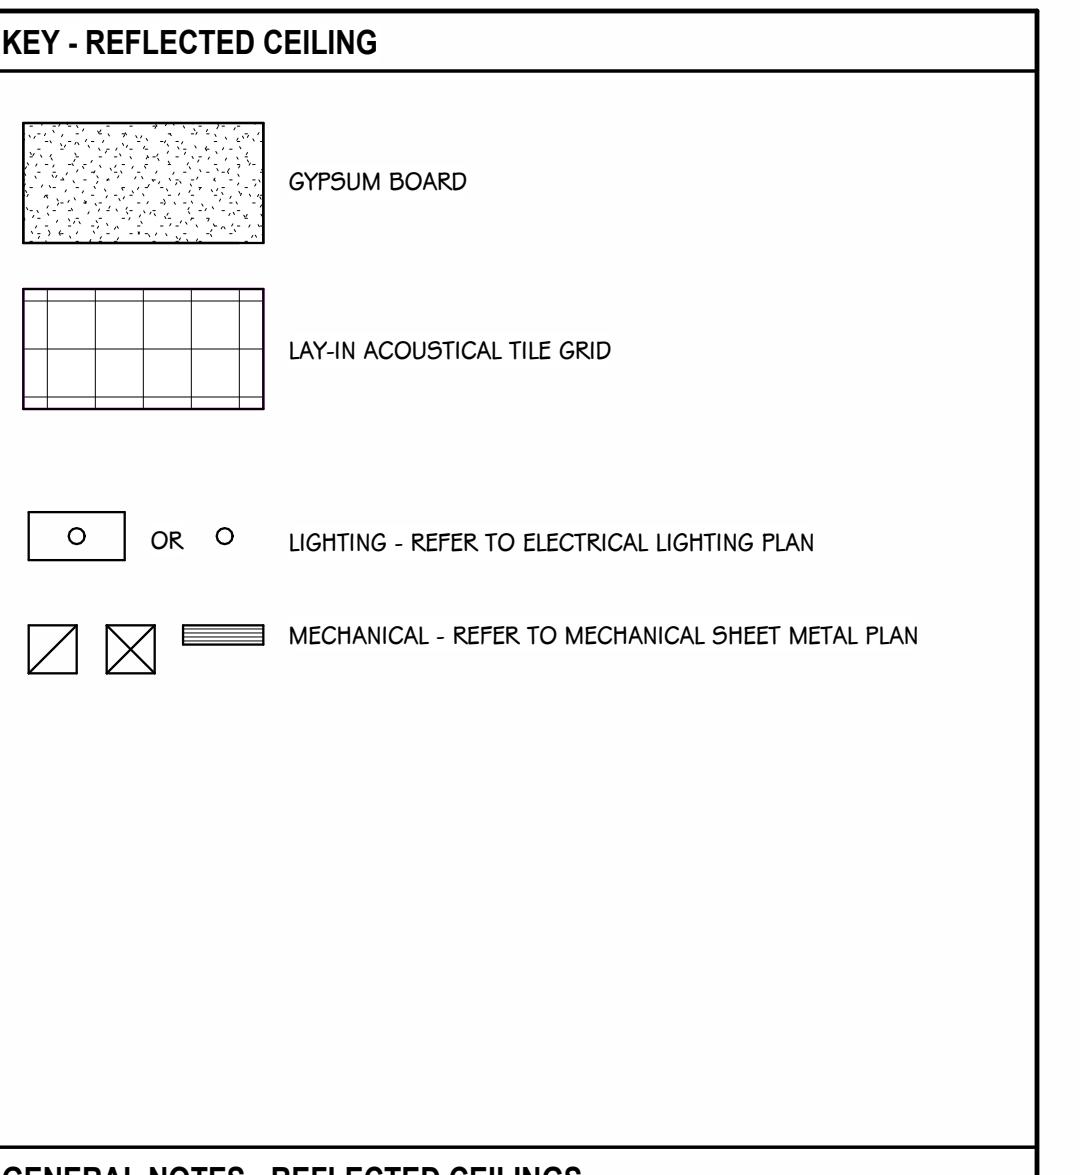 DATE
JANUARY 9, 2026


GENERAL NOTES - REFLECTED CEILINGS

- Refer to Mechanical, Electrical and Equipment Drawings for clarification of symbols used on the reflected ceiling plan to illustrate layout of items within ceiling system.
- All ceiling heights are to be as noted. Coordinate this finished ceiling height with all other trades, and with all mechanical, electrical and other equipment and items above ceiling.
- Unless specifically directed otherwise, locate all grilles, registers, diffusers, fixtures, or other such equipment flush with the ceiling surface and centered on tile.
- See Finish Plan for type and style of ceiling system.


KEYED NOTES - ARCHITECTURAL - REFLECTED CEILING

1 TEAMSTERS SINGLE LAYER METAL LOGO, APPROXIMATE SIZE: 12'-0" x 8'-0", O.F.C.I. CONTRACTOR TO COORDINATE WITH OWNER'S SUPPLIER FOR INSTALLATION.

ISSUED FOR
DATE
HEATHER D. GREEN
8728
COMMONWEALTH OF KENTUCKY
ARCHITECT
Signature

SECTION
A 201
1 1/2" = 1'-0"

SECTION
A 201
1 1/2" = 1'-0"

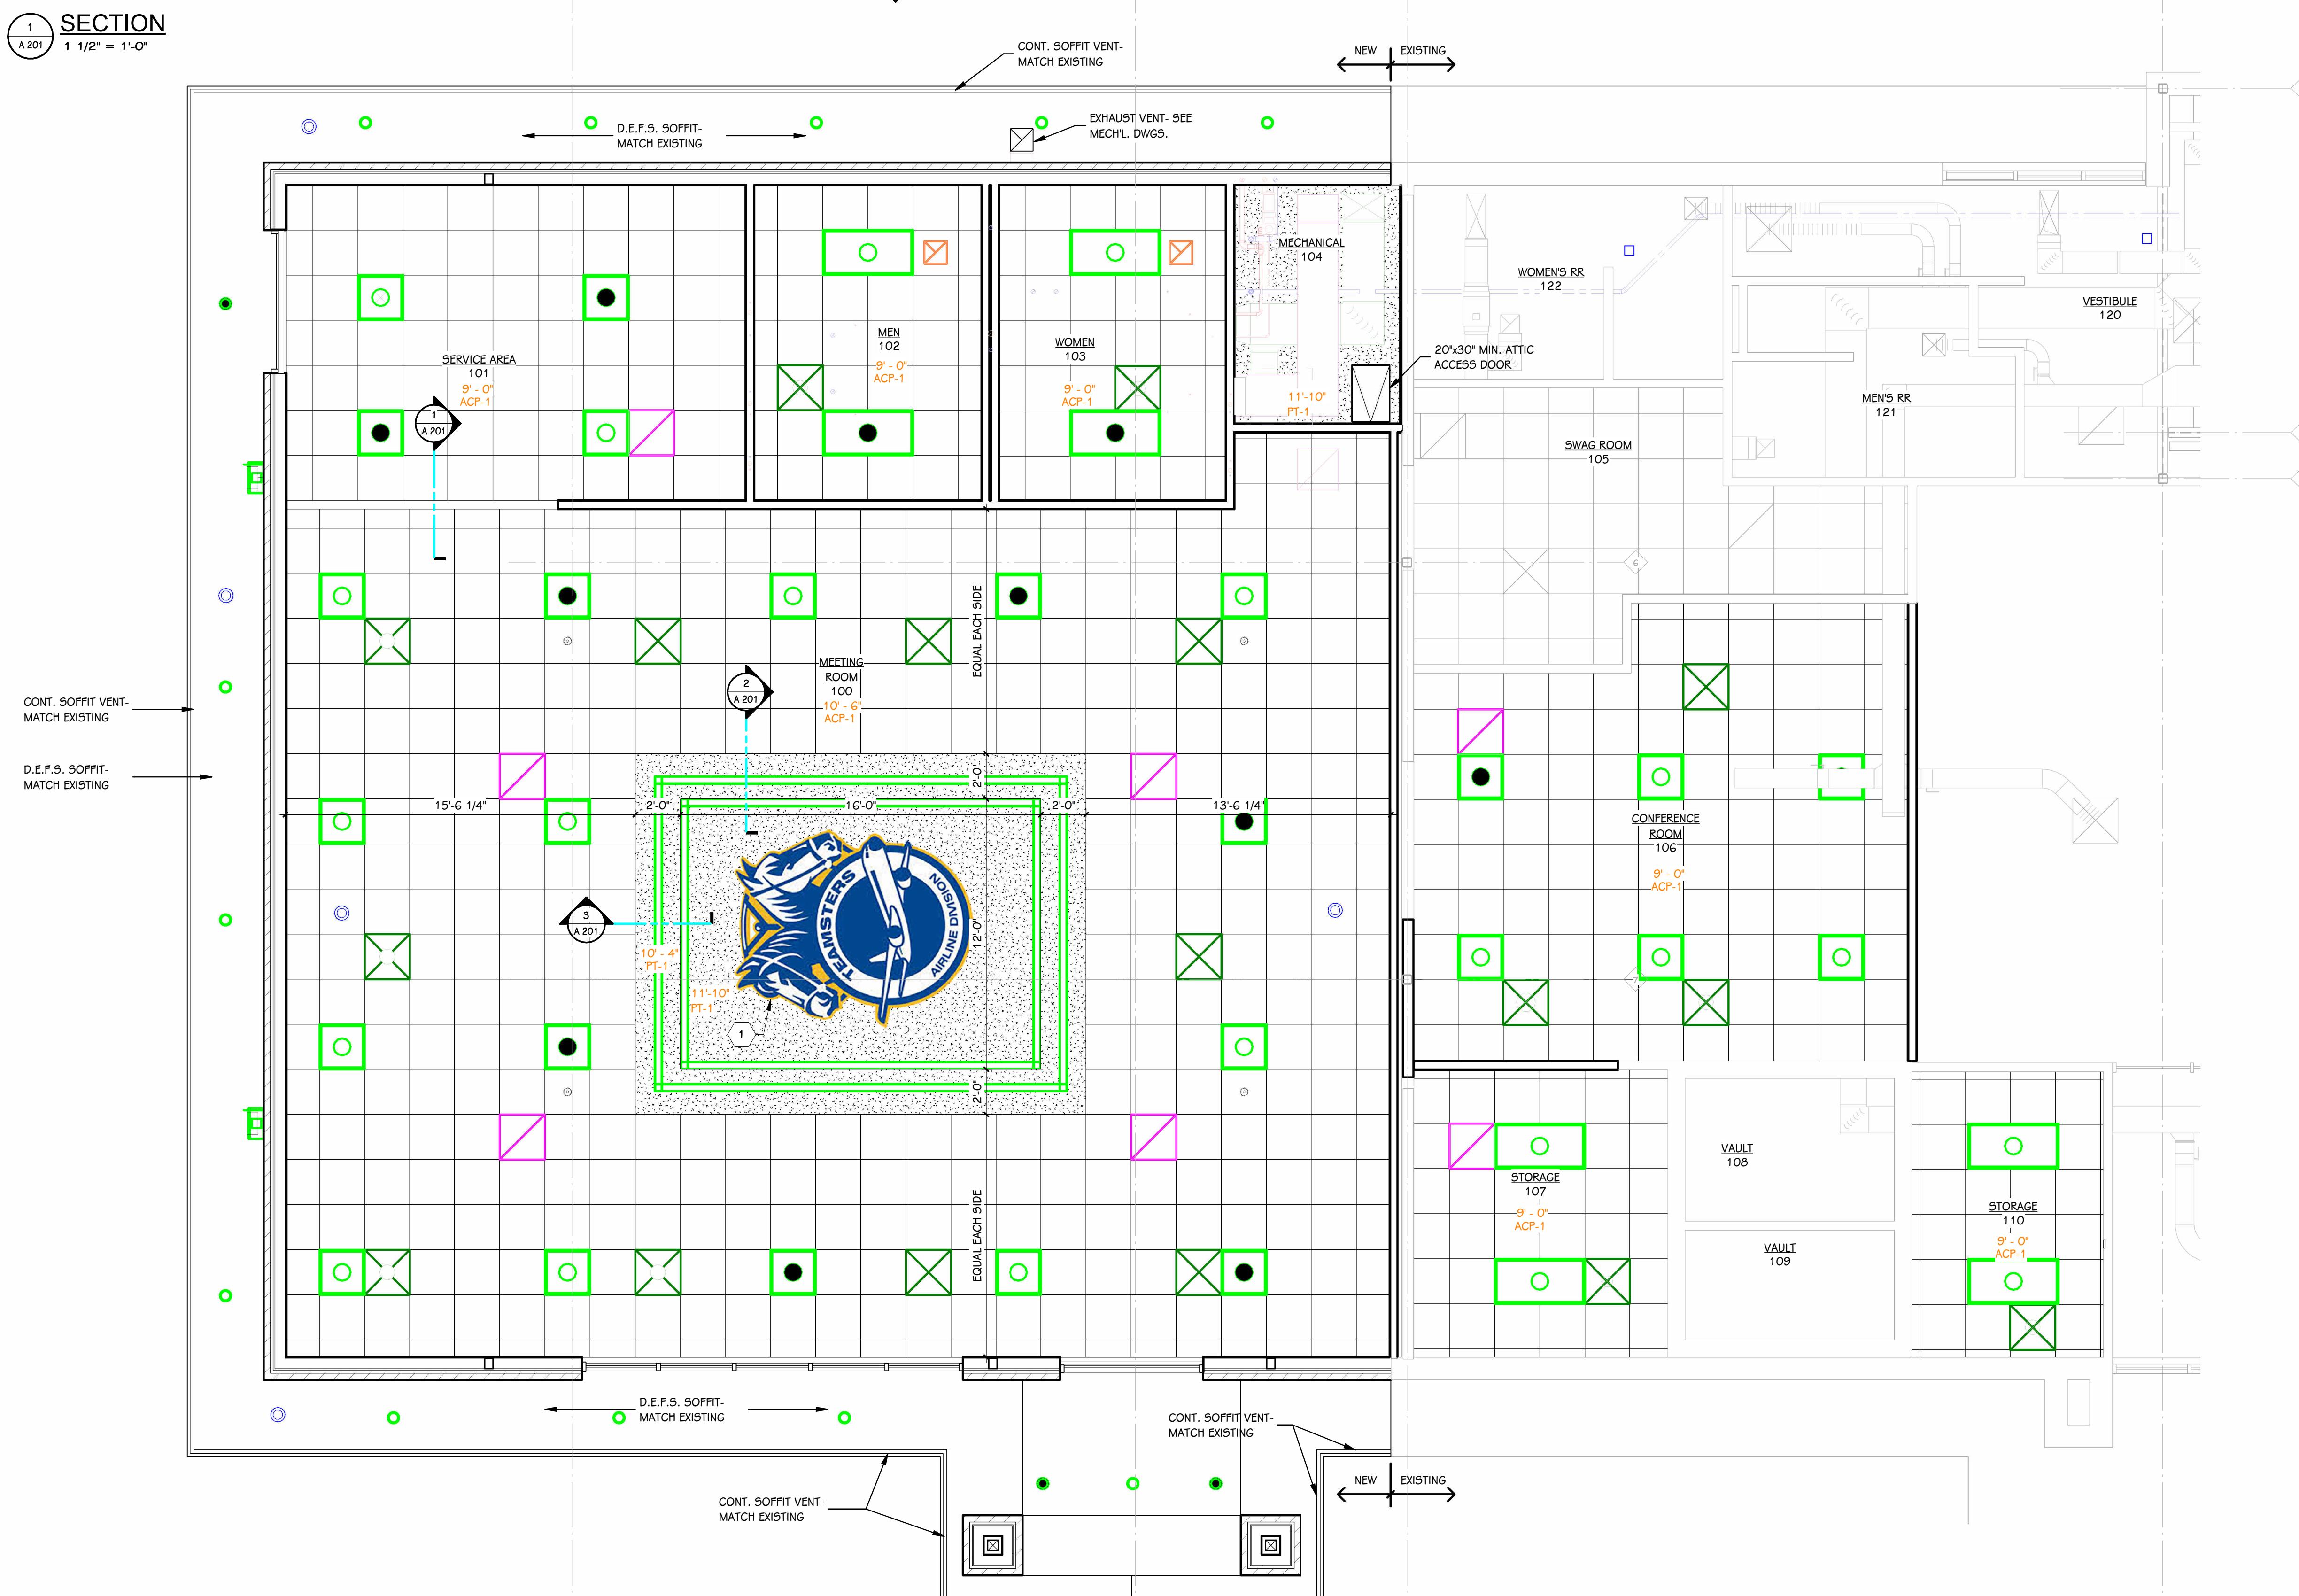SECTION
A 201
1 1/2" = 1'-0"

REFLECTED CEILING PLAN - ADDITION
1/4" = 1'-0"

TEAMSTERS LOCAL 2727

BUILDING ADDITION
EXISTING
BUILDING

KEY PLAN

PROJECT TITLE
TEAMSTERS LOCAL 2727
BUILDING ADDITION

OWNER
TEAMSTERS LOCAL 2727

4810 N Preston Hwy
Shepherdsville, KY

SHEET TITLE
EXTERIOR ELEVATIONS




SHEET NUMBER
A 301
25-376.000

ISSUED FOR DATE



Heather D. Granger

EXTERIOR ELEVATION KEY	
	BRICK 1, COLOR: MATCH EXISTING
	ROOF SHINGLES, COLOR: MATCH EXISTING
	EIFS, COLOR: MATCH EXISTING

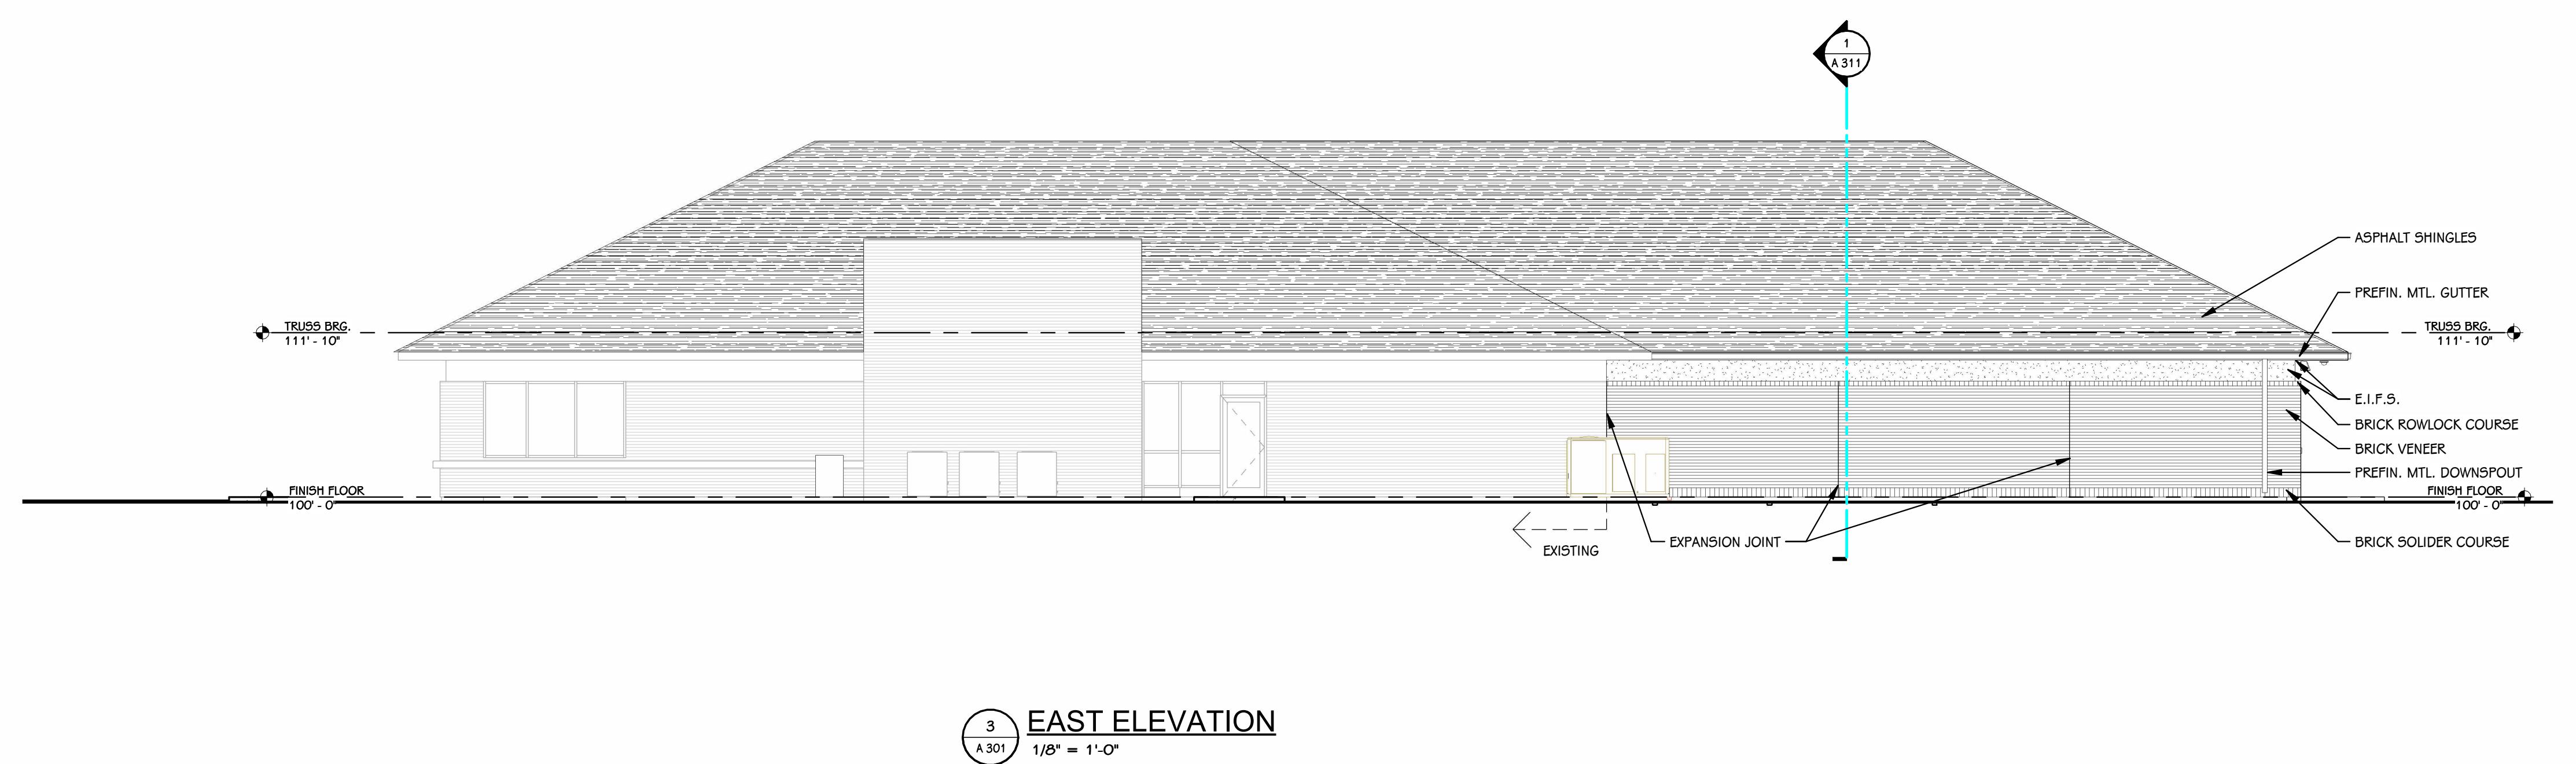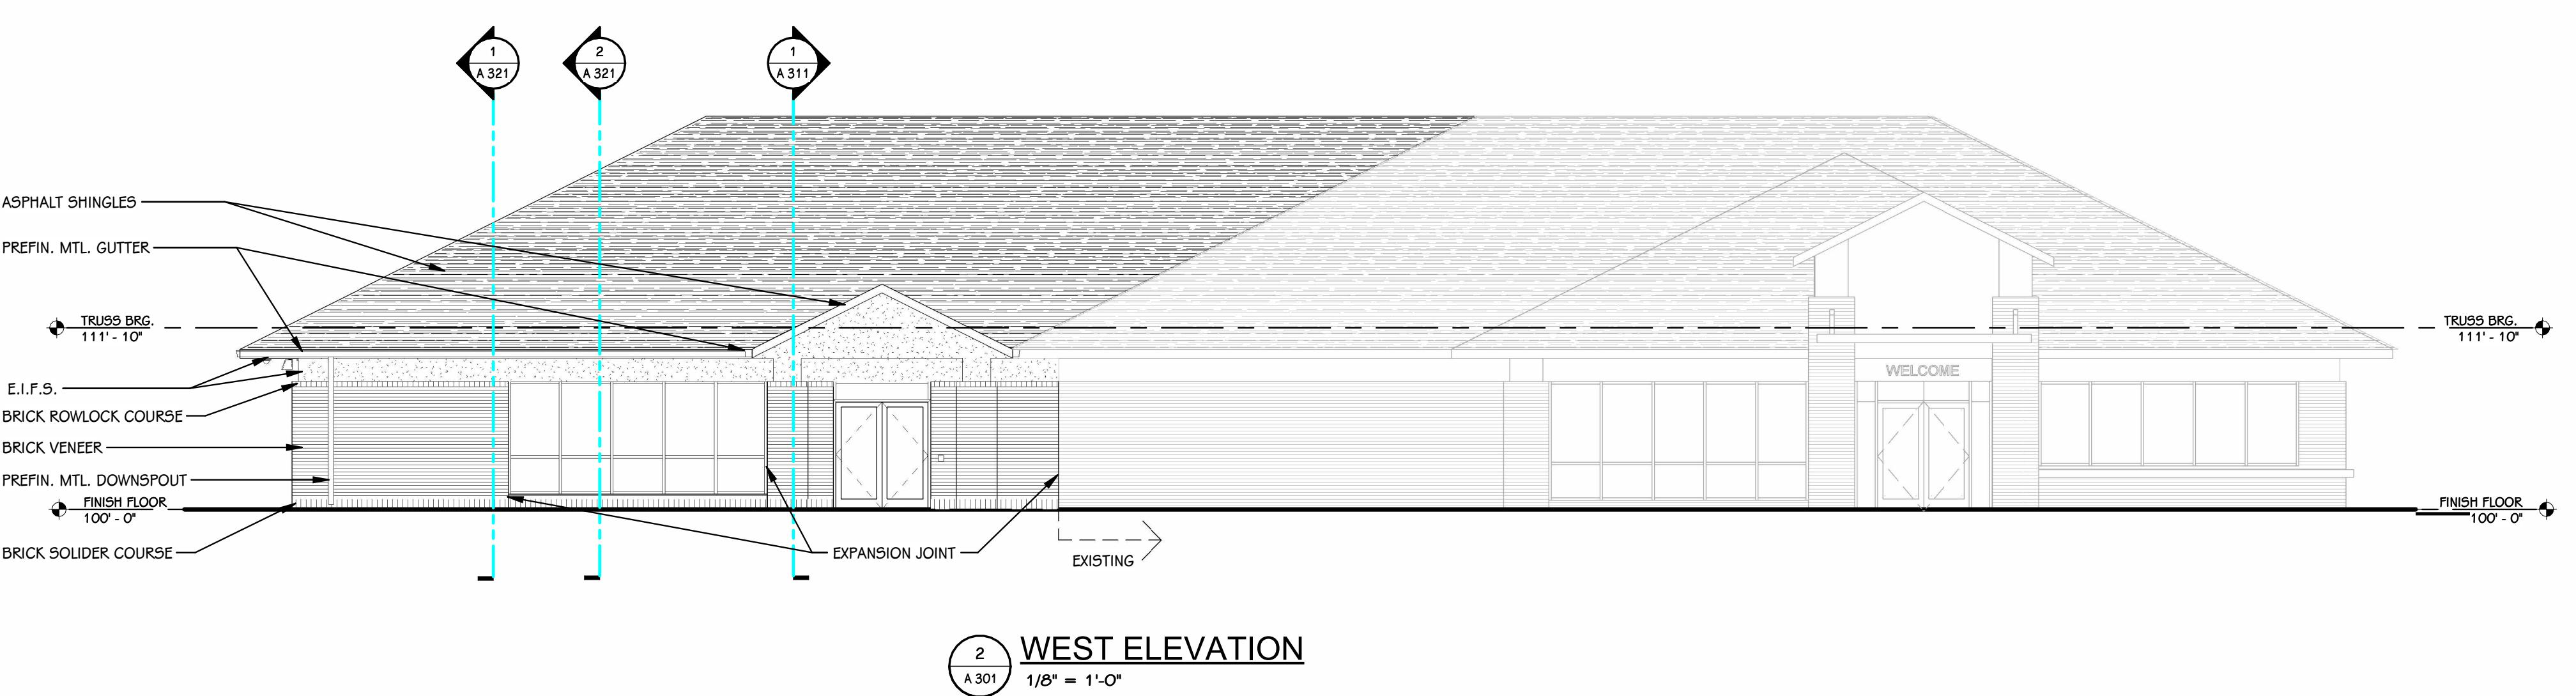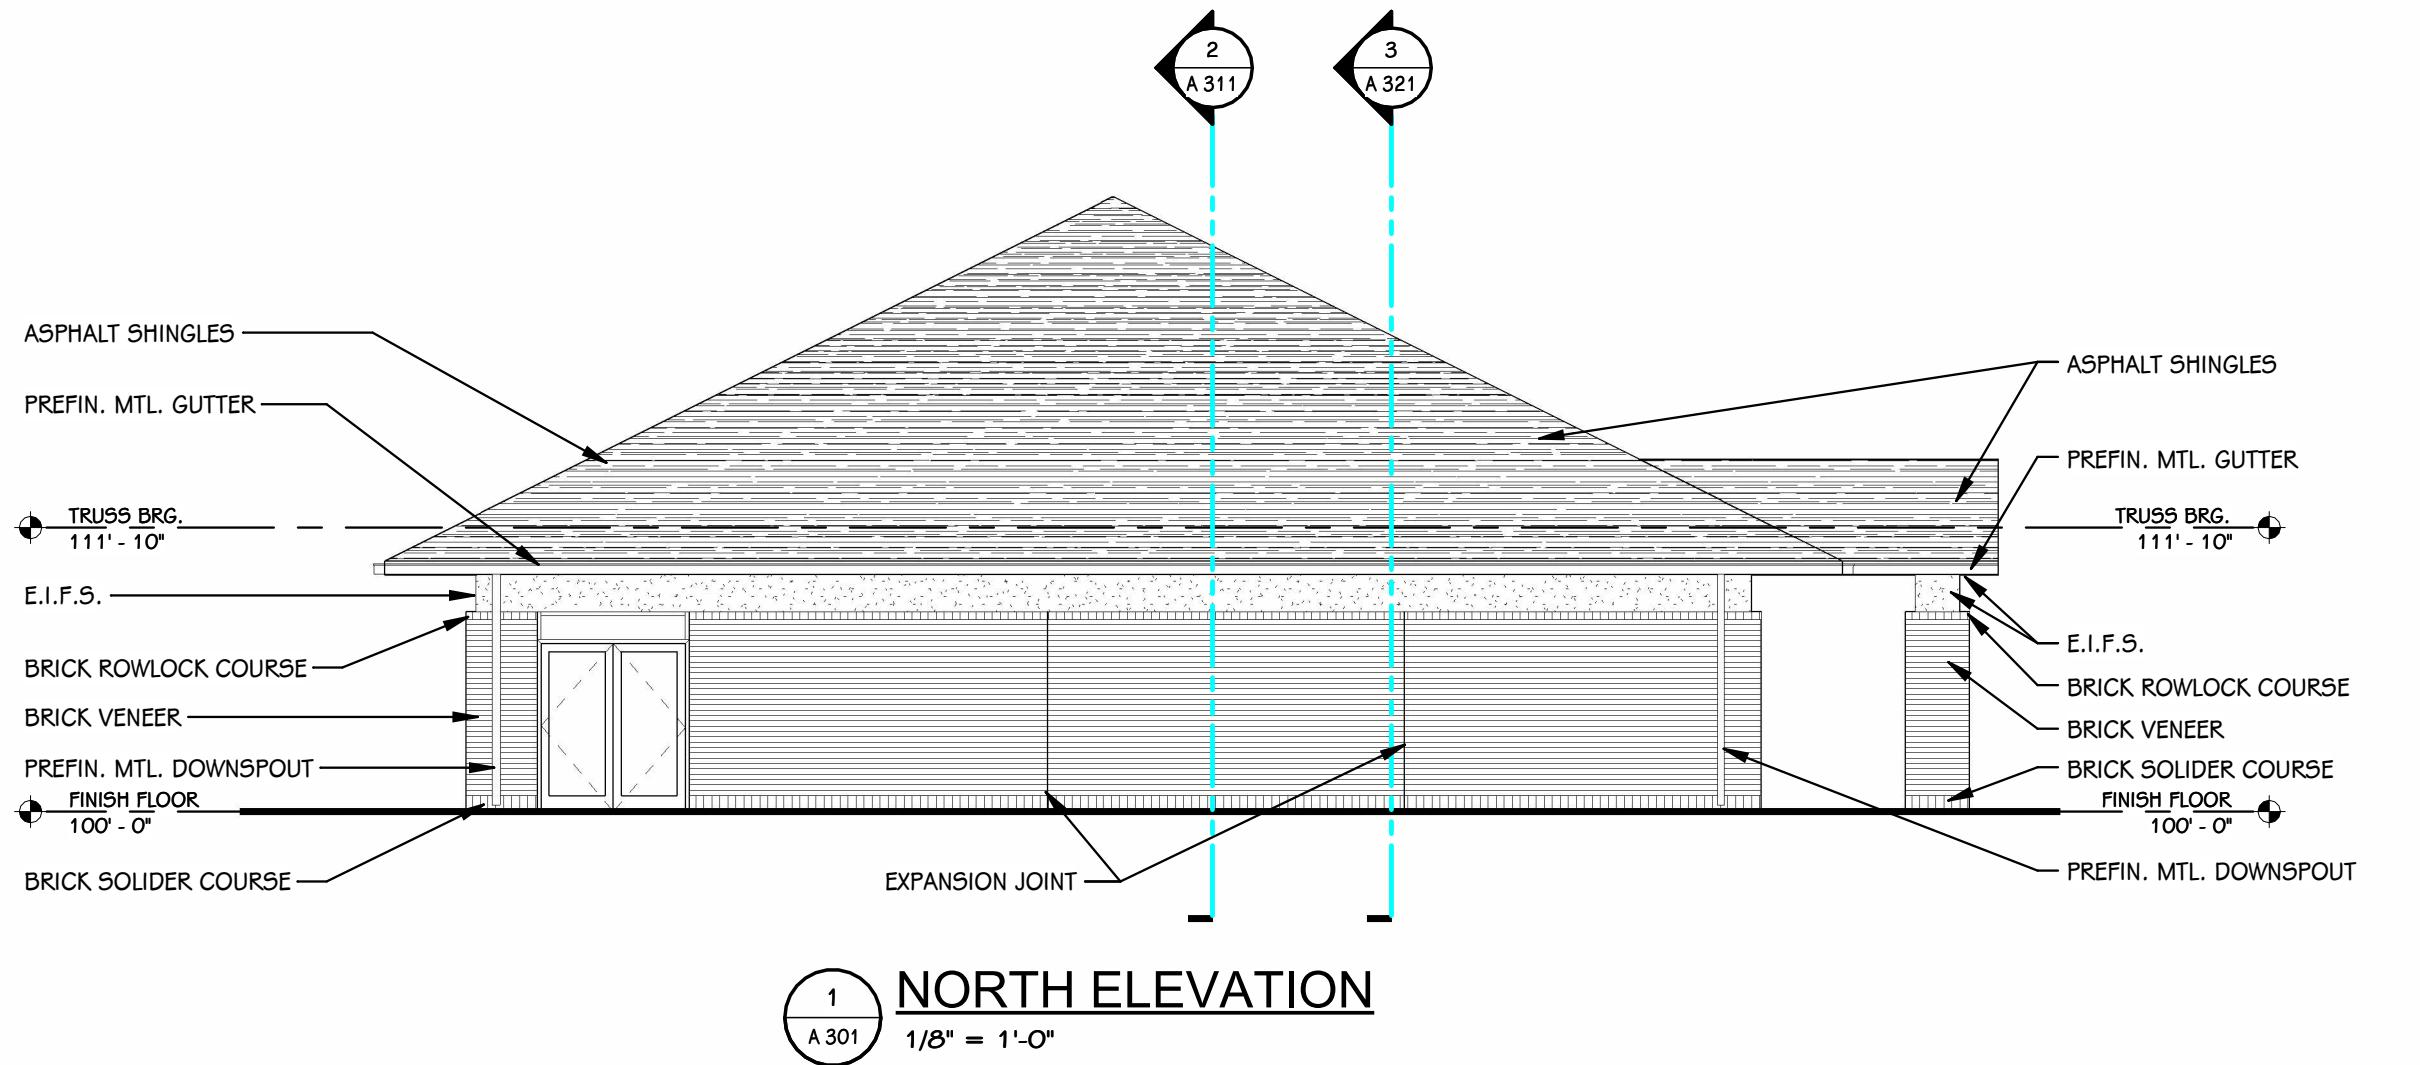



PROJECT TITLE
TEAMSTERS LOCAL 2727
BUILDING ADDITION

OWNER
TEAMSTERS LOCAL 2727

SHEET TITLE
BUILDING SECTIONS
SHEET NUMBER
A 311
25-376.000

4810 N Preston Hwy
Shepherdsville, KY

DATE
JANUARY 9, 2026

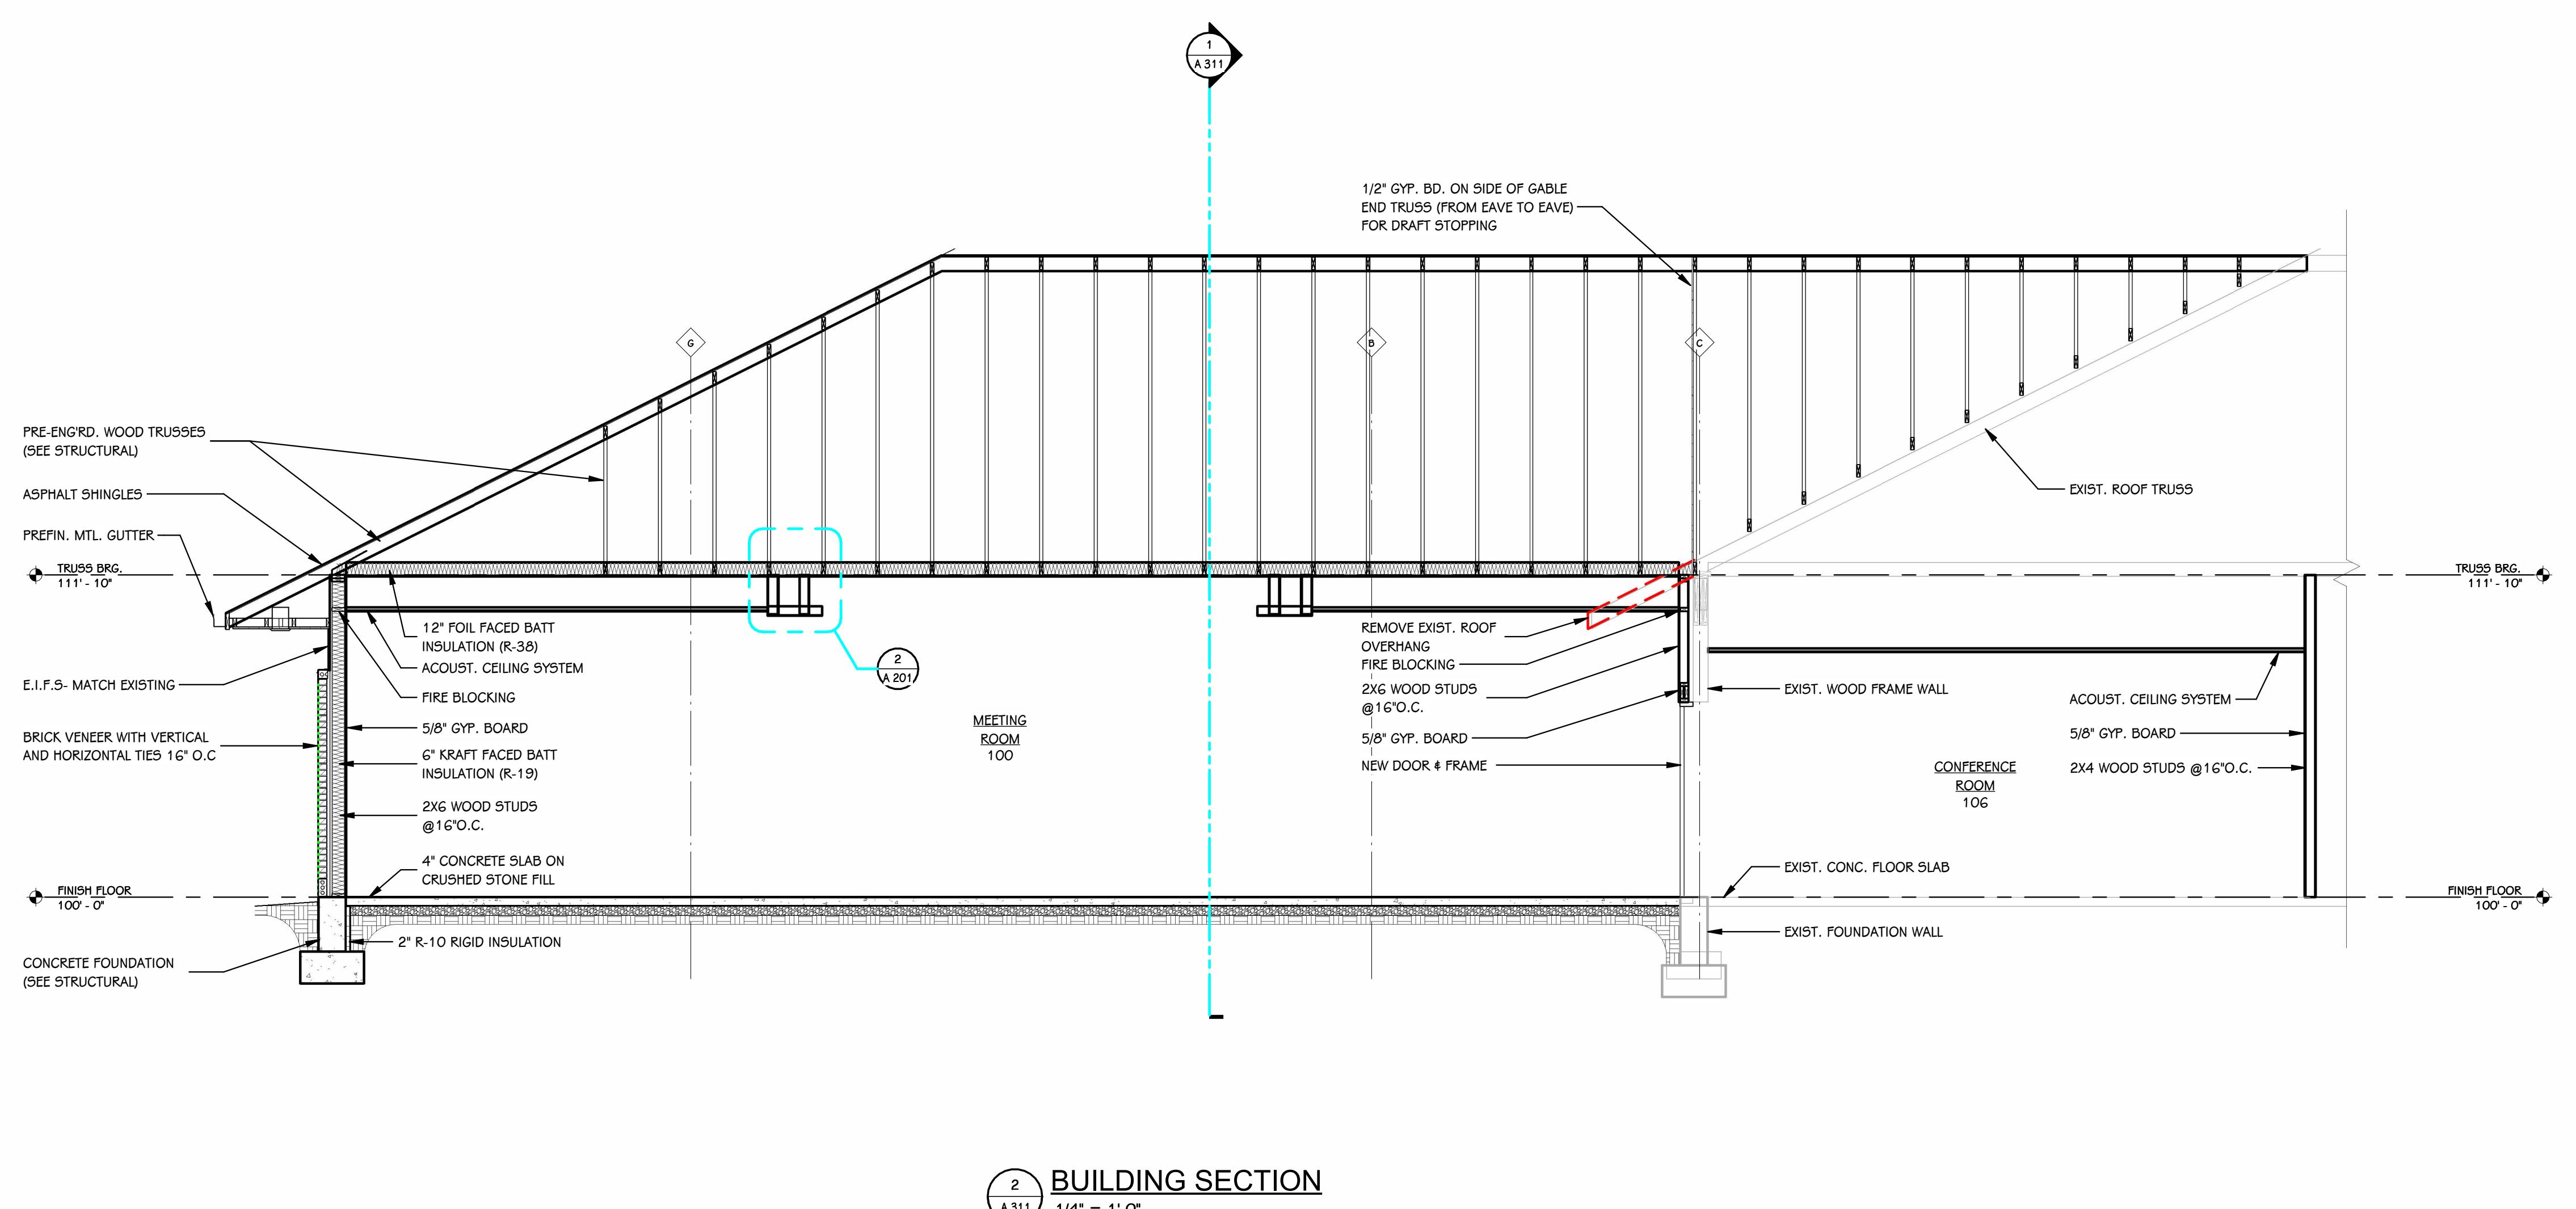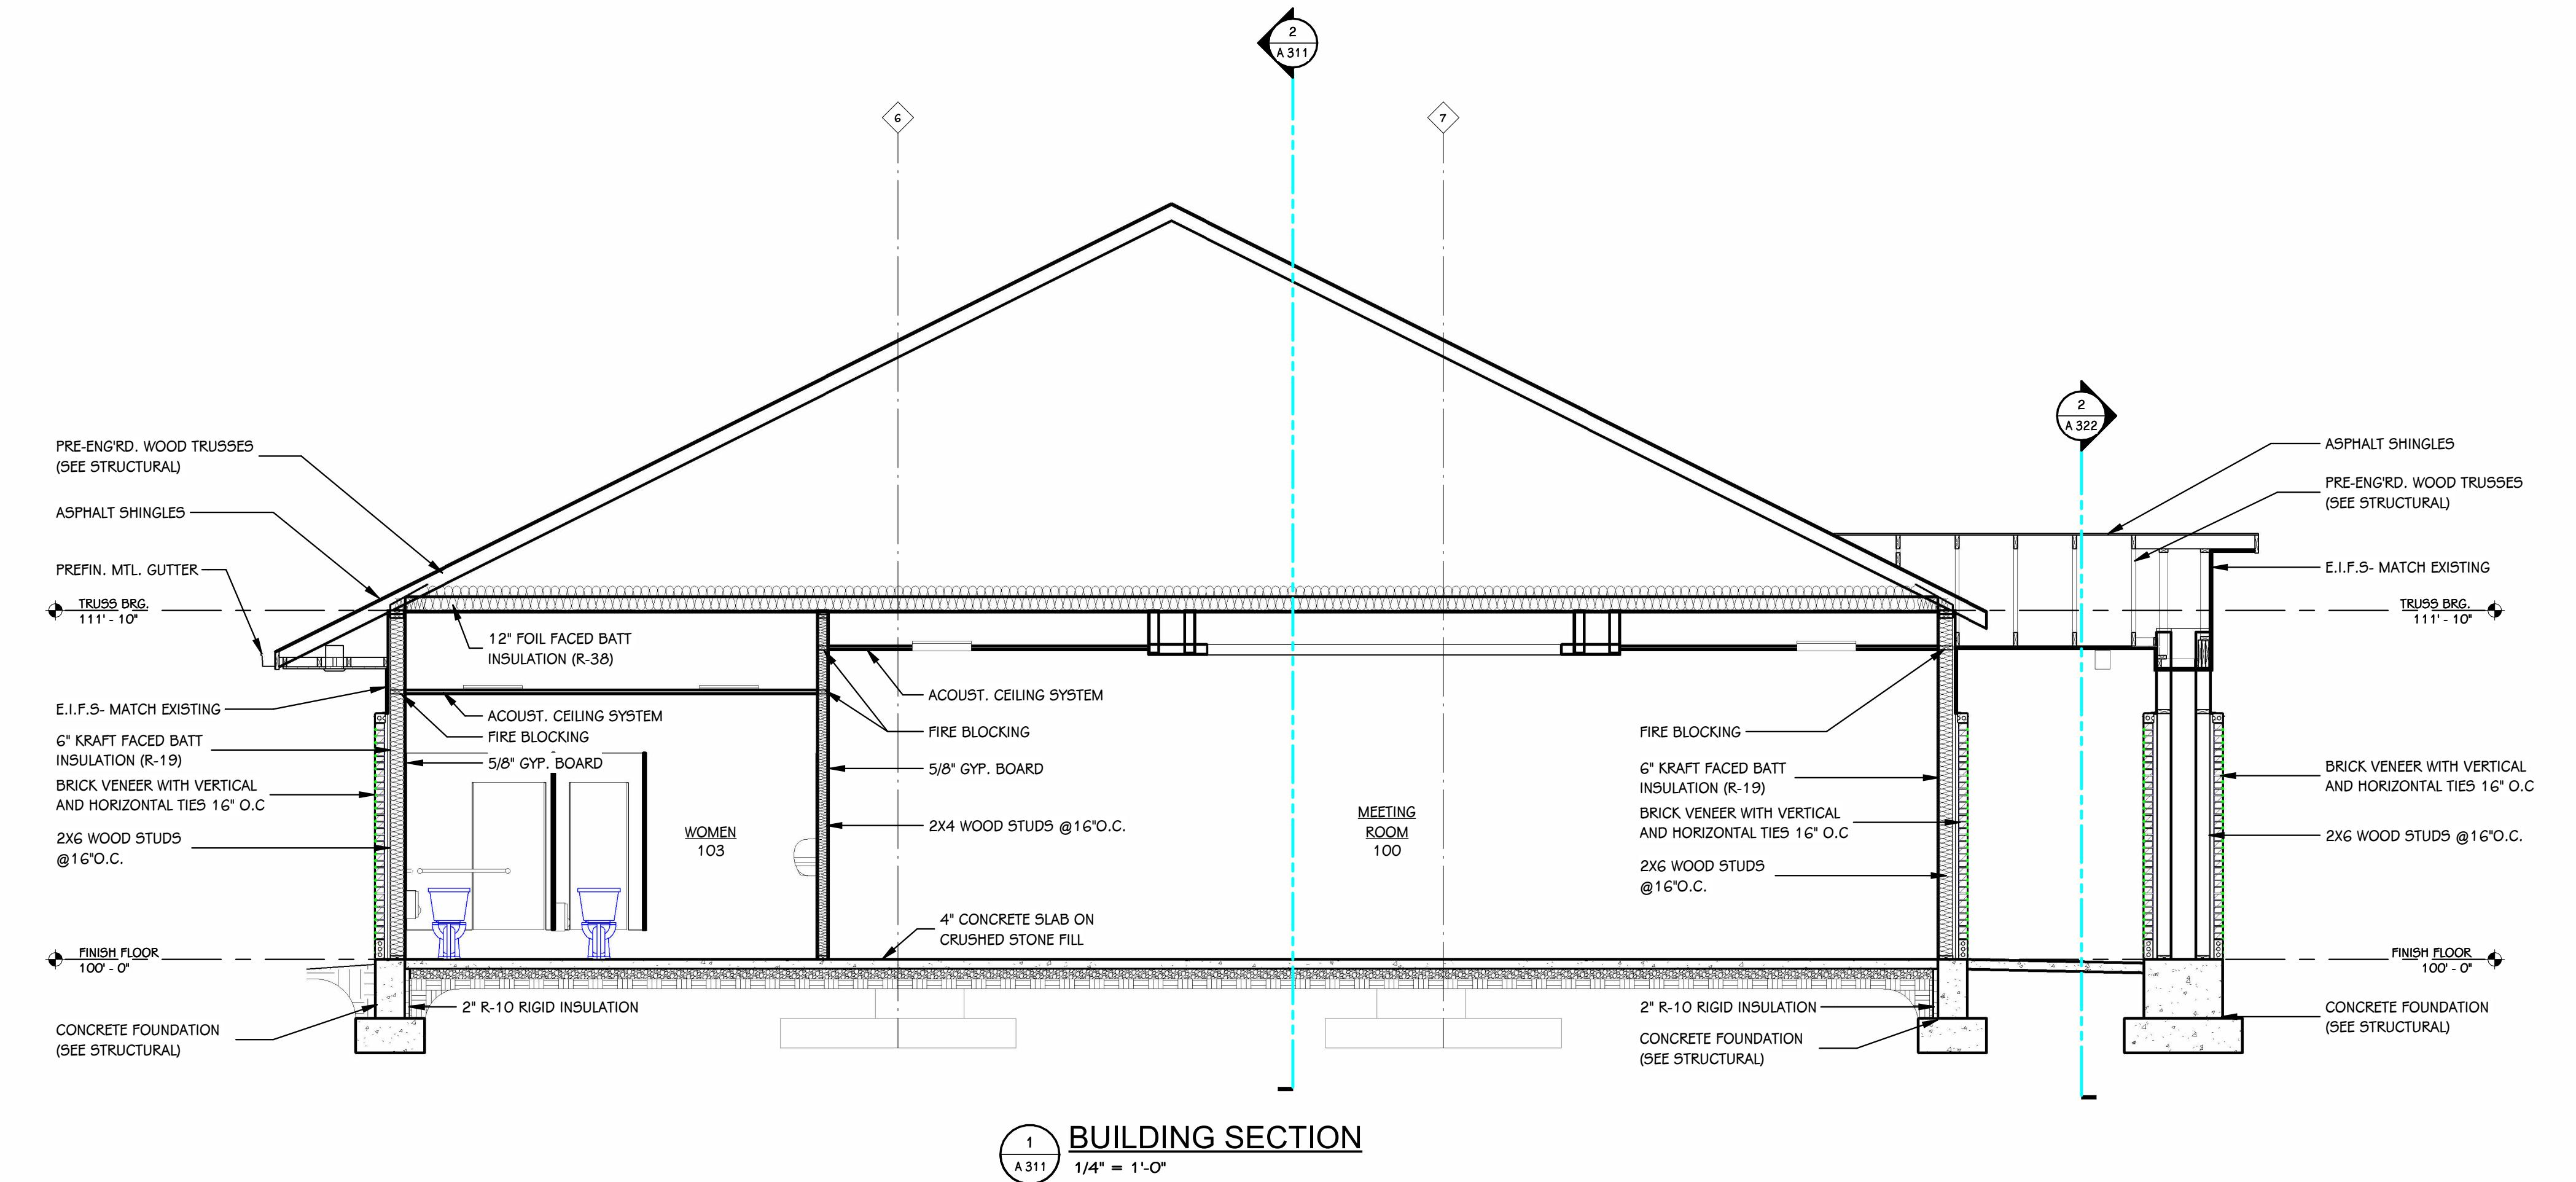





PROJECT TITLE
TEAMSTERS LOCAL 2727
BUILDING ADDITION

 OWNER
TEAMSTERS LOCAL 2727
4810 N Preston Hwy
Shepherdsville, KY

 SHEET TITLE
WALL SECTIONS AND DETAILS
SHEET NUMBER
A 321
25-376.000

 DATE
JANUARY 9, 2026

 DRAWN BY: XXX
11/30/2026 3:15:19 PM

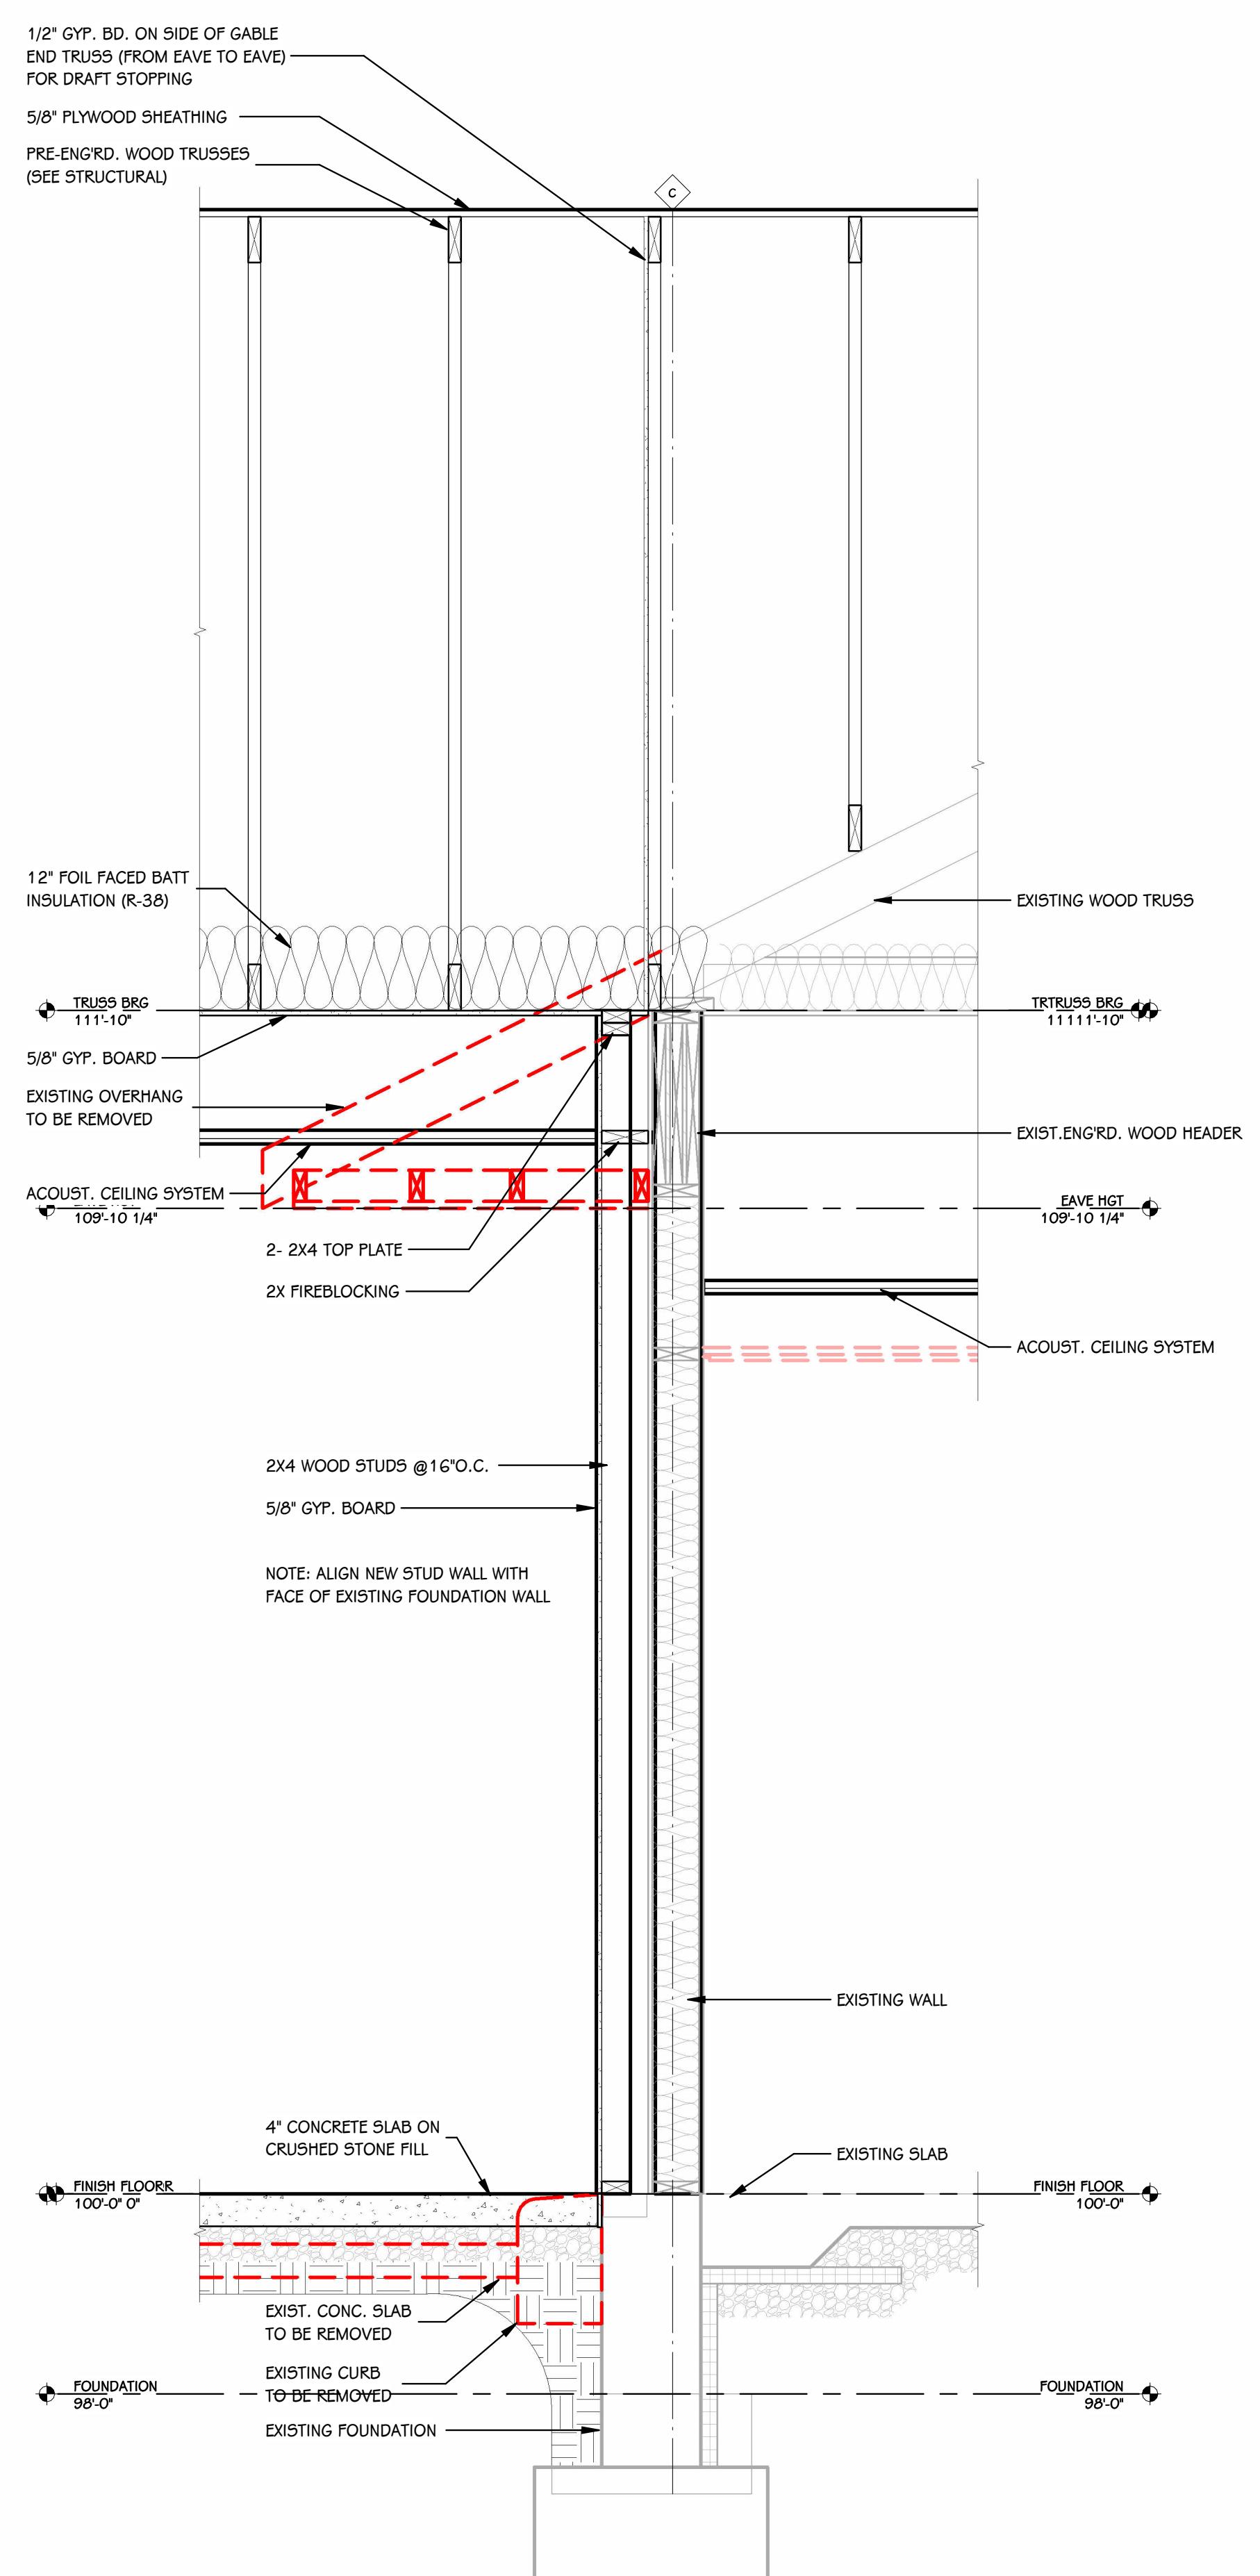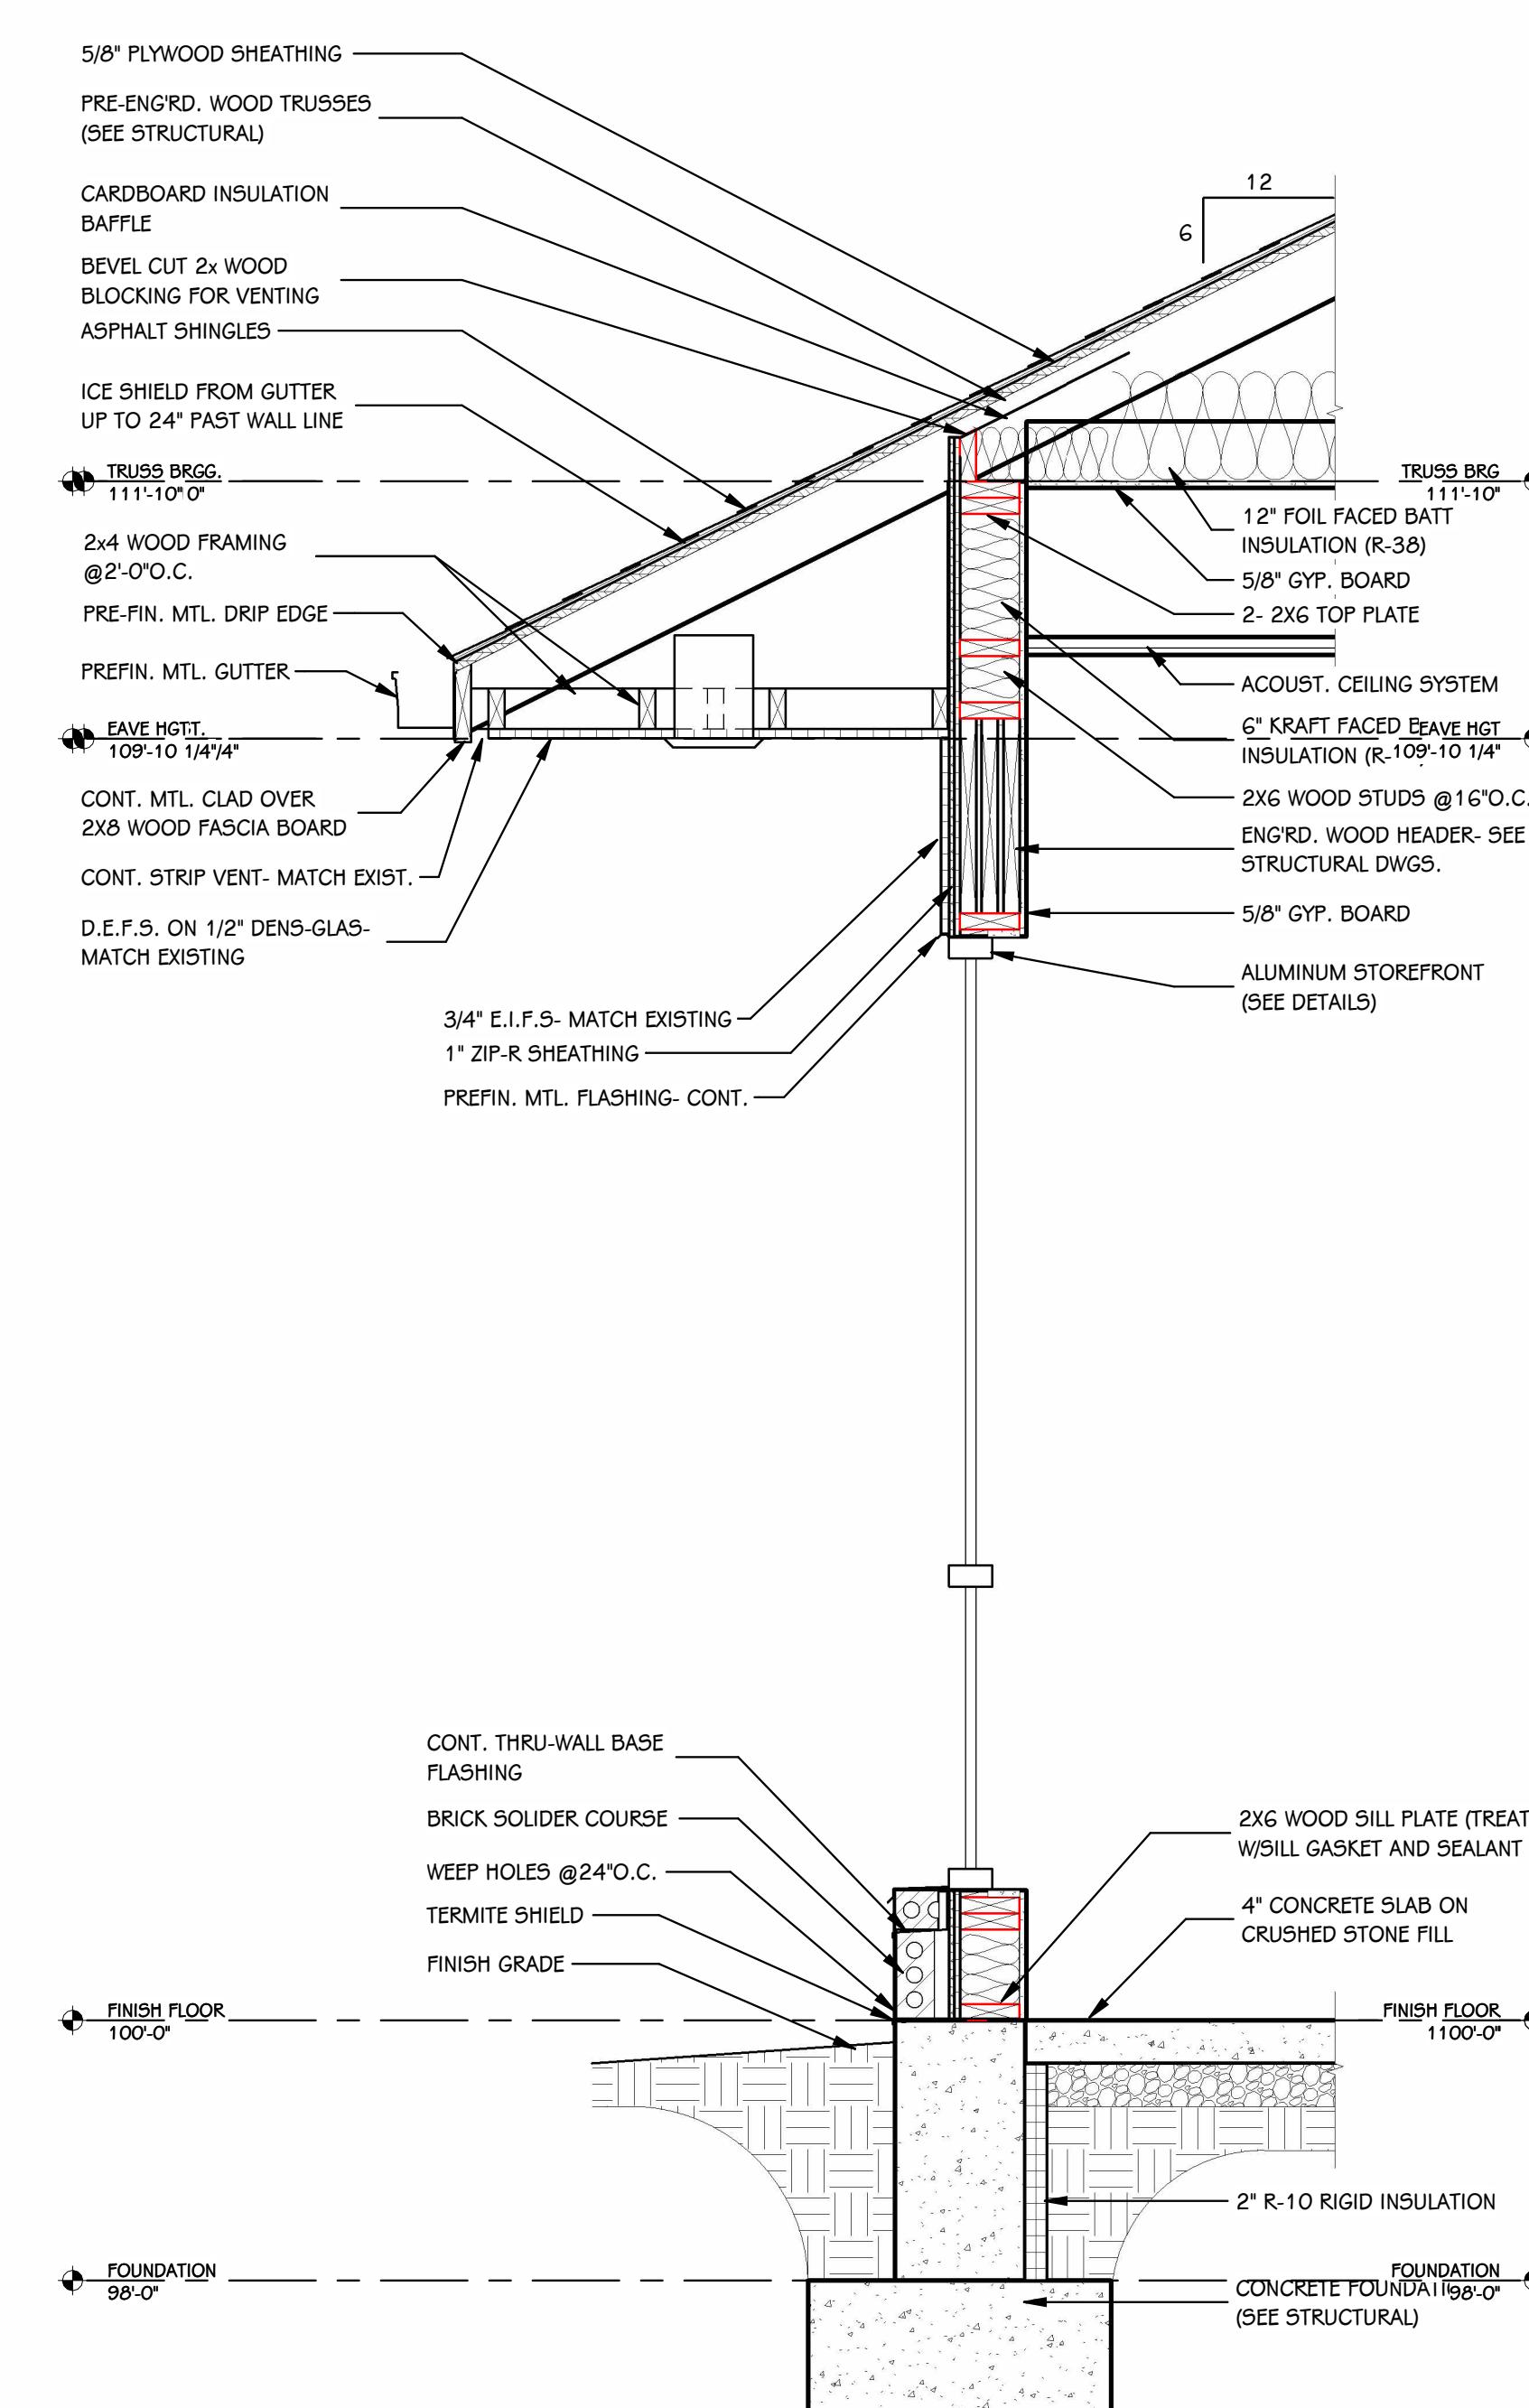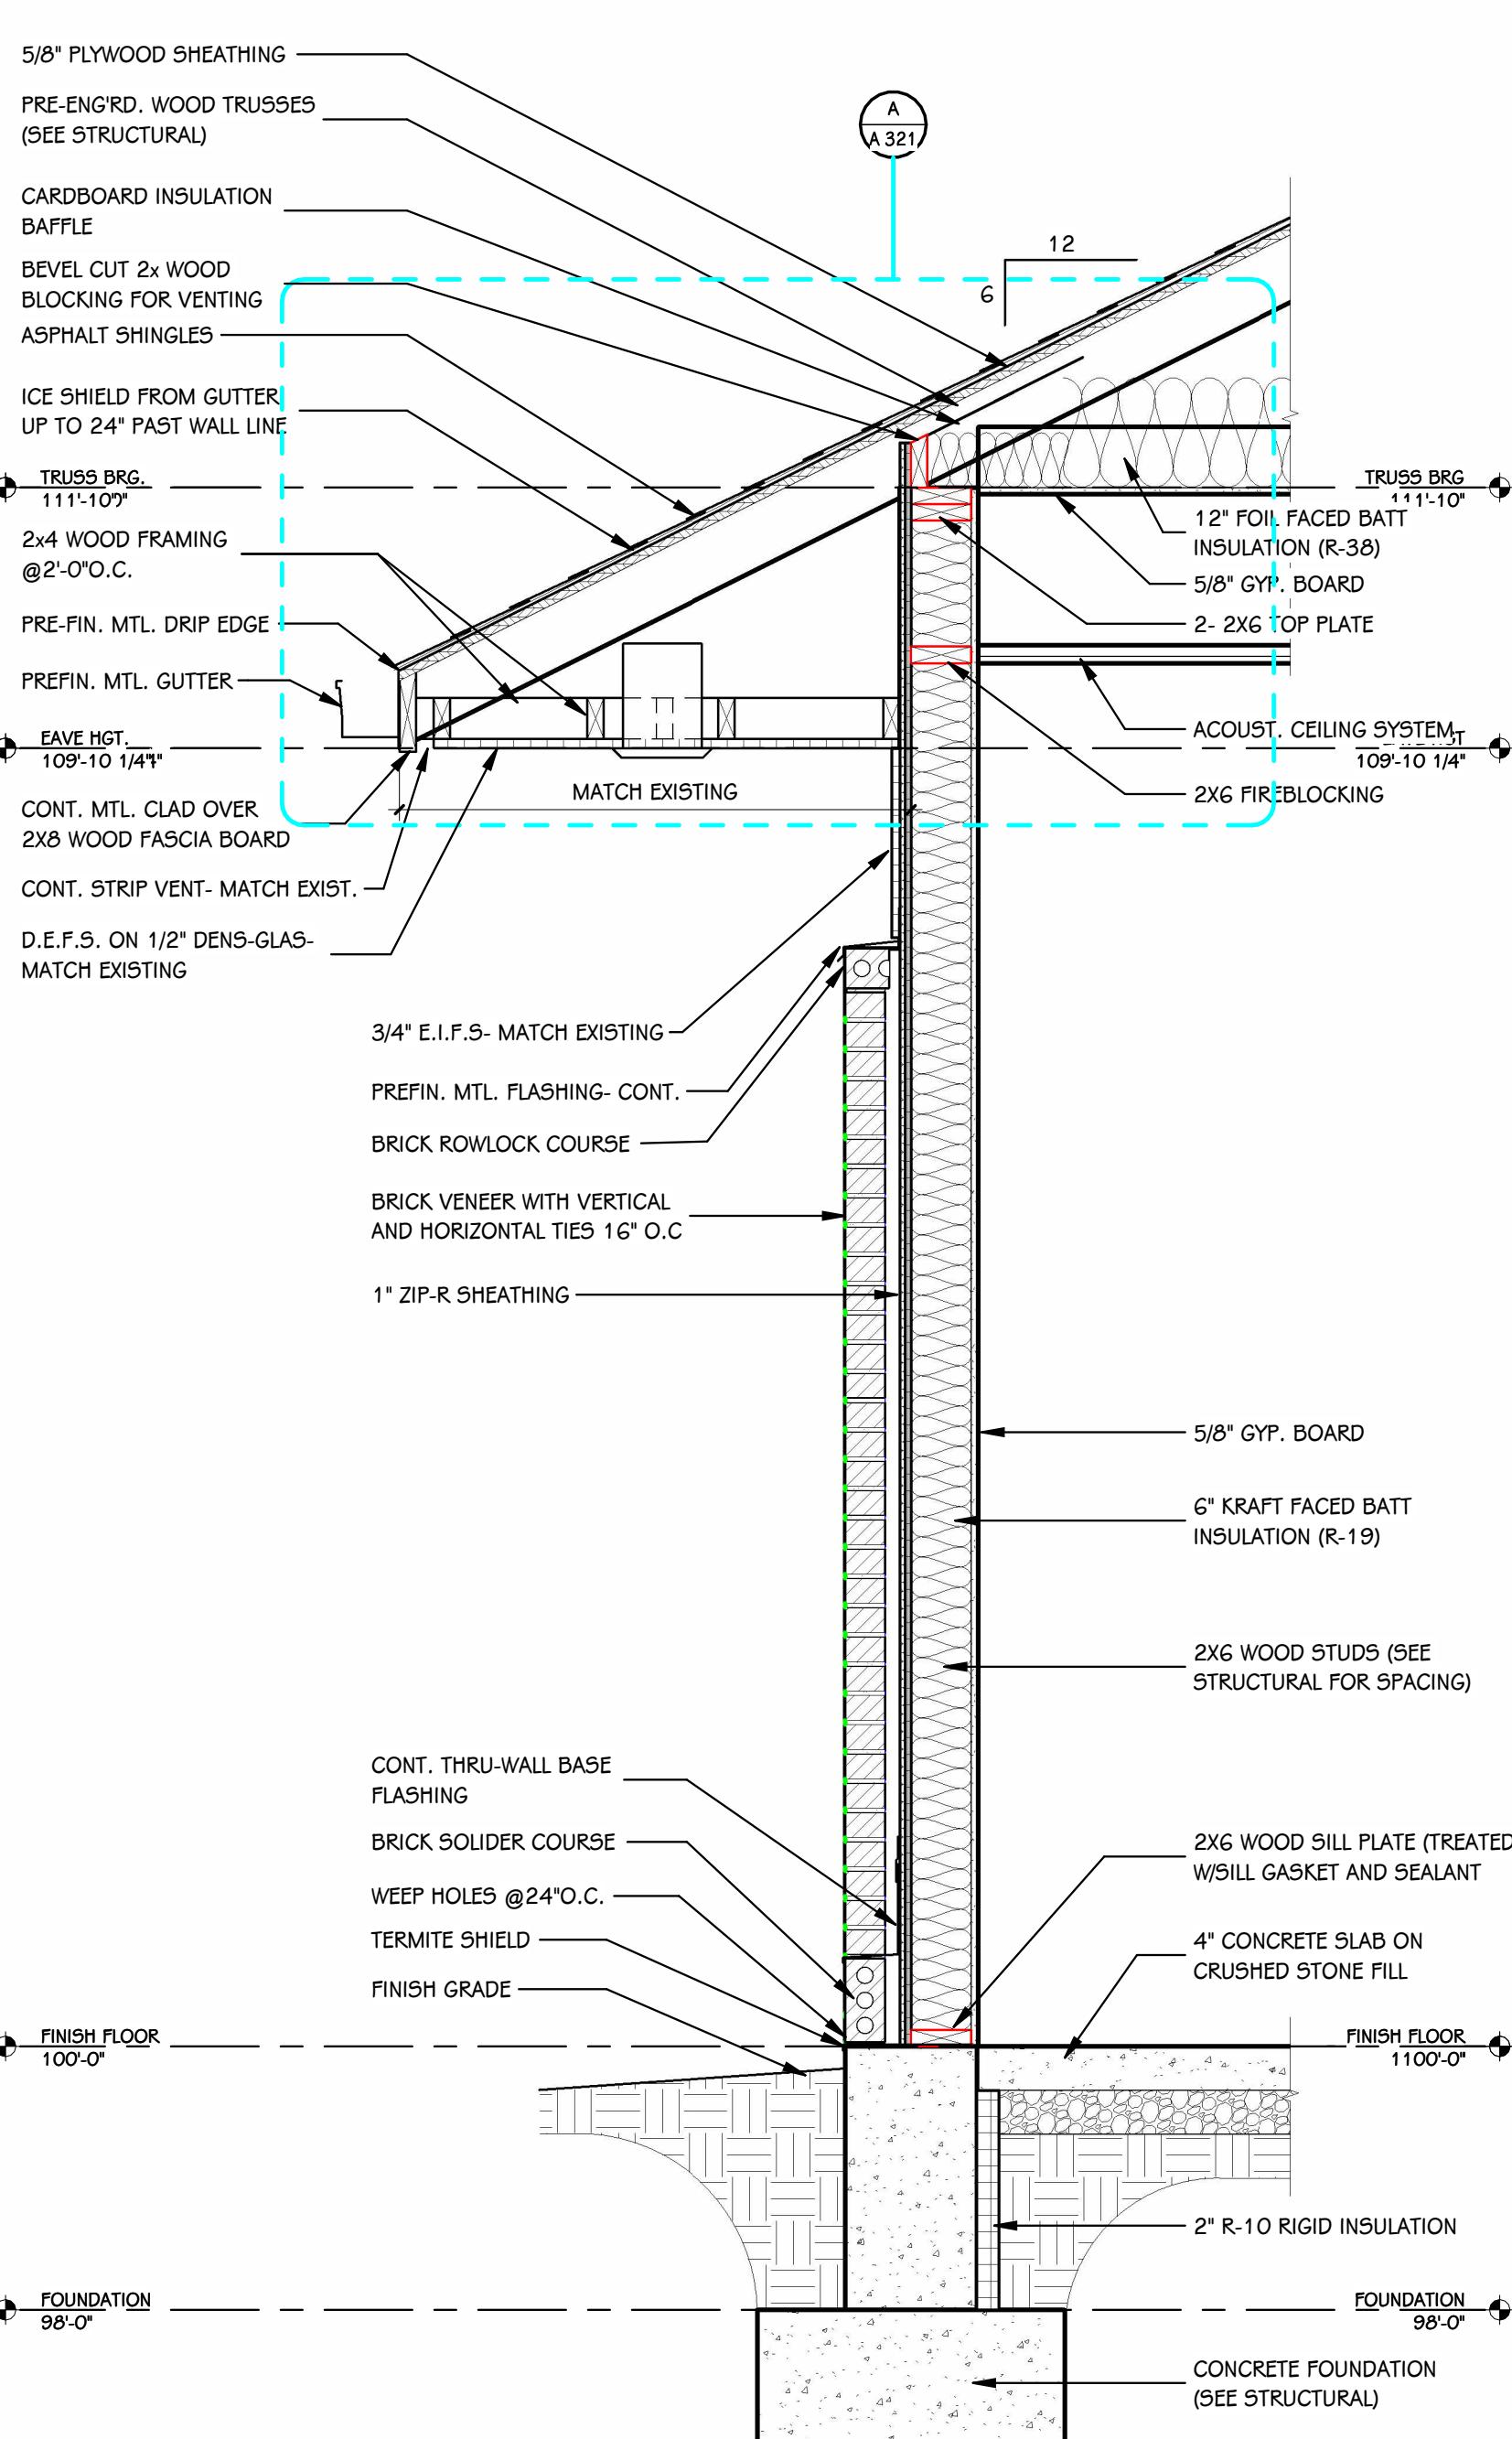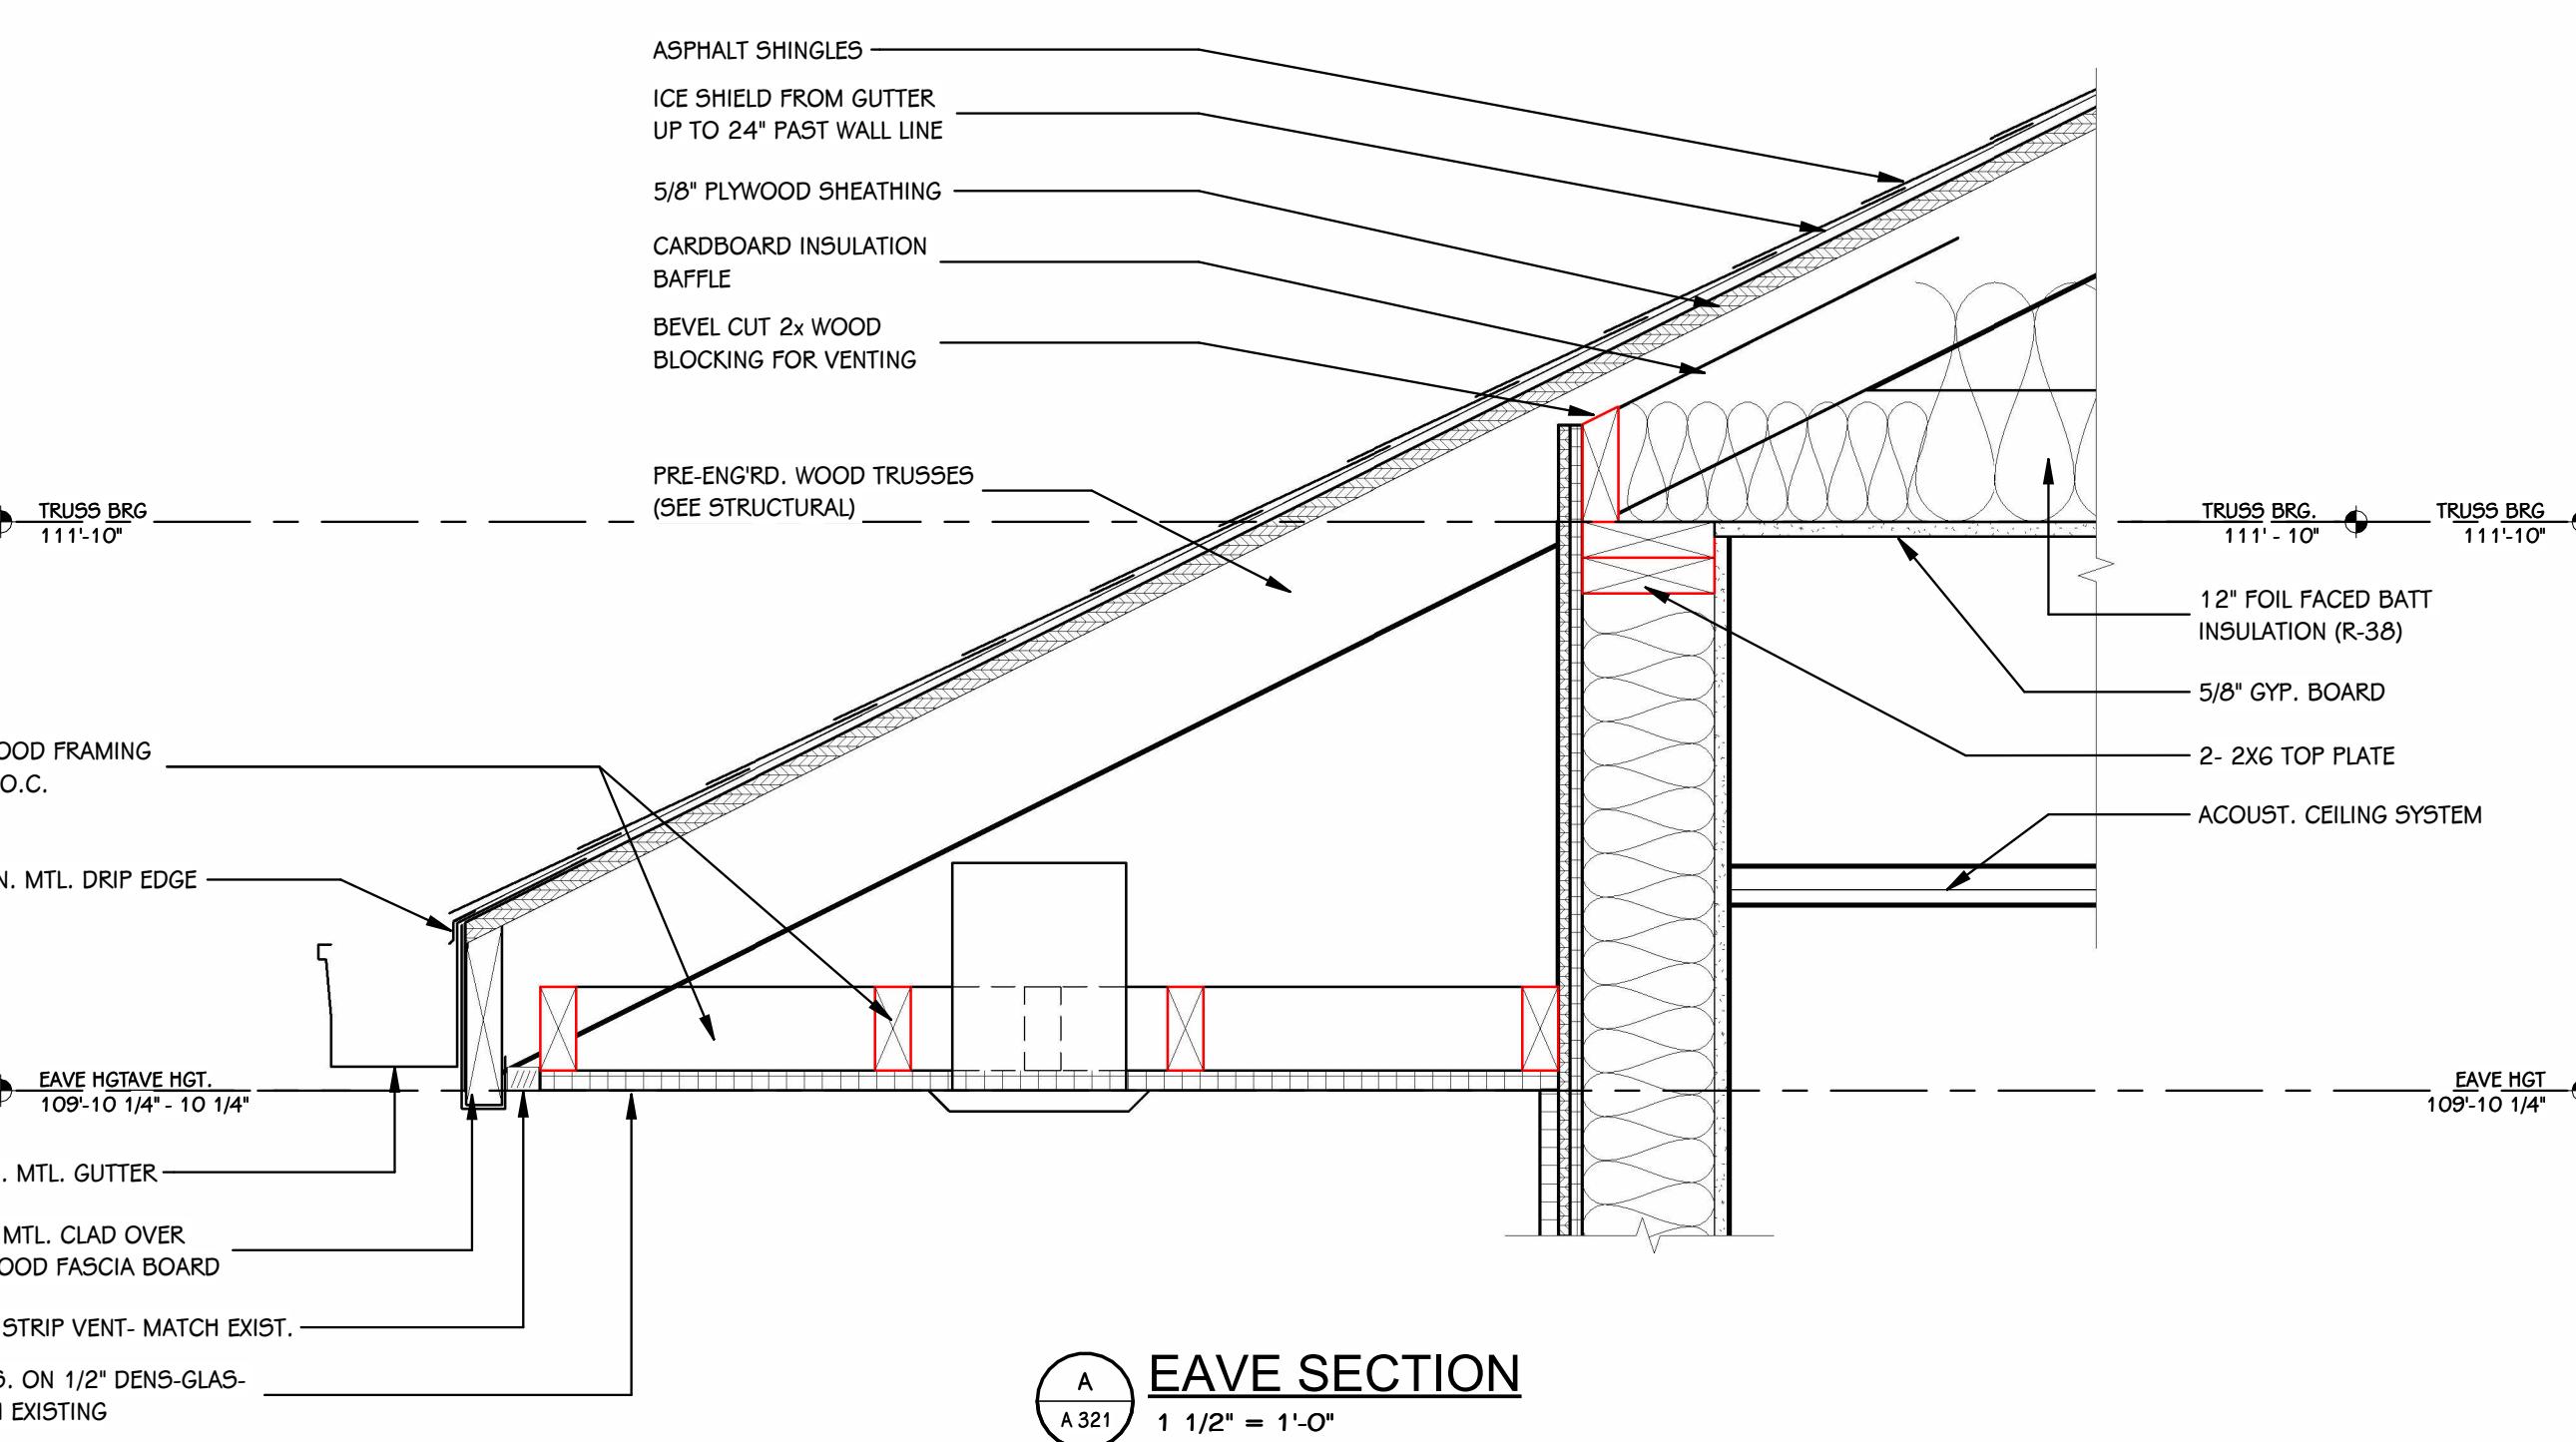 THIS DRAWING SHEET IS INTENDED TO BE PLOTTED IN
COLOR. IF THIS TEXT APPEARS IN BLACK AND WHITE,
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AN ACCURATE DRAWING

 3 WALL SECTION
A 321 3/4" = 1'-0"

 THIS DRAWING SHEET IS INTENDED TO BE PLOTTED IN
COLOR. IF THIS TEXT APPEARS IN BLACK AND WHITE,
IT IS PLOTTED INCORRECTLY. DISCARD AND OBTAIN
AN ACCURATE DRAWING





PROJECT TITLE
TEAMSTERS LOCAL 2727
BUILDING ADDITION

OWNER
TEAMSTERS LOCAL 2727
4810 N Preston Hwy
Shepherdsville, KY

SHEET TITLE
WALL SECTIONS AND DETAILS
SHEET NUMBER
A 322
25-376.000

DATE
JANUARY 9, 2026

DATE
JANUARY 9, 2026

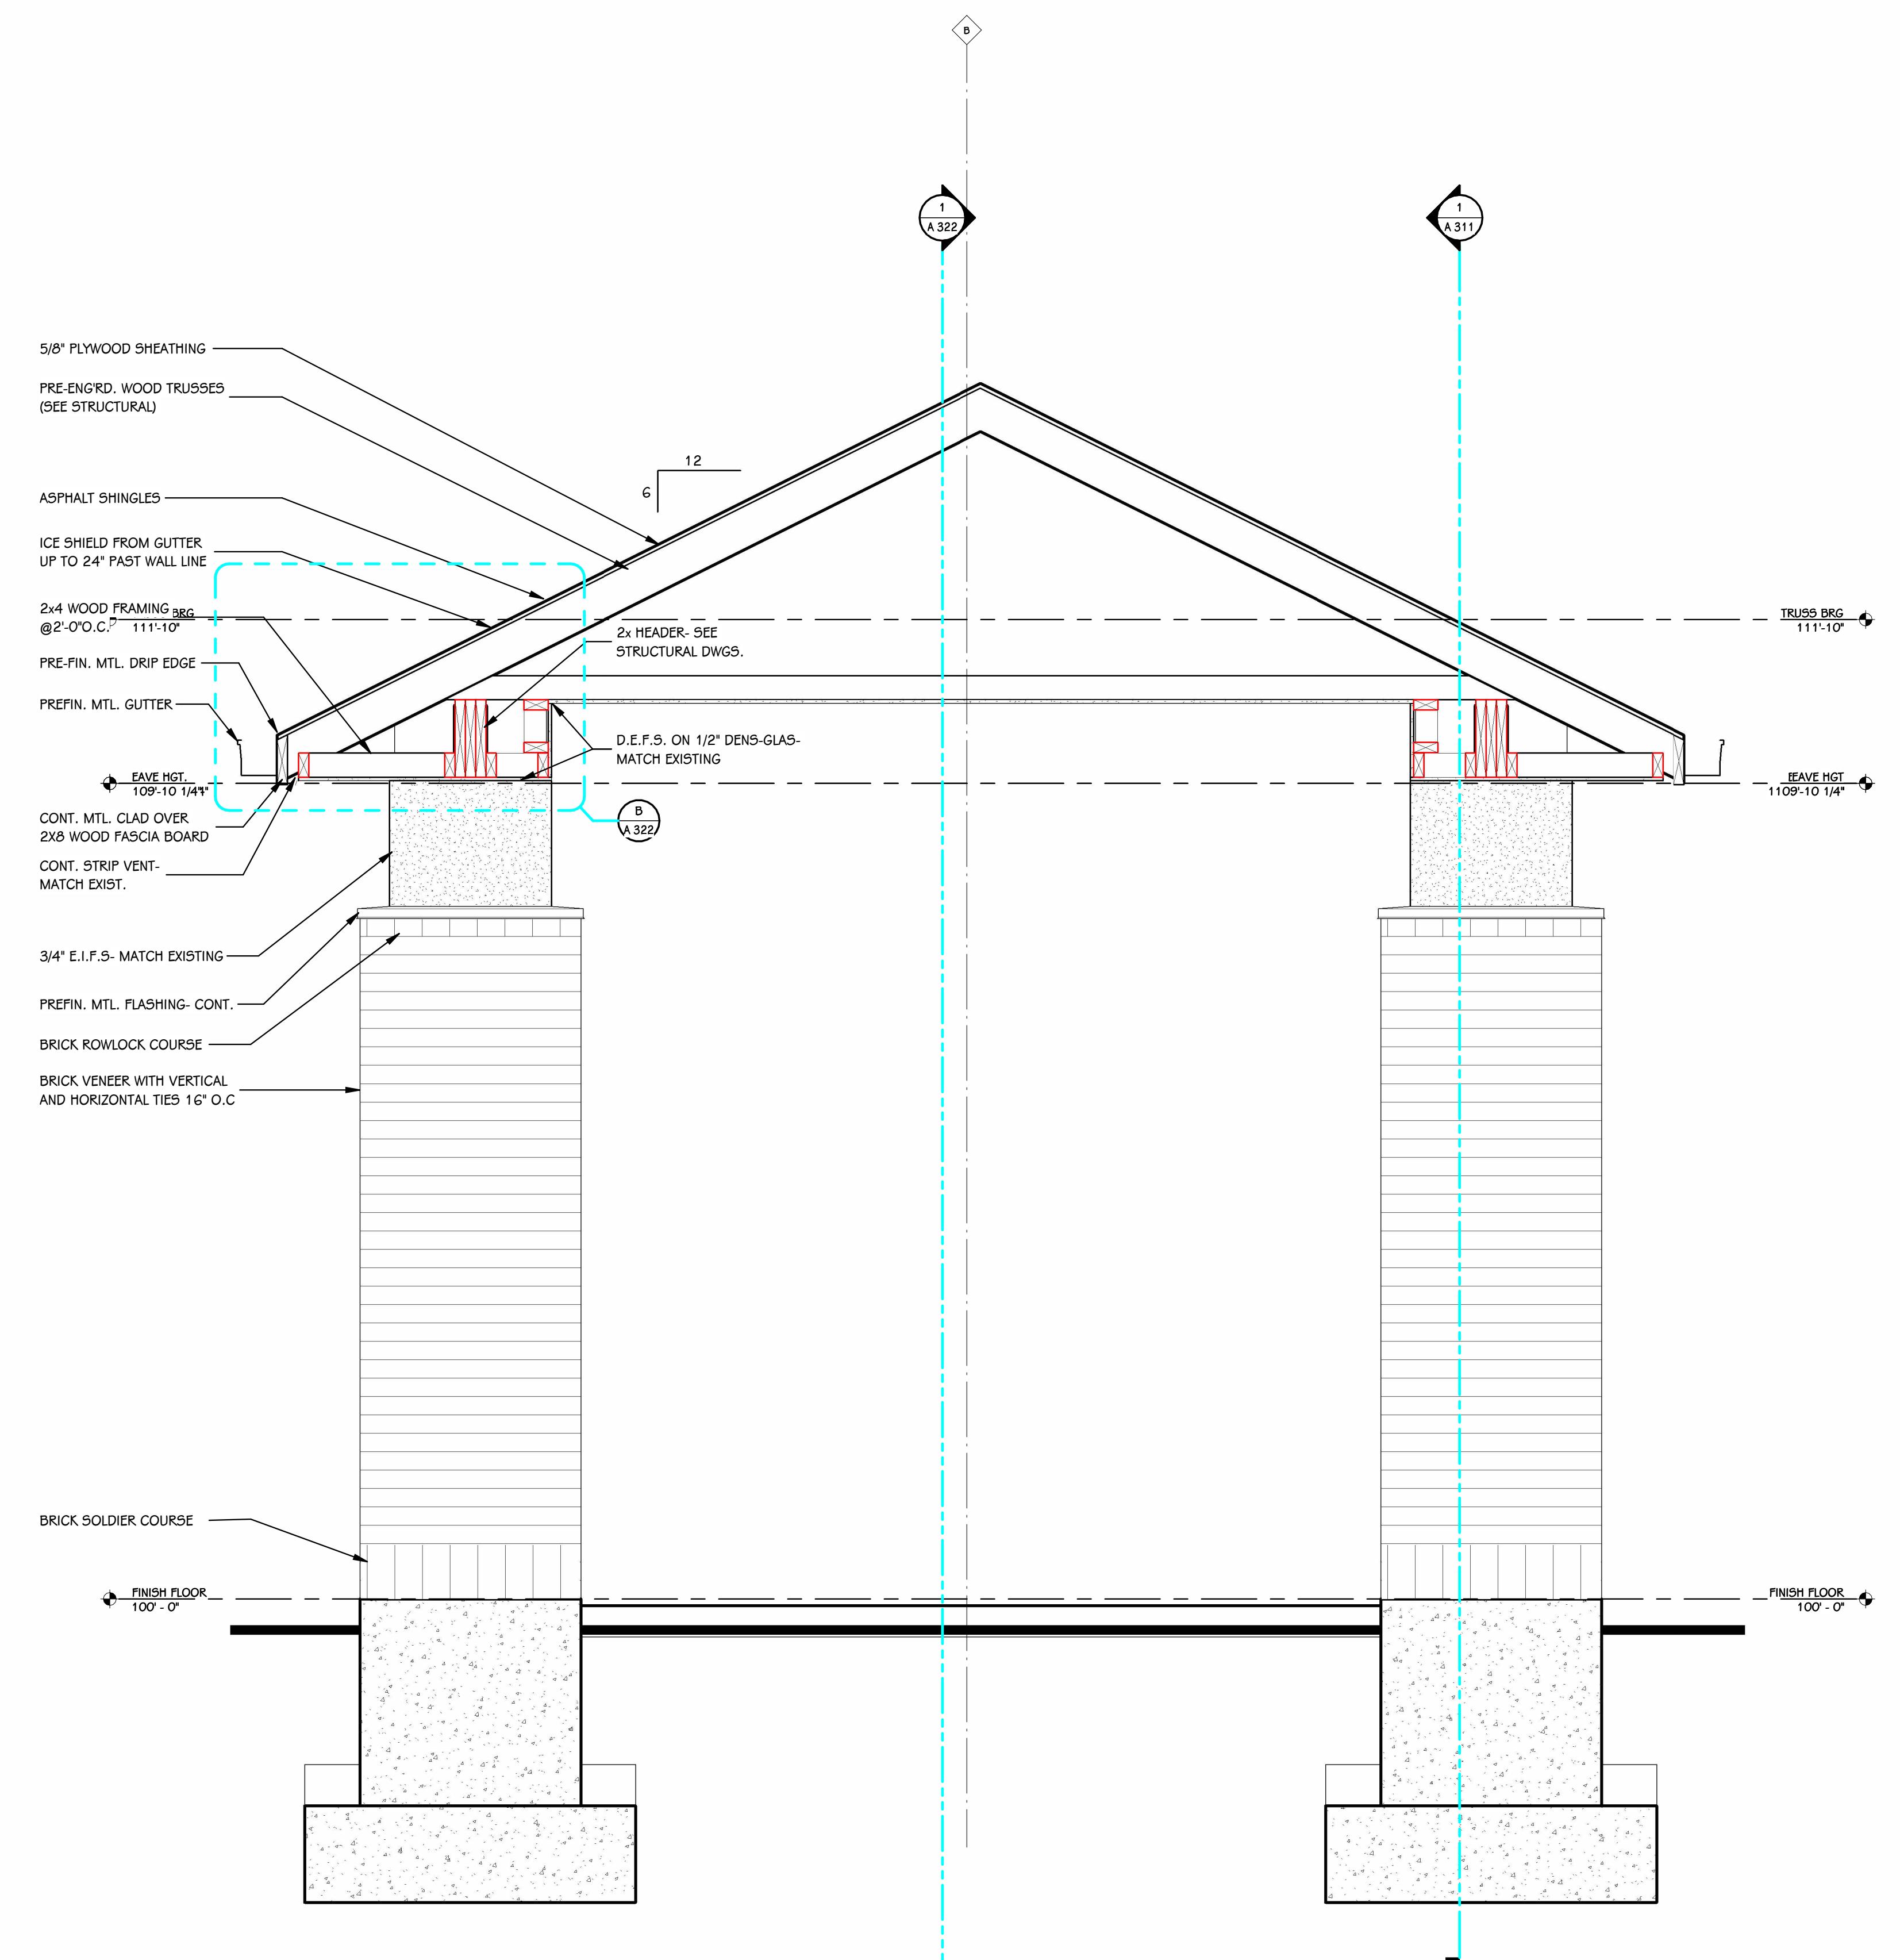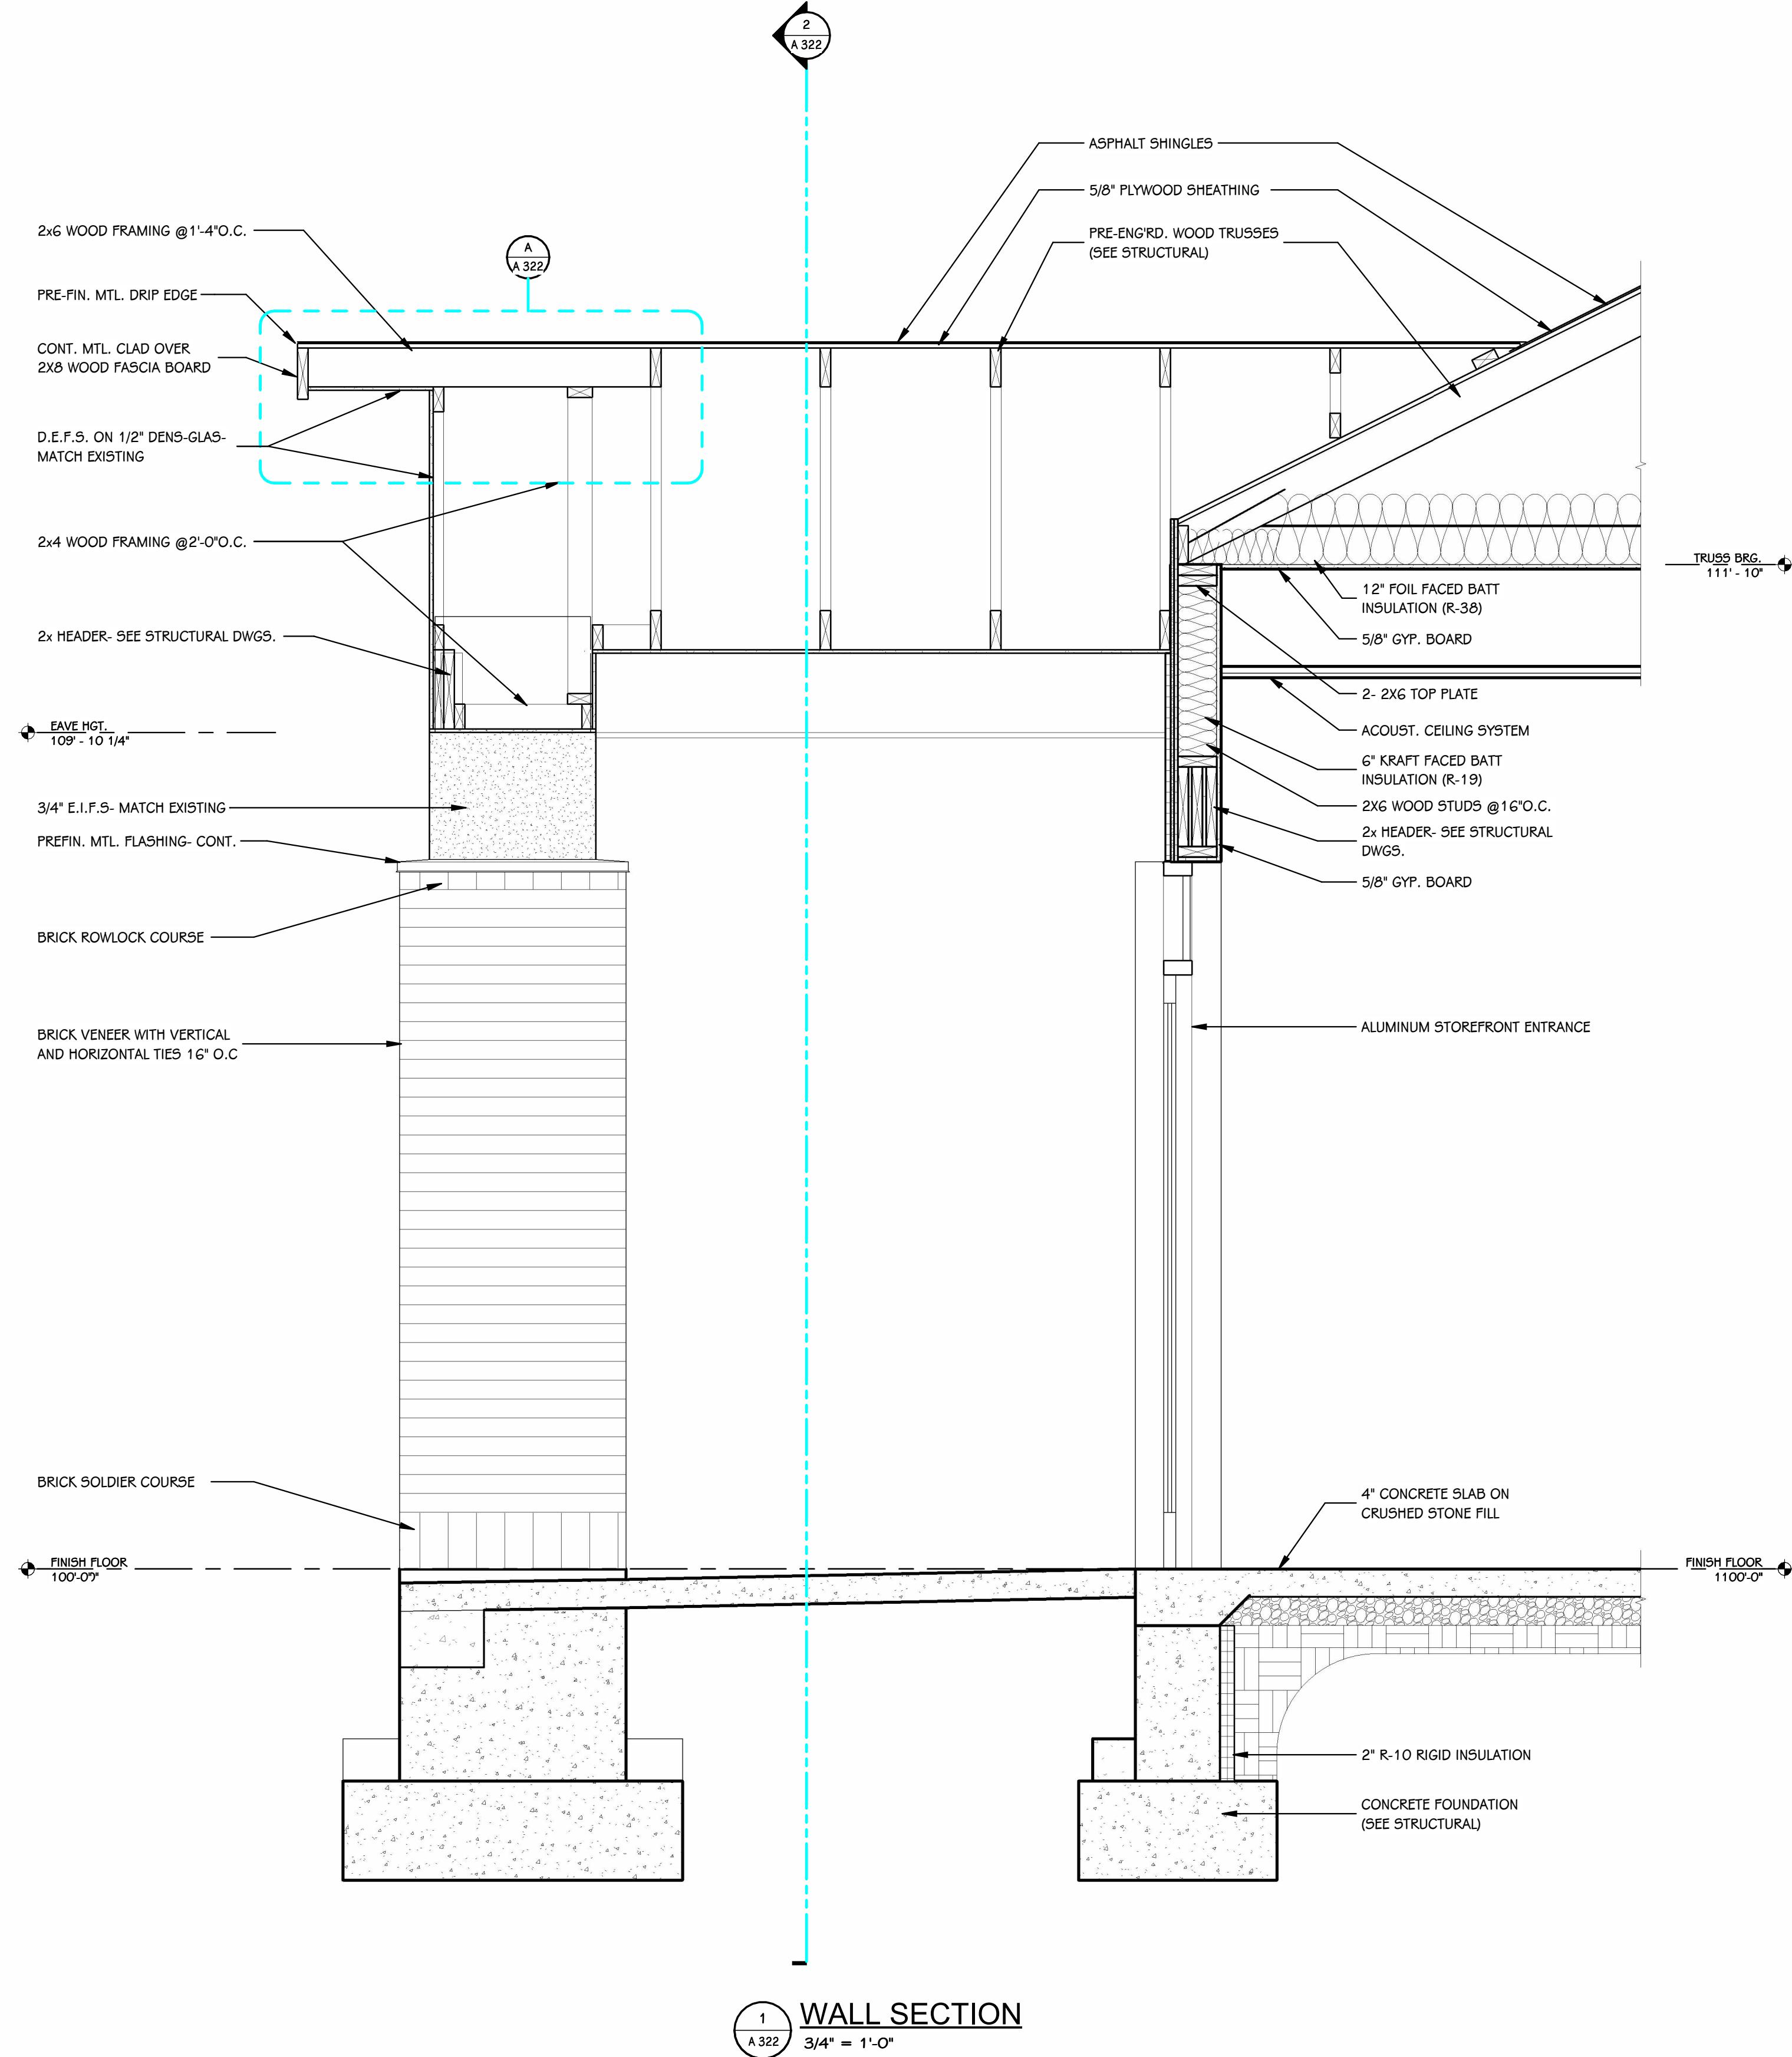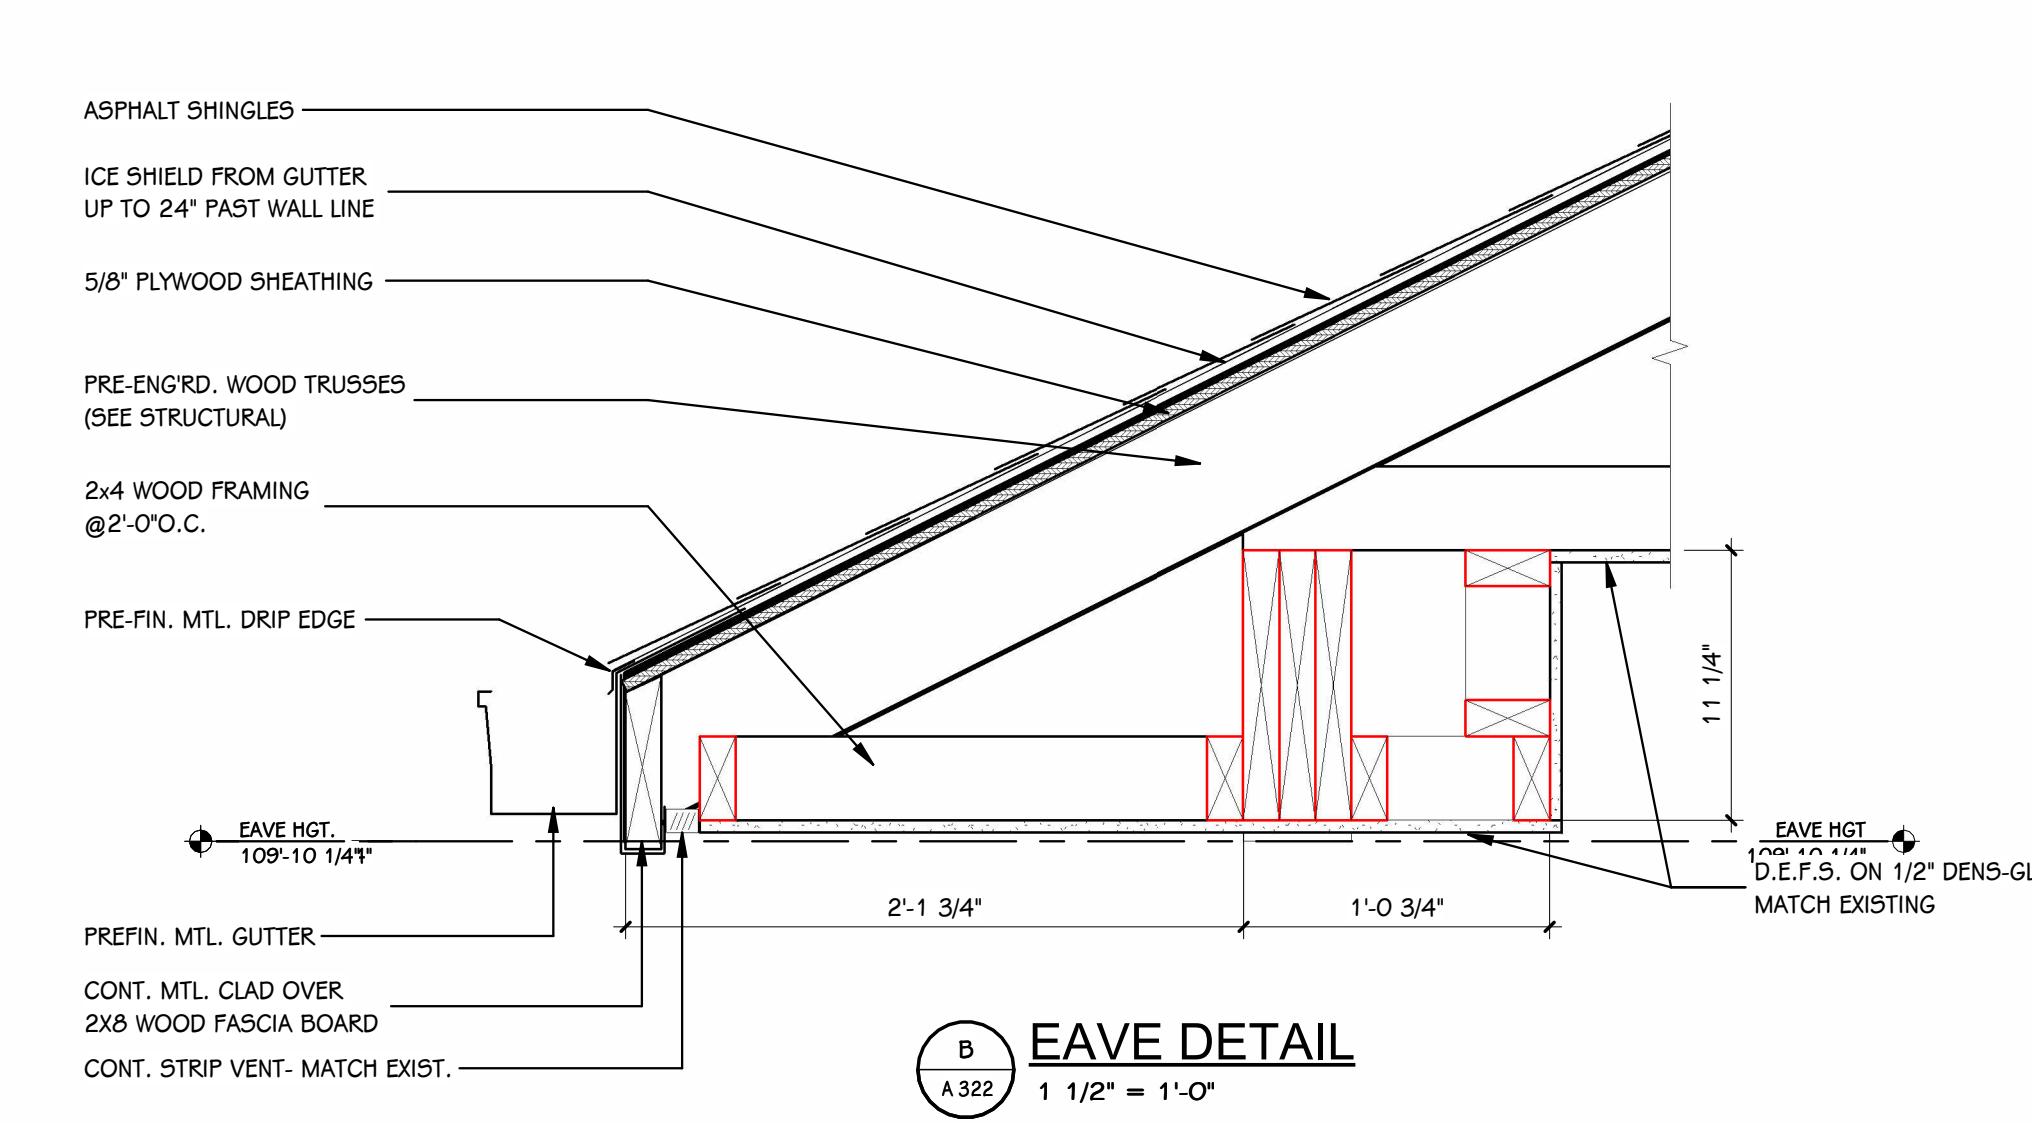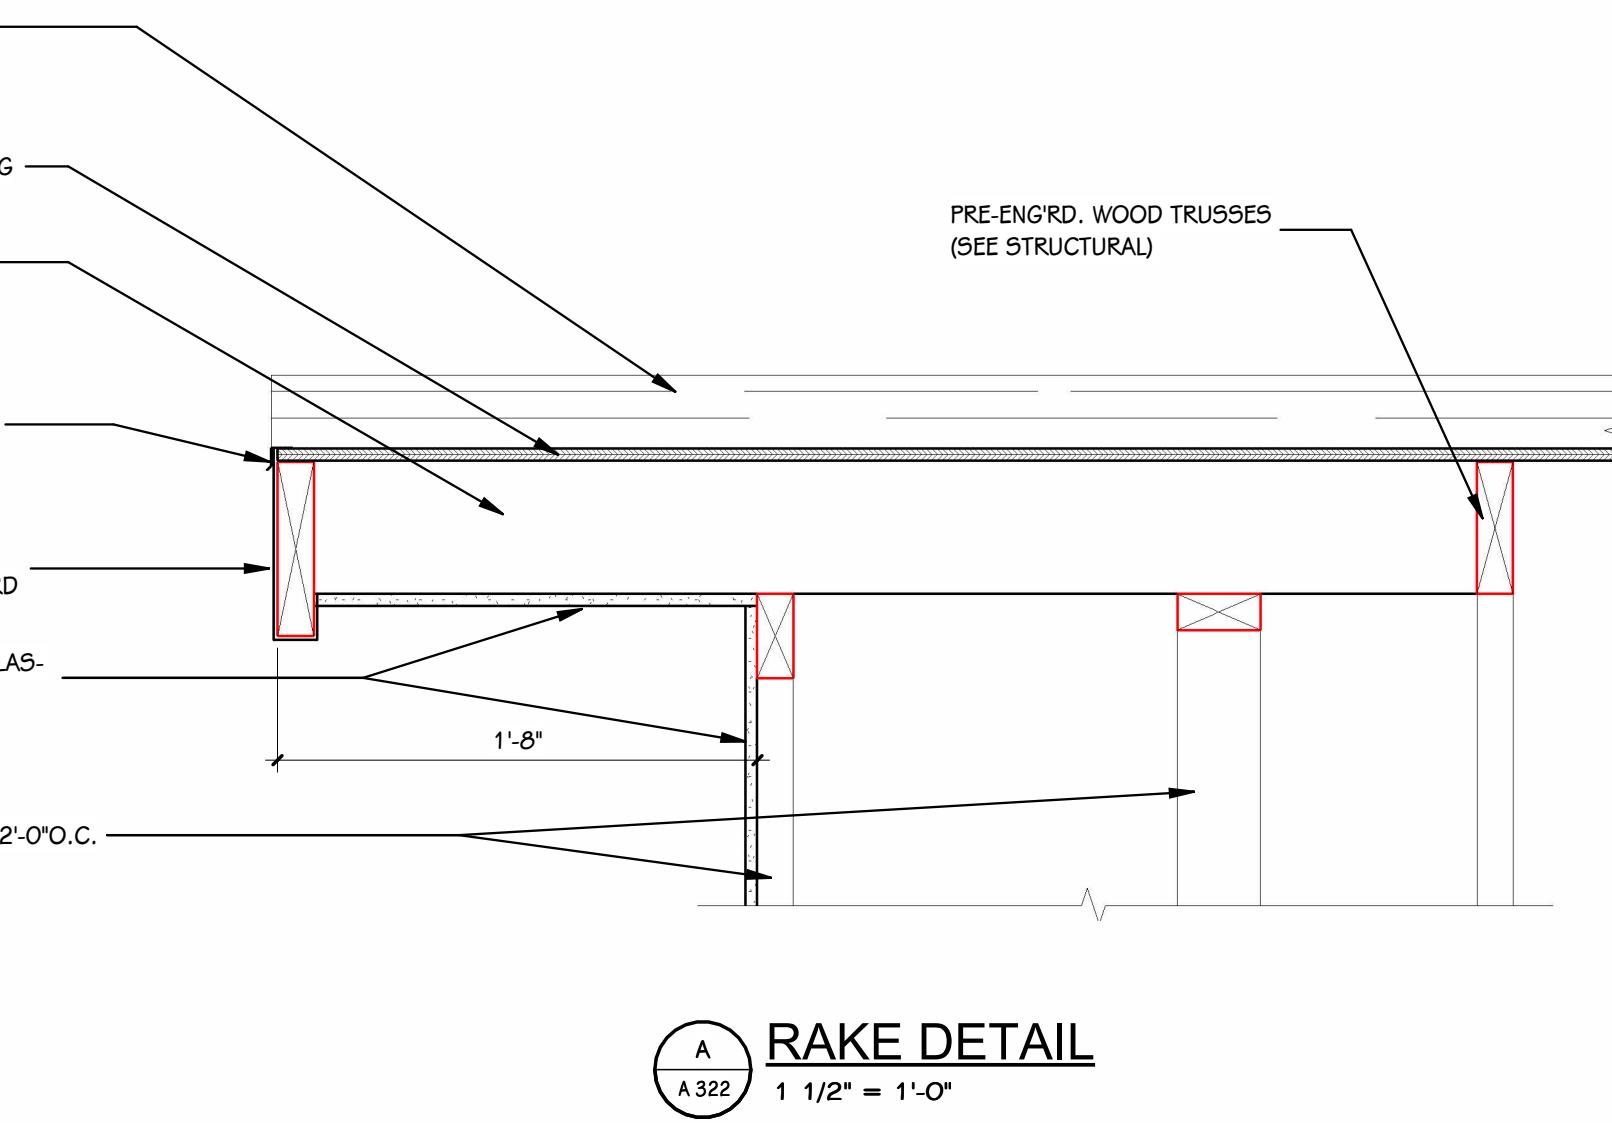


PROJECT TITLE
 TEAMSTERS LOCAL 2727
 BUILDING ADDITION

 OWNER
 TEAMSTERS LOCAL 2727


 SHEET TITLE
 ENLARGED TOILET ROOM PLANS,
 BARRIER-FREE DETAILS, TYPICAL
 MOUNTING HEIGHTS, ETC. AND
 INTERIOR ELEVATIONS
 SHEET NUMBER
 A 401
 25-376.000

 DATE
 JANUARY 9, 2026

 DRAWN BY: XXX
 11/13/2025 3:16:35 PM
 1/2" = 1'-0"

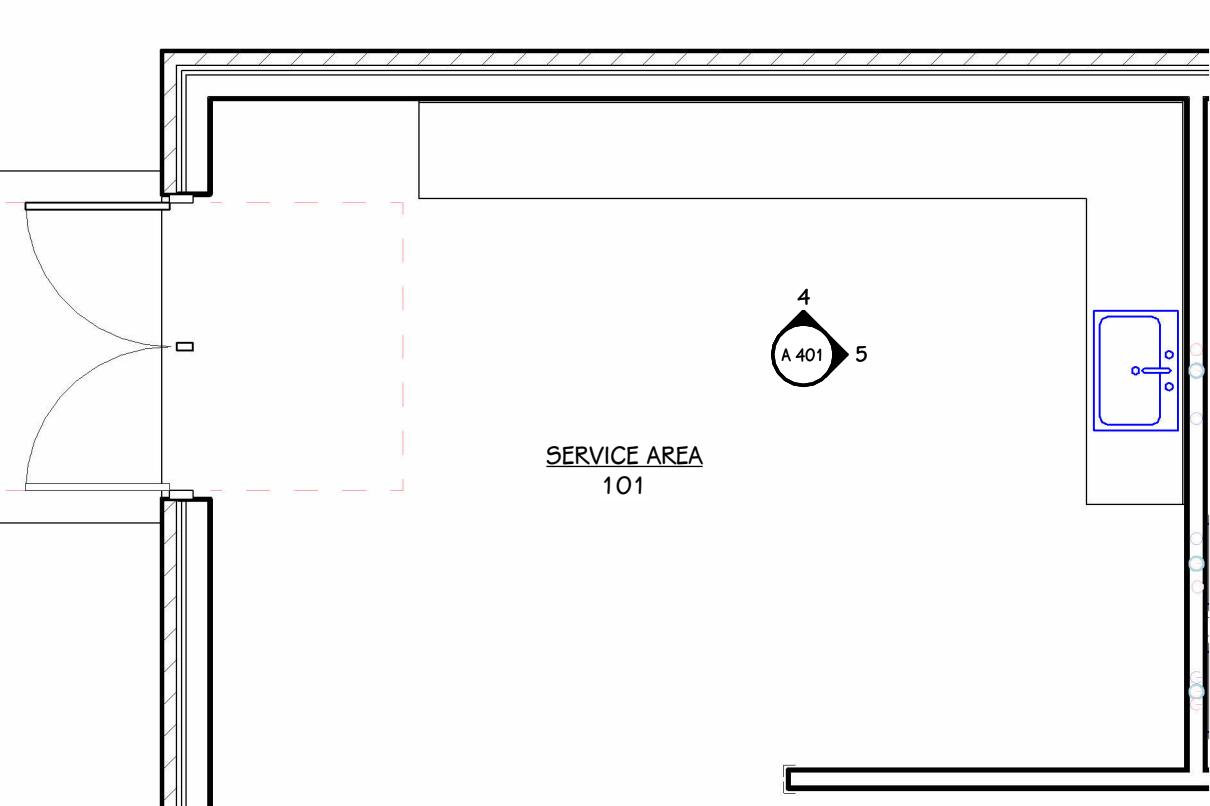
 4810 N Preston Hwy
 Shepherdsville, KY


1 ENLARGED SERVICE AREA
 A 401 1/4" = 1'-0"

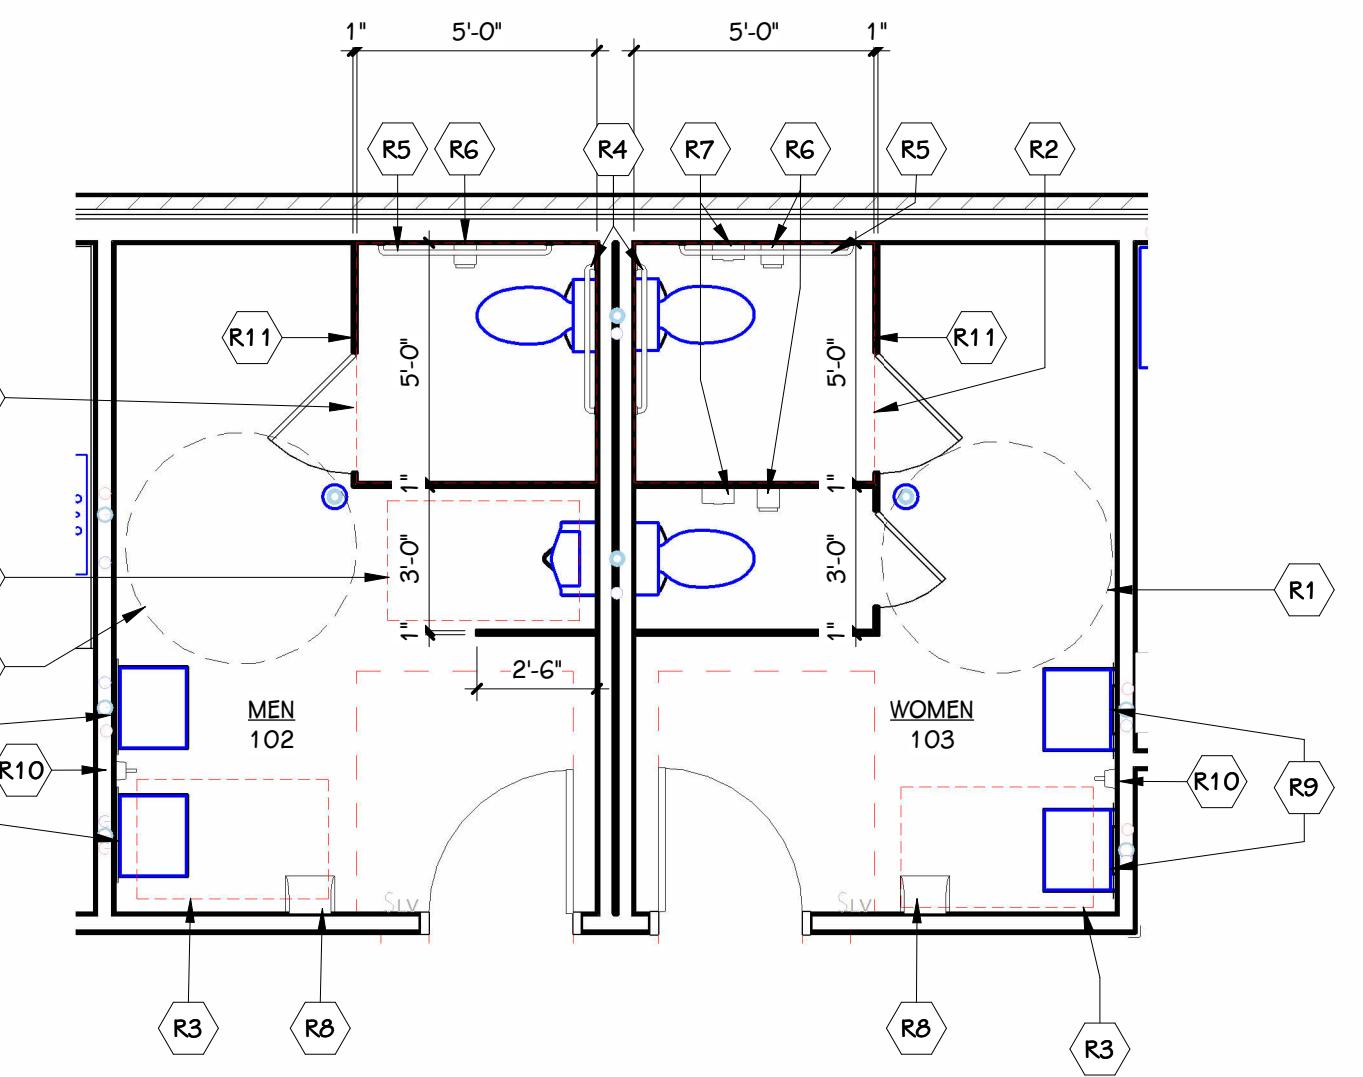


2 ENLARGED RESTROOM PLAN
 A 401 1/4" = 1'-0"


RESTROOM KEYNOTES		NOTES - TOILET ACCESSORY
NOTES: REFER TO MOUNTING HEIGHT DETAILS ON SHEET PROVIDE WOOD BLOCKING FOR ALL WALL-HUNG ACCESSORIES		
<p>R1 CLEAR FLOOR SPACE- 60" DIAMETER WHEELCHAIR TURNING SPACE</p> <p>R2 CLEAR FLOOR SPACE- 56"X60" CLEAR FLOOR SPACE AT WATER CLOSET</p> <p>R3 CLEAR FLOOR SPACE- 30"X48" SPACE AT LAVATORY, SINK OR ELECTRIC WATER COOLER, URINAL</p> <p>R4 REAR WALL GRAB BAR (36" HORIZ.): SURFACE-MOUNTED, MOUNT PER ICC/ANSI AND ADA; COORDINATE MOUNTING WITH LAVATORY, MIRROR, AND SOAP DISPENSER</p> <p>R5 SIDE WALL GRAB BAR (42" HORIZ. AND 18" VERT.): SURFACE-MOUNTED, MOUNT PER ICC/ANSI AND ADA COORDINATE WITH GRAB BARS AND SANITARY NAPKIN DISPOSAL, IF APPLICABLE</p> <p>R6 TOILET PAPER DISPENSER: OWNER FURNISHED; CONTRACTOR INSTALLED; SURFACE-MOUNTED, MOUNT PER ICC/ANSI AND ADA COORDINATE WITH GRAB BARS AND SANITARY NAPKIN DISPOSAL, IF APPLICABLE</p> <p>R7 SANITARY NAPKIN DISPOSAL: SURFACE-MOUNTED, MOUNT PER ICC/ANSI AND ADA COORDINATE WITH GRAB BARS AND TOILET PAPER DISPENSER;</p>		
<p>R8 PAPER TOWEL DISPENSER- OWNER FURNISHED; CONTRACTOR INSTALLED; SURFACE-MOUNTED, MOUNT PER ICC/ANSI AND ADA; COORDINATE WITH LAVATORY, MIRROR, AND SOAP DISPENSER</p> <p>R9 24" X 36" MIRROR.</p> <p>R10 SOAP DISPENSER: OWNER FURNISHED; CONTRACTOR INSTALLED; SURFACE-MOUNTED, MOUNT PER ICC/ANSI AND ADA; COORDINATE MOUNTING WITH LAVATORY, MIRROR, AND PAPER TOWEL DISPENSER</p> <p>R11 TOILET PARTITIONS: 1" SOLID PANEL. PROVIDE LAYOUT SHOWN WITHIN THE ENTIRE ROOM WITH CLEAR DIMENSIONS AS INDICATED.</p>		
NOTES - INTERIOR ELEVATIONS		
1 NOT ALL MATERIALS ARE ILLUSTRATED, REFER TO FINISH PLANS AND TYPICAL DETAILS FOR ADDITIONAL INFORMATION.		
GENERAL NOTES - CASEWORK		
<p>1 VERIFY ALL DIMENSIONS IN THE FIELD PRIOR TO FABRICATION.</p> <p>2 FILLER PANELS SHALL BE NO LESS THAN 2" WIDE, UNLESS NOTED OTHERWISE.</p> <p>3 REFER TO FLOOR FINISH PLANS FOR CASEWORK AND COUNTERTOP FINISHES BY ROOM.</p> <p>4 FINISH ANY EXPOSED END PANELS, UNDERSIDE OF CABINETS OR OPEN CABINETS, WITH PLASTIC LAMINATE SPECIFIED FOR FRONTS IN THAT ROOM.</p> <p>5 ALL VERTICAL AND HORIZONTAL EXPOSED AND SEMI-EXPOSED SURFACES TO BE FINISHED WITH BODY PLASTIC LAMINATE.</p> <p>6 PATTERN OR GRAIN DIRECTION TO BE VERTICAL ON DOORS AND HORIZONTAL ON DRAWERS - PER AWI STANDARDS, UNLESS NOTED OTHERWISE.</p> <p>7 SLABSMITHING WILL BE REQUIRED IN INSTANCES WHERE A PATTERNED QUARTZ, NATURAL STONE, OR SOLID SURFACE IS SPECIFIED.</p>		

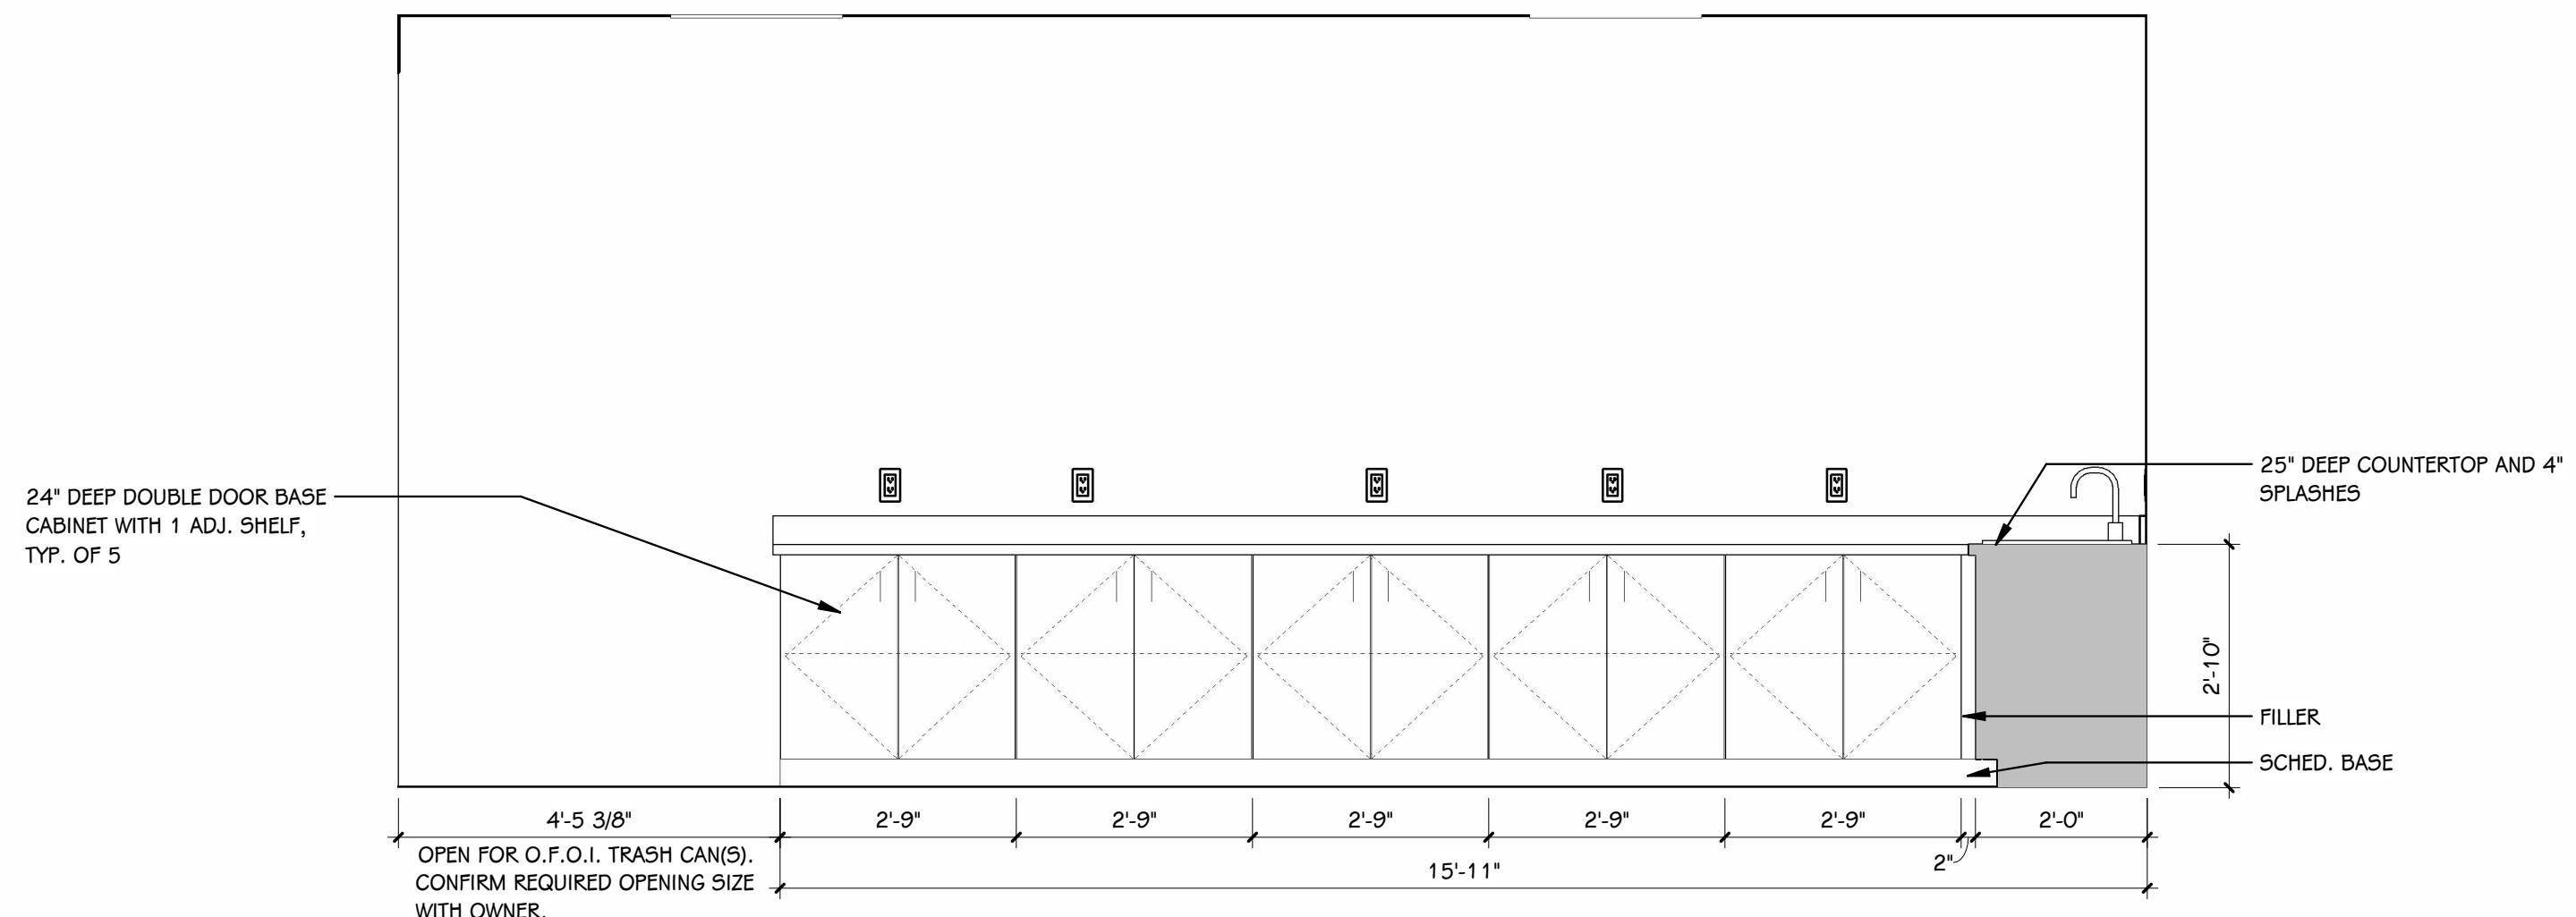 ISSUED FOR DATE
 HEATHER D. GREEN
 8728
 COMMONWEALTH
 OF MASSACHUSETTS
 ARCHITECT
 Heather D. Green


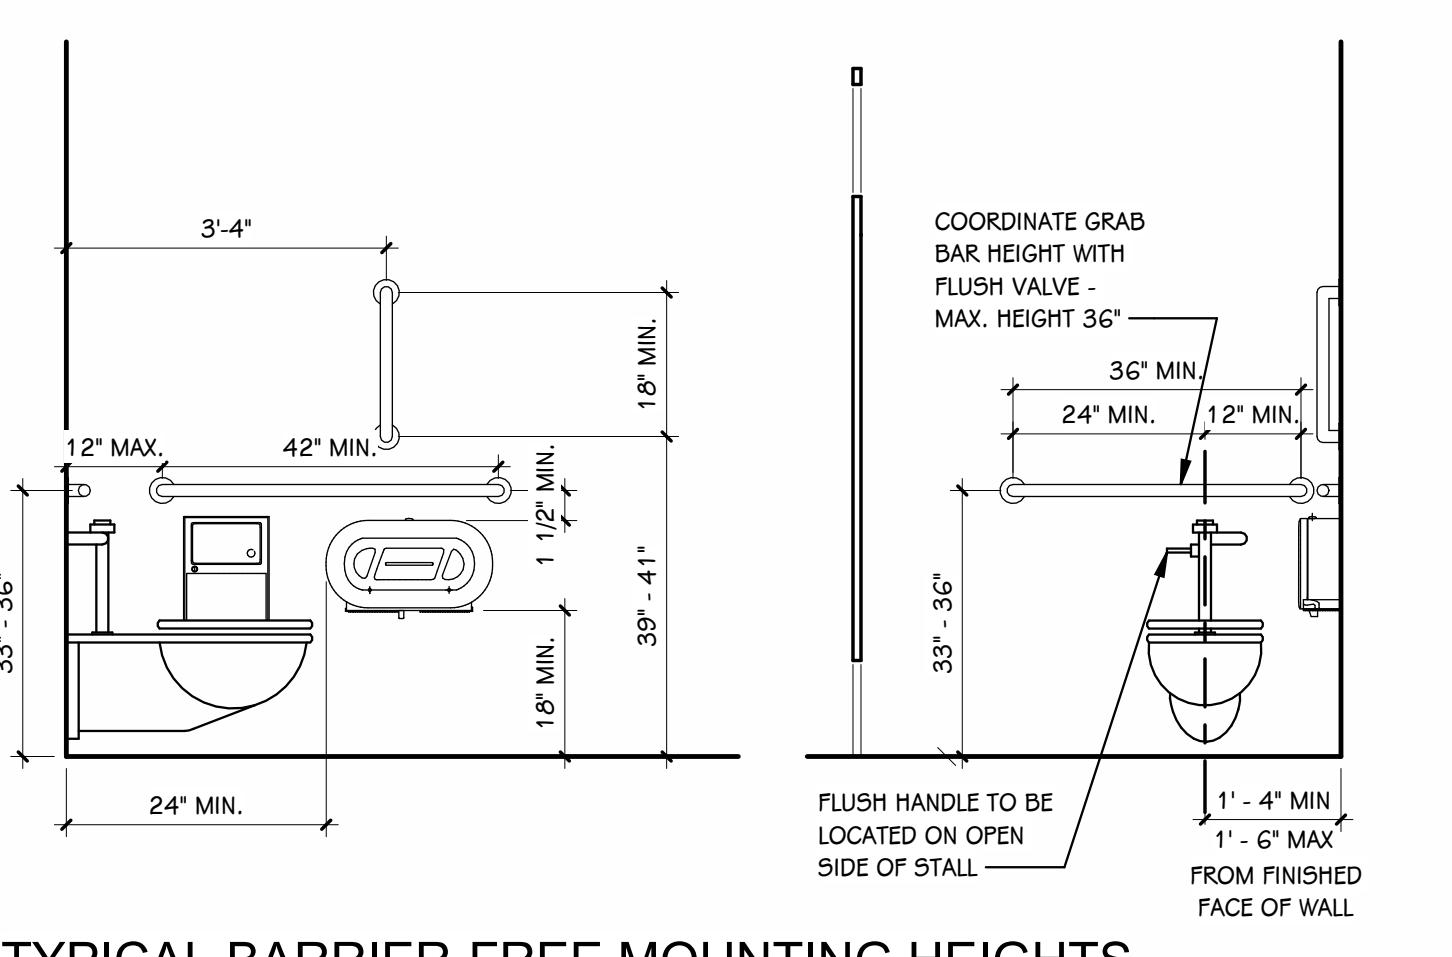
4 SERVICE AREA 101- EAST ELEVATION
 A 401 1/2" = 1'-0"

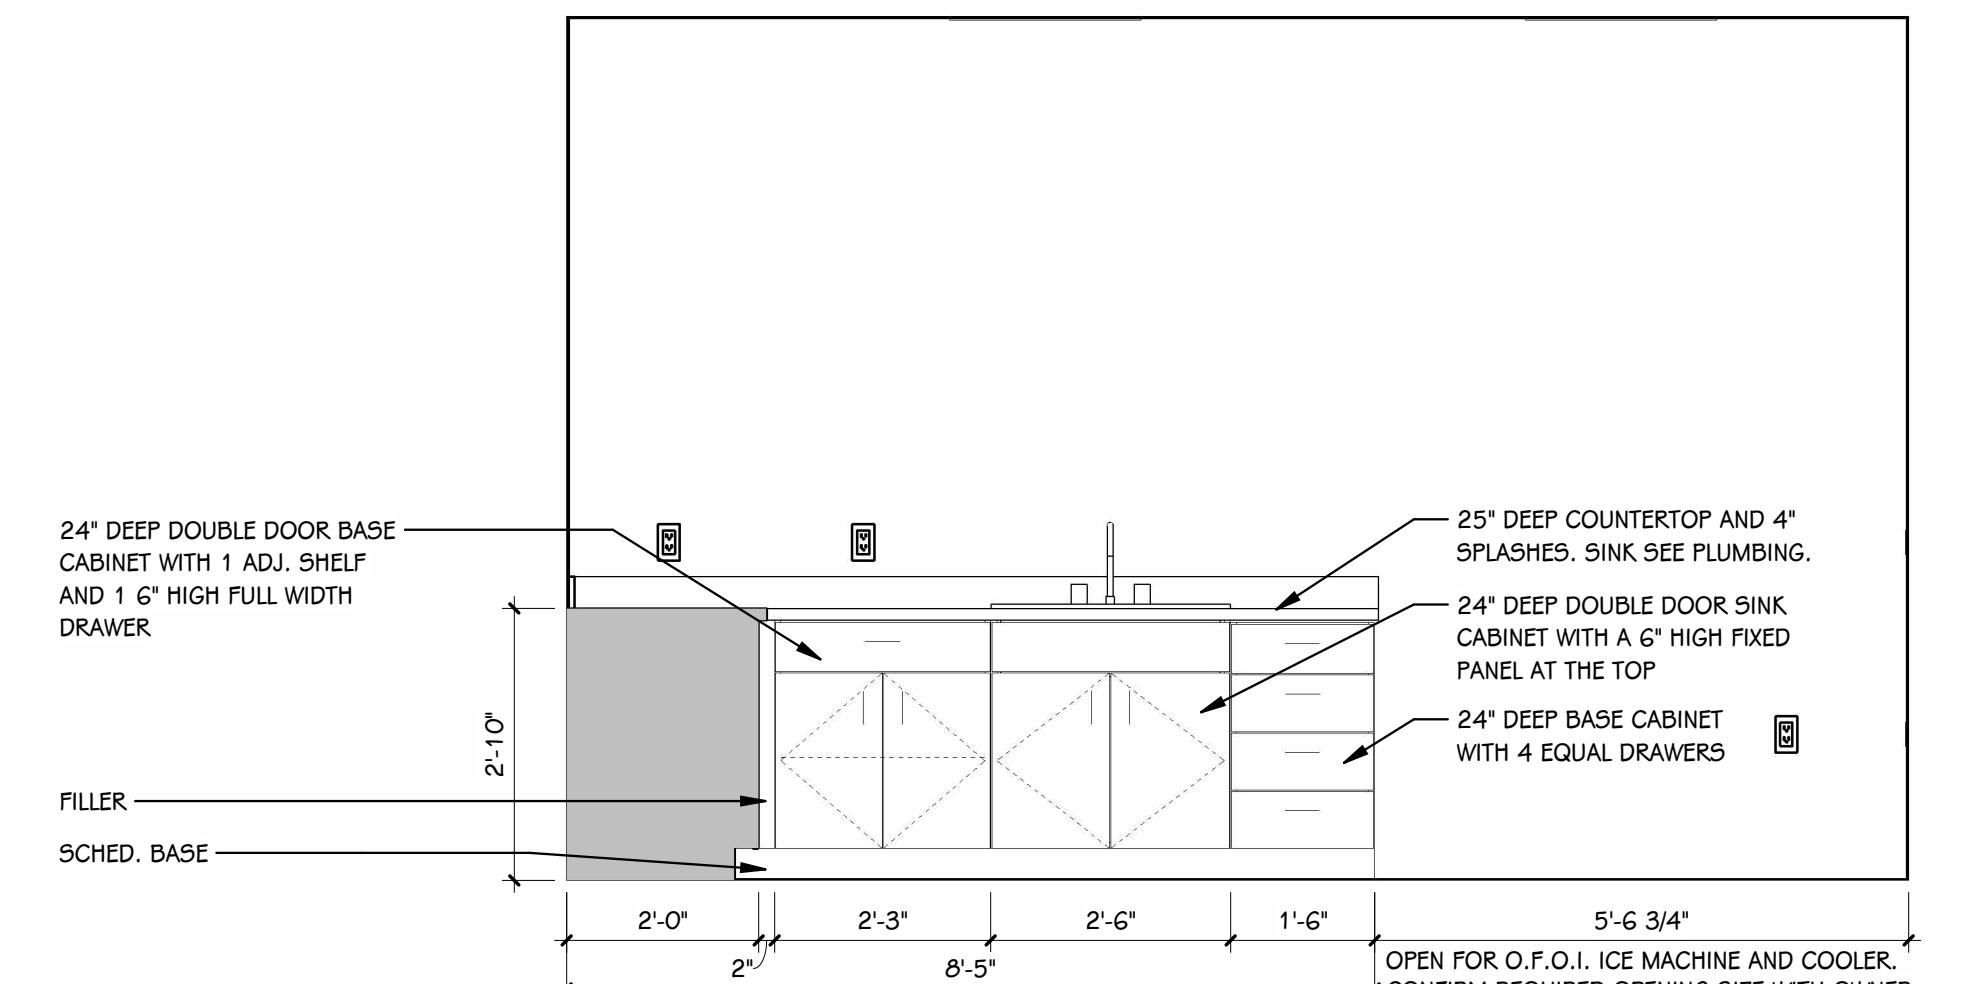

5 SERVICE AREA 101- SOUTH ELEVATION
 A 401 1/2" = 1'-0"

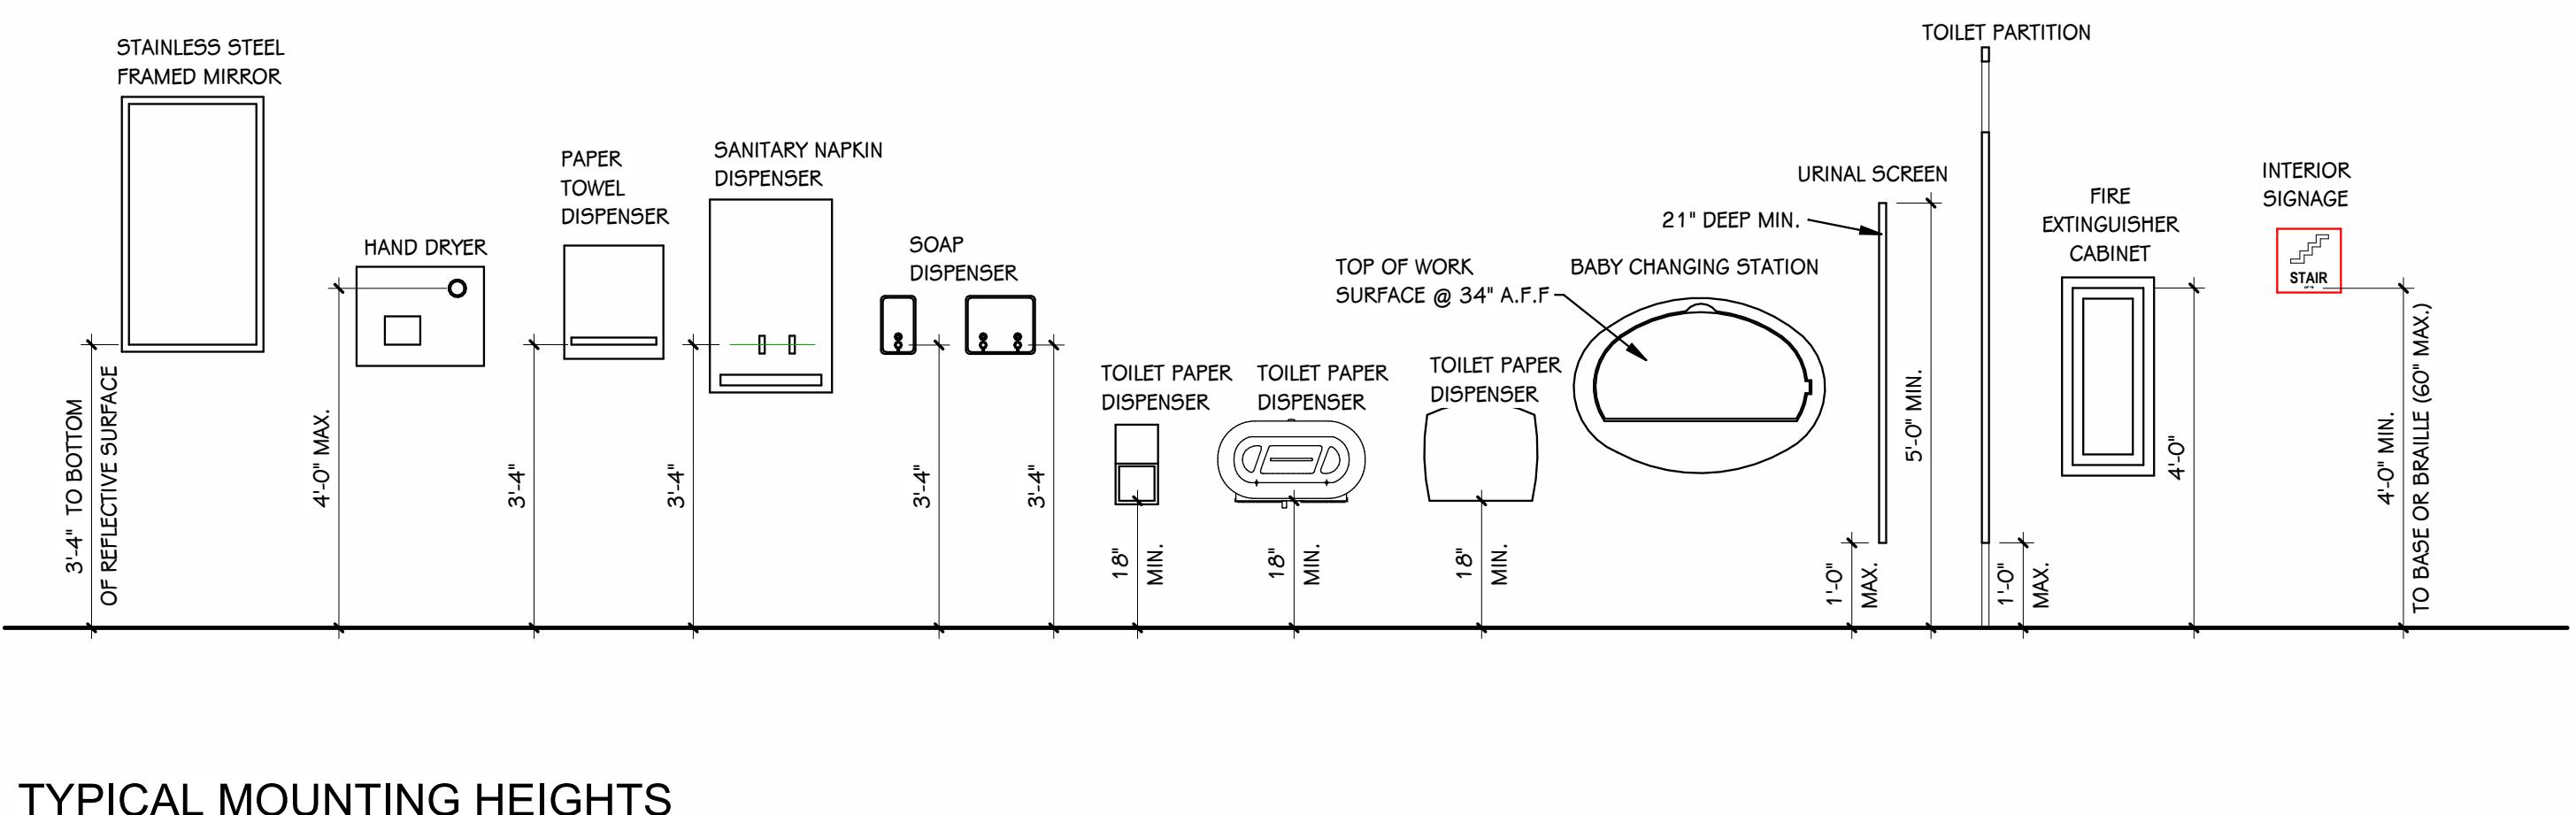

TYPICAL MOUNTING HEIGHTS
 1/2" = 1'-0"




TYPICAL BARRIER-FREE MOUNTING HEIGHTS
 1/2" = 1'-0"

Door Schedule																				
Number		Room Name	Fire Rating		Door			Size		Frame			Details			Glass	Access Controls		HWR Set	Remarks
Door	Room		Door	Frame	Type	Mat	Fin	Width	Height	Elev	Mat	Fin	Head	Jamb	Sill		Card Reader	Elec. HWR		
100	100	MEETING ROOM	-	-	FG	AL	ANOD	6' - 0"	7' - 0"	-	AL	ANOD	4/A501	3/A501	-	-	Yes	Yes	1	-
101	101	SERVICE AREA	-	-	FG	AL	ANOD	6' - 0"	7' - 0"	-	AL	ANOD	4/A501	3/A501	-	-	Yes	Yes	1	-
102	102	MEN	-	-	F	WD	PREFIN	3' - 0"	7' - 0"	-	HM	P-2	1/A501	2/A501	-	-	No	No	2	-
103	103	WOMEN	-	-	F	WD	PREFIN	3' - 0"	7' - 0"	-	HM	P-2	1/A501	2/A501	-	-	No	No	2	-
104	104	MECHANICAL	-	-	F	WD	PREFIN	3' - 0"	7' - 0"	-	HM	P-2	1/A501	2/A501	-	-	No	No	3	-
105	105	SWAG ROOM	-	-	F	WD	PREFIN	3' - 0"	7' - 0"	-	HM	P-2	6/A501	7/A501	-	-	No	No	4	-
106A	106	CONFERENCE ROOM	-	-	F	WD	PREFIN	3' - 0"	7' - 0"	-	HM	P-2	1/A501	2/A501	-	-	No	No	7	-
106B	106	CONFERENCE ROOM	-	-	F	WD	PREFIN	3' - 0"	7' - 0"	-	HM	P-2	1/A501	2/A501	-	-	No	No	5	-
106C	106	CONFERENCE ROOM	-	-	F	WD	PREFIN	6' - 0"	7' - 0"	-	HM	P-2	6/A501	7/A501	-	-	No	No	6	-
107	107	STORAGE	-	-	F	WD	PREFIN	3' - 0"	7' - 0"	-	HM	P-2	6/A501	7/A501	-	-	No	No	5	-
110	110	STORAGE	-	-	F	WD	PREFIN	3' - 0"	7' - 0"	-	HM	P-2	1/A501	2/A501	-	-	No	No	-	REUSE EXISTING HARDWARE

GENERAL NOTES - DOORS	
1	REFER TO A 500's SHEETS FOR ADDITIONAL ACCESS CONTROL INFORMATION NOT NOTED ON THIS SHEET.

TowerPinkster

Interior Design • Towerpinks

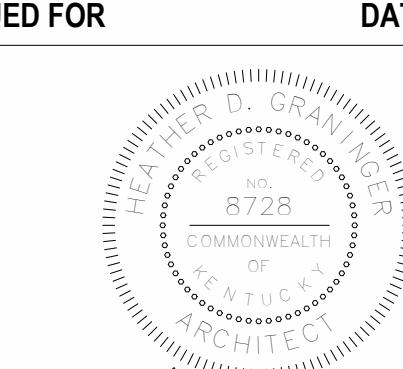


Frank D. Gravitt

TEAMS|ERS LOCAL 2721 BUILDING ADDITION

TEAMS | ERS LOCAL 2721

DOOR SCHEDU

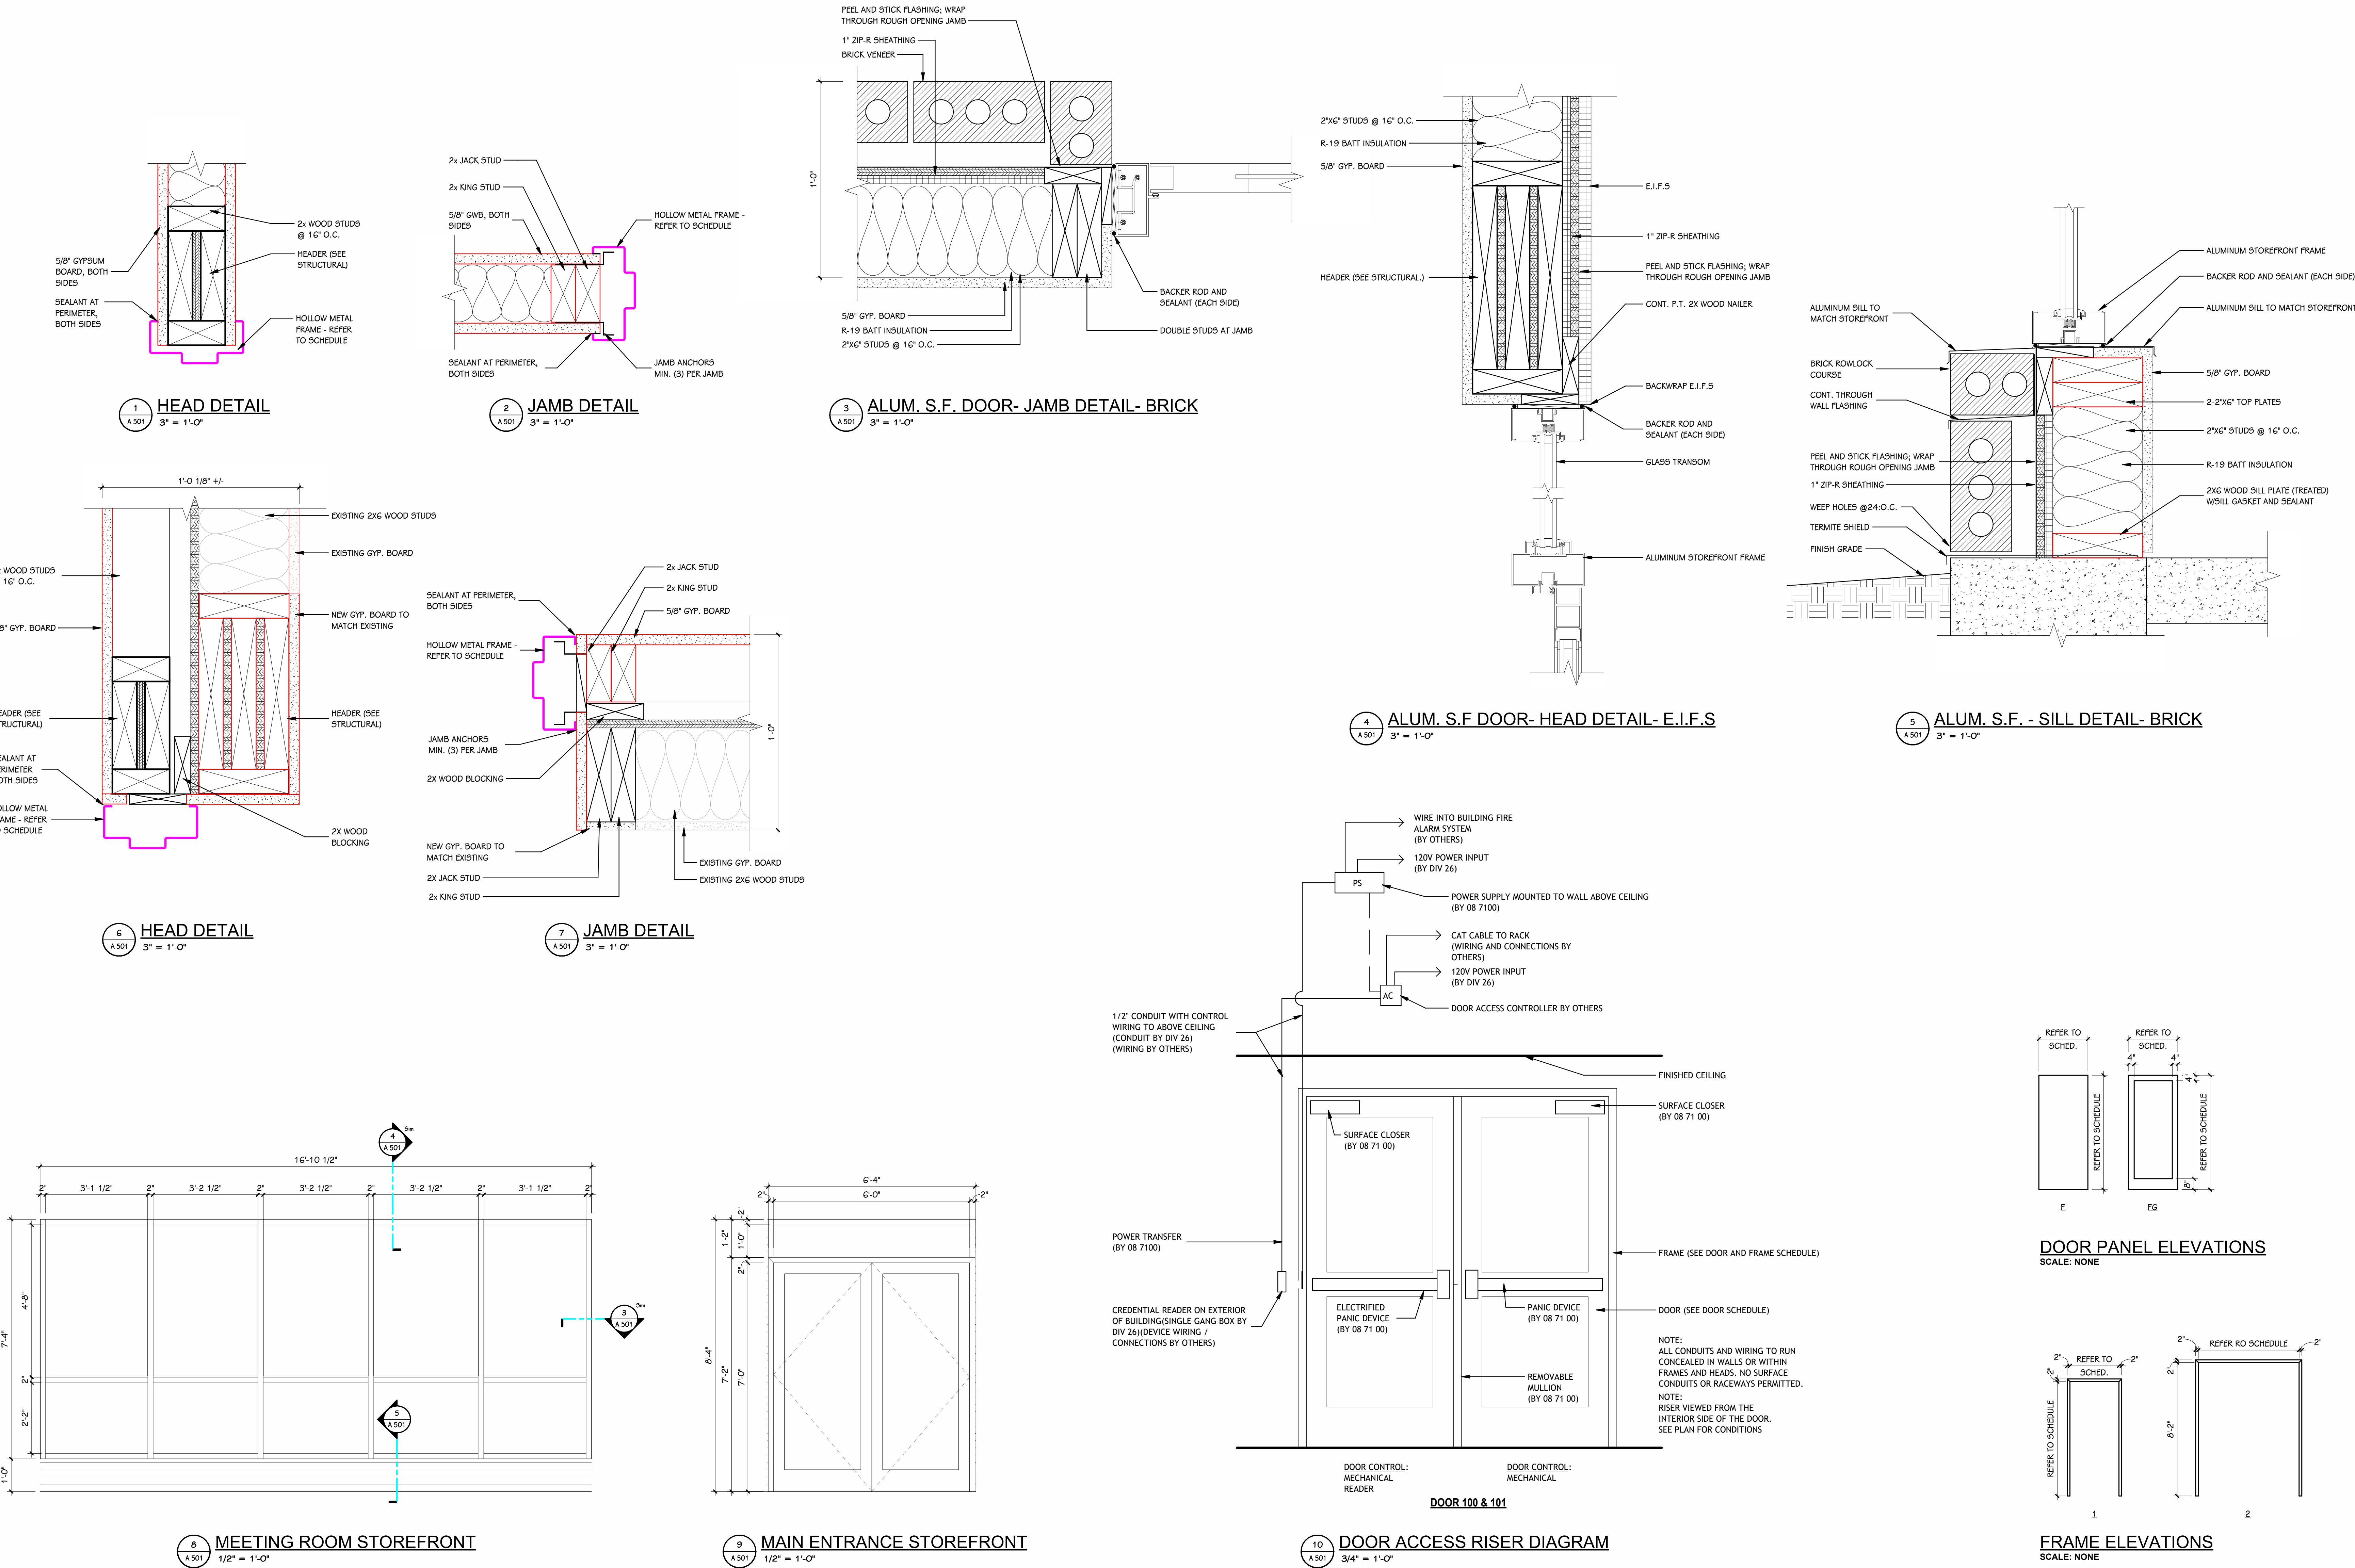

PROJECT TITLE
TEAMSTERS LOCAL 2727
BUILDING ADDITION

OWNER
TEAMSTERS LOCAL 2727

4810 N Preston Hwy
Shepherdsville, KY

SHEET TITLE
TYPICAL SYMBOLS & GENERAL NOTES

DATE
JANUARY 9, 2026

SHEET NUMBER
IG 001

PAGE
25-376.000


DEFINITIONS/ABBREVIATIONS - INTERIORS	INTERIOR - TYPICAL SYMBOLS AND REFERENCES
ADJ ADJUSTABLE AFF ABOVE FINISHED FLOOR BF BARRIER FREE CB COMBO BOARD CC CHARGING CART CG CORNER GUARD CL CENTER LINE CLR CLEAR OPENING CP COUNTERTOP PRINTER D DRYER DR DRAPERY DW DISHWASHER EX EXISTING FP FILLER PANEL GB GLASS BOARD HB HORIZONTAL BLIND HOLD HOLD DIMENSION IM ICE MACHINE KLN KILN LAM LAMINATOR MB MARKER BOARD MFP MULTIFUNCTION PRINTER MIN MINIMUM CODE ALLOWABLE DIMENSION MW MICROWAVE OC ON CENTER OFE OWNER FURNISHED EQUIPMENT OPP OPPOSITE PIO PULL OUT DRAWER PA P.A. SYSTEM PM POSTAGE MACHINE REF REFRIGERATOR RP REMOVABLE PANEL RS ROLLER SHADE SCN SCAN SF SAFE SH SHREDDER SIM SIMILAR TB TACK BORD TYP TYPICAL UC UNDER COUNTER REFRIGERATOR UN UNLESS OTHERWISE NOTED VIF VERIFY IN FIELD VLB VERTICAL LOUVER BUND W WASHER W/D WASHER/DRYER STACKED	<p>INDICATES MATERIAL TYPE X-# INDICATES CORRESPONDING SELECTION IN MATERIAL SELECTION SCHEDULE</p> <p>X-# INDICATES WALL FINISH X-# INDICATES BASE FINISH X-# INDICATES FLOOR FINISH</p> <p>WHERE HEIGHTS ARE NOT INDICATED REFER TO TYPICAL DETAIL OR ELEVATION</p> <p>X-# - ABOVE 0'-0" A.F.F. INDICATES UPPER WALL FINISH X-# - UP TO 0'-0" A.F.F. INDICATES LOWER WALL FINISH X-# INDICATES BASE FINISH X-# INDICATES FLOOR FINISH</p> <p>X-# INDICATES COUNTERTOP FINISH X-# INDICATES CABINET FINISH (BASE AND UPPER)</p> <p>X-# INDICATES EXTENT OF ATYPICAL FINISH (WALL, BASE, OR FLOOR)</p> <p>X-X INDICATES DISSIMILAR FLOOR MATERIAL FINISHES, REFER TO TYPICAL FLOOR TRANSITION DETAILS</p> <p>MULTI INDICATES MULTIPLE MATERIALS, REFER TO ENLARGED PLANS OR ELEVATIONS</p> <p>X-P(A) INDICATES PATTERNED INSTALLATION OF A SINGLE MATERIAL TYPE, REFER TO DETAIL OR ELEVATION INDICATES PATTERN INTENT, REFER TO DETAIL OR ELEVATION</p> <p>XD-# INDICATES VISUAL DISPLAY BOARD, REFER TO VISUAL DISPLAY BOARD SCHEDULES</p> <p>CG-# INDICATES CORNER GUARD, REFER TO MATERIAL SELECTION SCHEDULE</p> <p>XX-# INDICATES WINDOW TREATMENT, REFER TO WINDOW TREATMENT SCHEDULE</p> <p>INDICATES INSTALLATION OF GRAIN</p>
	<p>GENERAL NOTES - INTERIOR - FINISH</p> <p>1 REFER TO MATERIAL SELECTION SCHEDULE FOR FINISH INFORMATION. 2 REFER TO ARCHITECTURAL FLOOR PLANS AND SPECIFICATION FOR ADDITIONAL INFORMATION ON CONSTRUCTION MATERIALS. 3 REFER TO ARCHITECTURAL GENERAL SHEETS FOR BARRIER-FREE MOUNTING HEIGHT REQUIREMENTS AND CODE-REQUIRED SIGNAGE. 4 REFER TO ARCHITECTURAL ENLARGED TOILET ROOM PLANS FOR TOILET ACCESSORIES, PARTITIONS, ETC. 5 REFER TO REFLECTED CEILING PLANS FOR CEILING FINISH AND HEIGHTS. 6 WALL MOUNTED DIFFUSERS, GRILLES, ACCESS PANELS, ELECTRICAL PANELS, ETC. ARE TO BE PAINTED TO MATCH THE ADJACENT WALL FINISH. 7 CEILING ACCESS PANELS ARE TO BE PAINTED TO MATCH ADJACENT CEILING FINISH. 8 REFER TO DOOR SCHEDULE FOR FINISH ON DOORS AND FRAMES. 9 REFER TO INTERIOR ELEVATION SHEETS FOR REQUIREMENTS, GENERAL NOTES, ABBREVIATIONS, AND HARDWARE/ACCESSORY SELECTIONS FOR CASEWORK. 10 ALL FLOOR SUPPORTED STORAGE RACKS, CABINETS, BOOKCASES, ETC. WHEN ADJACENT TO THE WALL SHALL BE FASTENED TO BOTH THE FLOOR AND WALL. 11 PROVIDE BLOCKING AS REQUIRED FOR ATTACHMENT OF CASEWORK, MILLWORK, SHELVING, EQUIPMENT, SPECIALTY FINISHES, ETC. 12 DETAILS SHOWN ILLUSTRATE DESIGN INTENT, NOT ALL POSSIBLE CONDITIONS. FOR CONDITIONS NOT SHOWN USE DETAILS CLOSEST TO CONDITION IN QUESTION. 13 CONTRACTOR IS RESPONSIBLE TO PROVIDE A SMOOTH AND LEVEL TRANSITION BETWEEN DIFFERENT FLOOR FINISHES. CONTRACTOR TO PROVIDE TRANSITION STRIP BETWEEN ALL DISSIMILAR FLOORING MATERIALS. SEE SPECIFICATIONS FOR FLOORING TRANSITION STRIPS. 14 ALL NOTATIONS ARE INTENDED TO INDICATE FINISHES FOR ENTIRE AREA OF ITEM AND ALL EXPOSED SURFACES, INCLUDING WALL-TO-WALL, FLOOR-TO-CEILING, ENTIRE LENGTH OF SURFACE, ALL SIDES, ALL EDGES, AND ALL ASSOCIATED COMPONENTS, UNLESS OTHERWISE NOTED.</p>
	<p>THIS DRAWING SHEET IS INTENDED TO BE PLOTTED IN COLOR. IF THIS TEXT APPEARS IN BLACK AND WHITE, IT IS PLOTTED INCORRECTLY. DISCARD AND OBTAIN AN ACCURATE DRAWING</p>

MATERIAL SELECTION SCHEDULE											
ABBREV	ITEM	MANUFACTURER	PATTERN	COLOR	PRODUCT NO.	SIZE	SINGLE SOURCE	BASIS OF DESIGN	ADDITIONAL MANUFACTURERS	PERFORMANCE	REMARKS
ACP-1	ACOUSTIC CEILING PANEL	ARMSTRONG	ULTIMA	WHITE	1912	24" X 24" X 3/4"	X	--		9/16" SUSPENSION SYSTEM	
CG-1	CORNER GUARD									SEE SPECIFICATION SECTION 10 26 13	
CPTL-1	CARPET TILE									MATERIAL ALLOWANCE: \$30 SY. ALLOWANCE DOES NOT INCLUDE FREIGHT OR INSTALLATION	
DEF-1	DECORATIVE EPOXY FLAKE									SEE SPECIFICATION SECTION 09 67 16. FULL BROADCAST.	
EP-1	EPoxy Paint	SHERWIN WILLIAMS	--	PURE WHITE	SW7005	--	X			RESTROOM FIELD PAINT	
FRP-1	FIBER REINFORCED PLASTIC		TO BE SELECTED BY ARCHITECT	TO BE SELECTED BY ARCHITECT						SEE SPECIFICATION SECTION 10 2623.16. PROVIDE ALL TRIM AND ACCESSORIES REQUIRED FOR COMPLETE INSTALLATION.	
ICB-1	INTEGRAL COVE BASE					4" H				MATCH FLOOR	
NB	NO BASE									WALL FINISH EXTENDS TO THE FLOOR. NO SEPARATE WALL BASE REQUIRED.	
P-1	PAINT	SHERWIN WILLIAMS	--	PURE WHITE	SW7005	--	X	--		FIELD PAINT	
P-2	PAINT	SHERWIN WILLIAMS	--	NETWORK GRAY	SW7073	--	X			DOOR FRAME PAINT	
PL-1	PLASTIC LAMINATE	WILSONART	--		TO BE SELECTED BY ARCHITECT	--	--	X	FORMICA		
PT-1	PORCELAIN TILE									MATERIAL ALLOWANCE: \$4. ALLOWANCE DOES NOT INCLUDE FREIGHT, INSTALLATION, OR SETTING MATERIALS AND GROUT. LARGE SCALE 12" X 24" OR LARGER. INSTALL SCHLUTER TRIM AT TOP COURSE OF WALL TILE AND AT ALL OUTSIDE CORNERS. GROUT COLOR TO BE SELECTED BY ARCHITECT.	
RB-1	RUBBER BASE	TARKETT JOHNSONITE	DURA-COVE	PEPPERCORN	TB1	4" H				--	
SC-1	SEALED CONCRETE	SONNEBORN	KURE-N-SEAL	CLEAR						(1) ADDITIONAL COAT BEYOND THAT SPECIFIED. (SEE SPECIFICATION SECTION 03 3000) FOLLOWING CLEANING # PRIOR TO FINAL INSPECTION.	
SSM-1	SOLID SURFACE MATERIAL	CORIAN	--		TO BE SELECTED BY ARCHITECT					PRICE GRADE 2	

NOTES:

- 1 NO COMPARABLE PRODUCTS WILL BE REVIEWED FOR PRODUCTS DESIGNATED AS SINGLE SOURCE
- 2 COMPARABLE PRODUCTS WILL BE REVIEWED FOR ITEMS LISTED AS BASIS OF DESIGN. COMPARABLE PRODUCTS ARE REQUIRED TO MEET ANY MINIMUM PERFORMANCE REQUIREMENTS LISTED IN REMARKS AND DESIGN ATTRIBUTES OF SPECIFIED PRODUCT.
- 3 REFER TO TYPICAL DETAILS AND PRODUCT SPECIFICATION FOR ADDITIONAL TRIMS AND ACCESSORIES ASSOCIATED WITH SPECIFIED PRODUCTS ABOVE.

WINDOW TREATMENT SCHEDULE												
MARK	TYPE	OPERATION	MOUNTING	SHADECLOTH(S)	FINISHES	ACCESSORIES	REMARKS					
RS-1	SINGLE	MOTORIZED	HEAD TO SILL AND JAMB TO JAMB	BLACKOUT	TO BE SELECTED FROM MANUFACTURER'S FULL RANGE	FASCIA BEAD CHAIN RETENTION-CLIP	EXTEND BEAD CHAIN AS REQUIRED FOR ACCESS BY USER					
NOTES:												
1 REFER TO SPECIFICATION FOR MORE INFORMATION. 2 WINDOW TREATMENT TAGS SHOWN ON PLAN REPRESENTS A SINGLE SHADE. 3 REFER TO FLOOR PLANS, EXTERIOR ELEVATIONS AND FRAME TYPES FOR HEIGHT AND WIDTH OF OPENINGS. 4 WINDOW TREATMENTS ARE TO BE MOUNTED INSIDE OF THE WINDOW OPENING FROM HEAD TO SILL AND JAMB TO JAMB, UNLESS NOTED OTHERWISE. 5 VERIFY ALL DIMENSIONS IN FIELD PRIOR TO FABRICATION.												

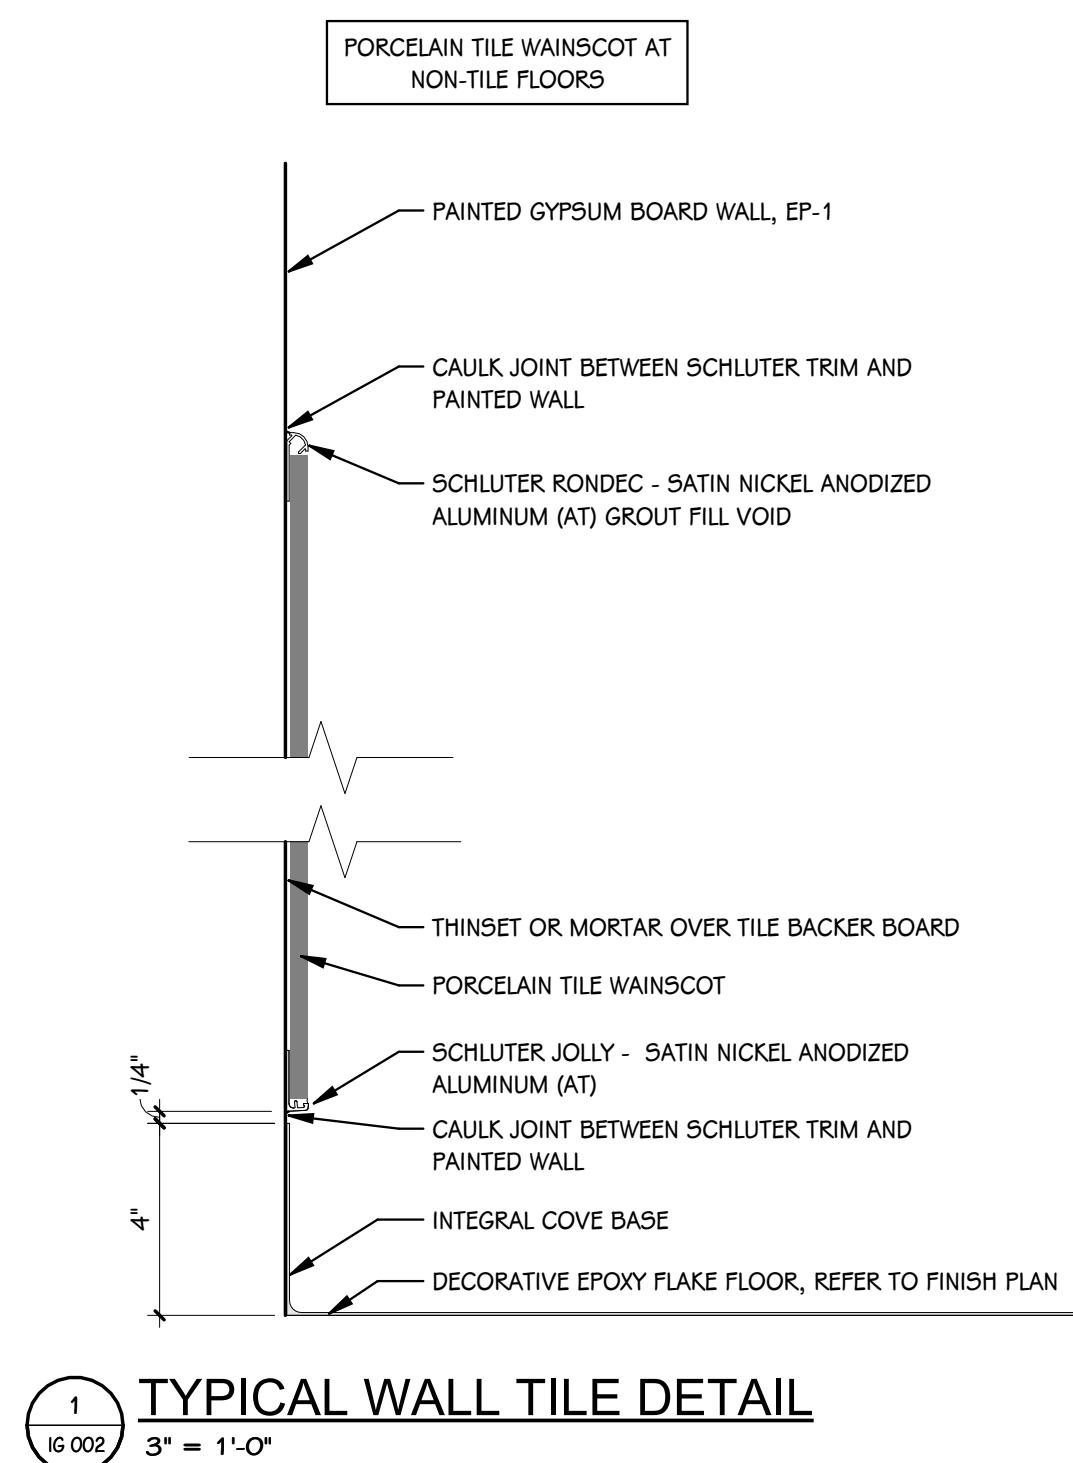

TYPICAL WALL TILE DETAIL

PROJECT TITLE	TEAMSTERS LOCAL 2727
OWNER	4810 N Preston Hwy Shepherdsville, KY
SHEET TITLE	MATERIAL SELECTION SCHEDULE & WINDOW TREATMENT SCHEDULE
SHEET NUMBER	IG 002
DATE	JANUARY 9, 2026
25-376.000	


PROJECT TITLE
TEAMSTERS LOCAL 2727
BUILDING ADDITION

OWNER
TEAMSTERS LOCAL 2727
4810 N Preston Hwy
Shepherdsville, KY


SHEET TITLE
FINISH PLAN - ADDITION
KEY PLAN
SHEET NUMBER
101
25-376.000

DATE
JANUARY 9, 2026

NOTES - FINISH PLANS
1 FINISH TAGS APPLY TO LIKE MATERIALS IN ENTIRE ROOM. I.E. CASEWORK TAG MAY ONLY CALLOUT ONE RUN OF CASEWORK, BUT ALL CASEWORK IN ROOM RECEIVE THE SAME FINISHES, UNLESS TAGGED DIFFERENTLY.
2 WHERE NO FINISH TAG IS SHOWN ALL EXISTING FINISHES ARE TO REMAIN, UNLESS OTHERWISE NOTED.

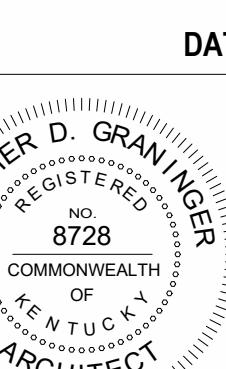


Heather D. Graninger
#728
REGISTERED
ARCHITECT

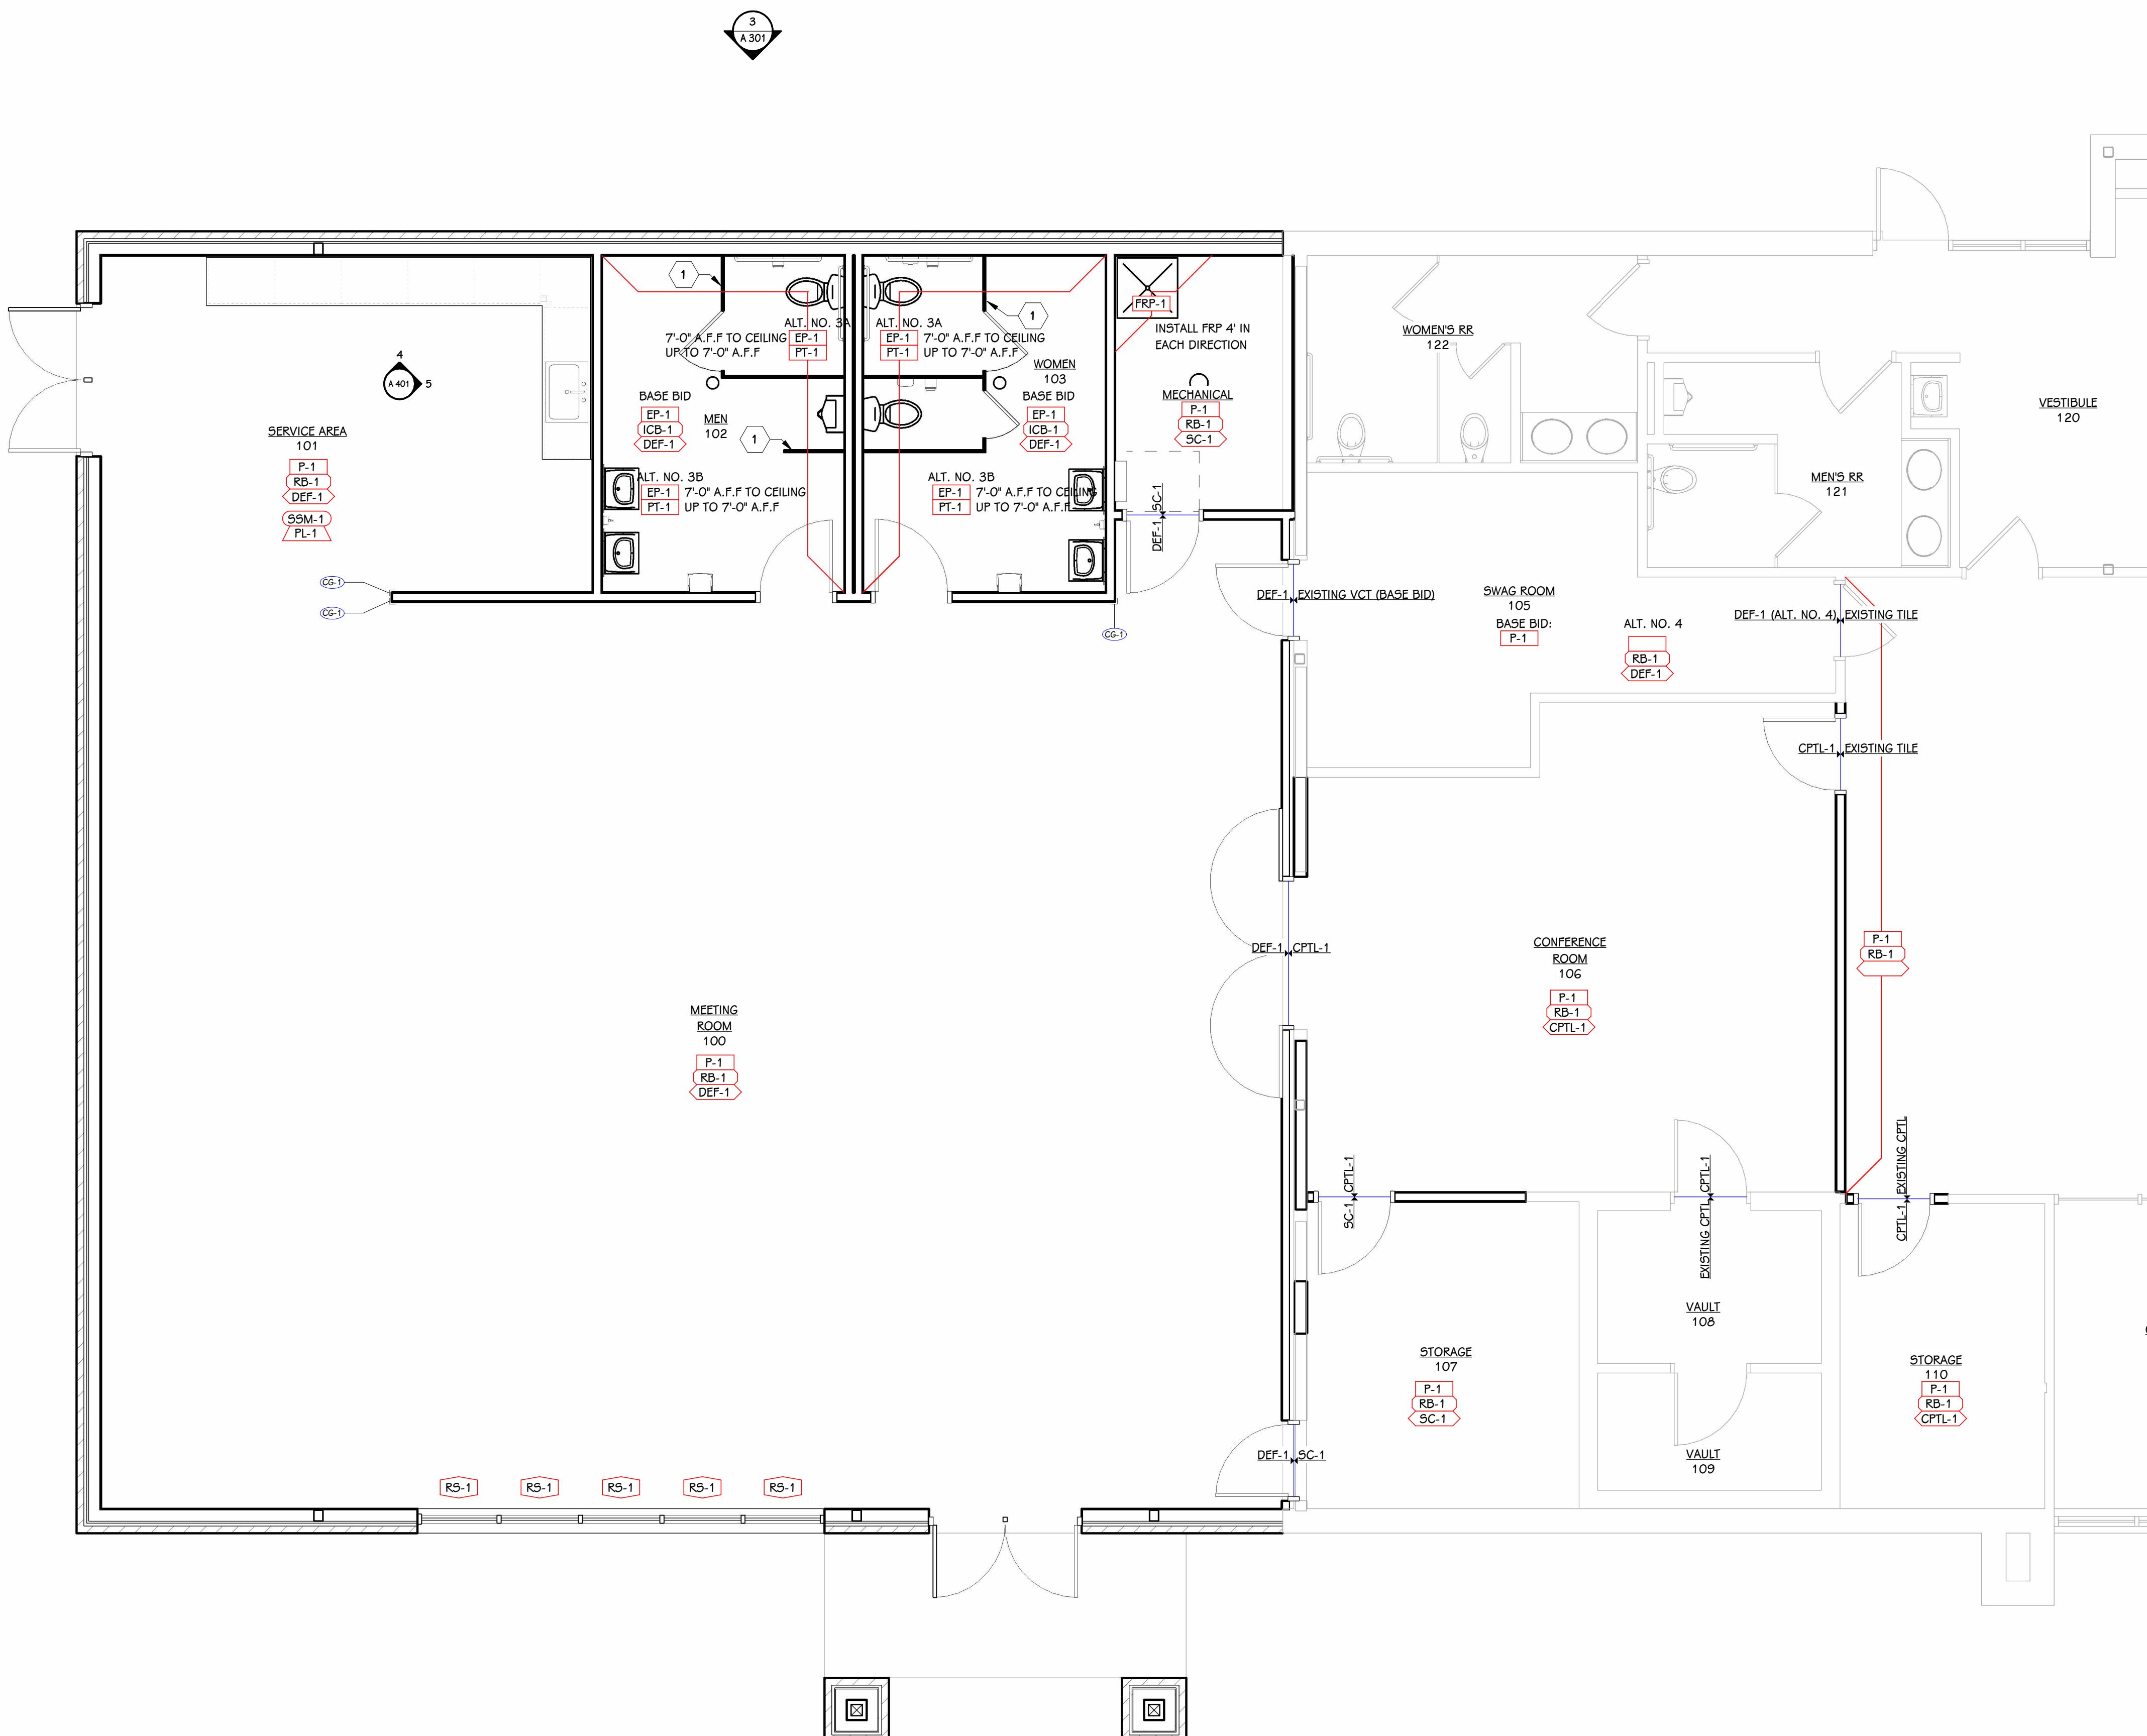


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TEAMSTERS LOCAL 2727

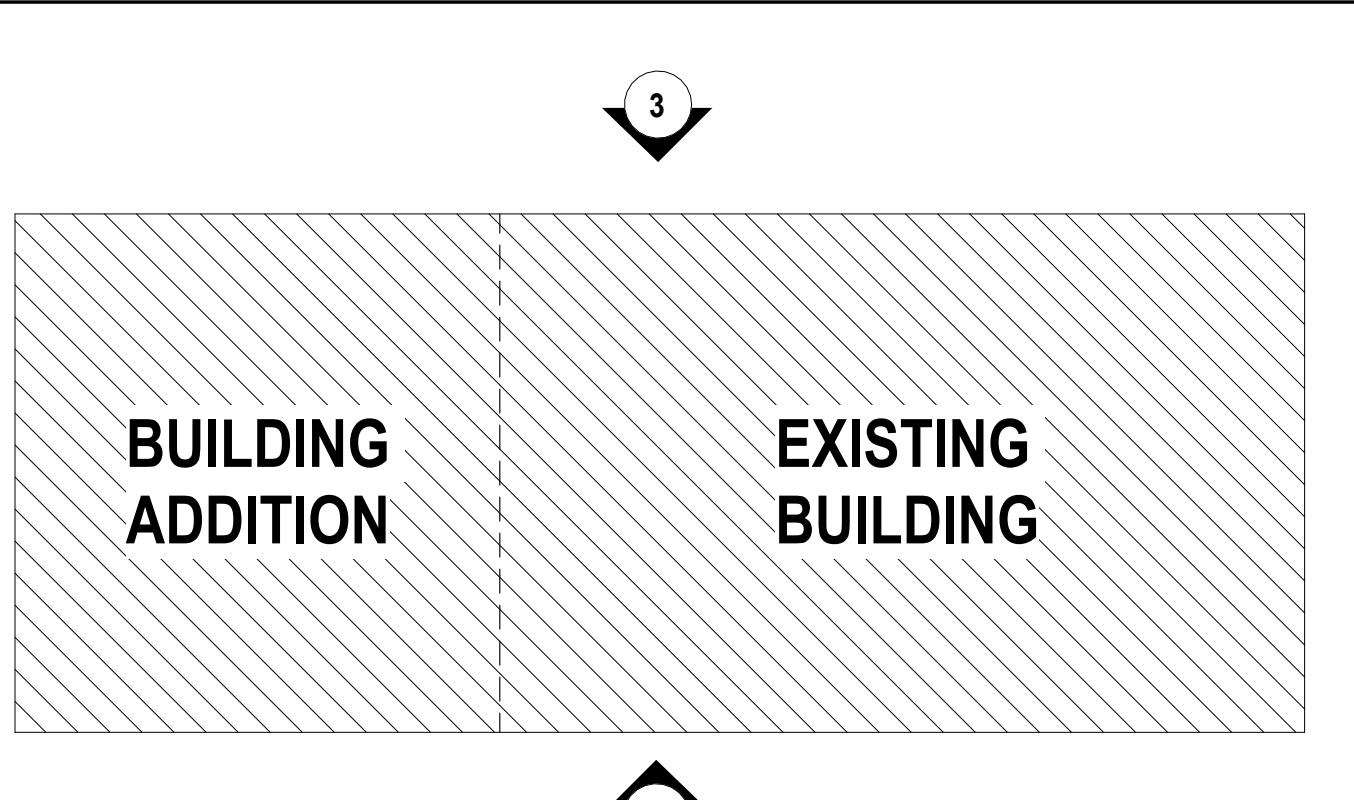

KEY PLAN

FINISH PLAN - ADDITION
1/4" = 1'-0"

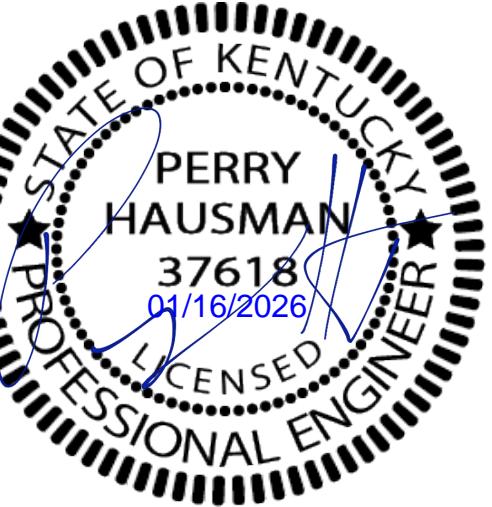

ISSUED FOR DATE

PROJECT TITLE
TEAMSTERS LOCAL 2727 Building Addition

OWNER
TEAMSTERS LOCAL 2727


4810 N Preston Hwy
Sheppardsville, KY

DATE
JANUARY 16, 2026


SHEET NUMBER
MG 001

25-376.000

ABBREVIATIONS		MECHANICAL SYMBOLS		GENERAL NOTES - MECHANICAL - NEW CONSTRUCTION	
A.C.D.	AUTOMATIC CONTROL DAMPER	— AW	ACID WASTE	1	DETAILS SHOWN ILLUSTRATE DESIGN INTENT, NOT ALL POSSIBLE CONDITIONS. DRAWINGS ARE NOT TO BE CONSIDERED FABRICATION DRAWINGS.
A.F.F.	ABOVE FLOOR FRESH AIR	— AWV	ACID WASTE VENT	2	IF THE CONTRACTOR ELECTS TO PROVIDE EQUIPMENT OTHER THAN BASIS OF DESIGN, THE CONTRACTOR SHALL BE RESPONSIBLE TO COORDINATE THE LAYOUT AND CLEARANCE REQUIREMENTS IN ALL SPACES CONTAINING EQUIPMENT AND PROVIDE EQUIPMENT MEETING THE SPECIFICATIONS AND ACHIEVING CODE REQUIRED CLEARANCES WITHIN THE SPACE PROVIDED. CONTRACTOR IS REQUIRED TO COVER ALL ELECTRICAL COSTS FOR OTHER BASIS OF DESIGN PRODUCTS SUCH AS DIFFERENT VOLTAGE OR DIFFERENT SIZE MOTOR.
A.G.	AIR GROUT	— BVL	BALANCING VALVE	3	COORDINATE ALL NEW CONSTRUCTION WORK OR ACTIVITY WITH THAT WHICH IS REQUIRED BY OTHER TRADES OR INSTALLERS IN ORDER TO PROVIDE A COMPLETE SYSTEM INCLUDING ALL NECESSARY COMPONENTS, FITTINGS, AND OFFSETS.
A.P.D.	AIR PRESSURE DROP	— CBV	CALIBRATED BALANCING VALVE	4	INSTALLER SHALL VERIFY ALL EXISTING JOBSITE CONDITIONS AND DIMENSIONS AND BE RESPONSIBLE FOR THE SAME. NOTIFY THE ENGINEER OF DISCREPANCIES PRIOR TO COMMENCING WORK.
B.D.	BALANCING DAMPER	— C	CAP	5	FIRE SEAL ALL PENETRATIONS, SUCH AS PIPES, DUCTS, CONDUIT, ETC. THROUGH FIRE AND/OR SMOKE RATED ASSEMBLIES.
B.D.D.	BACKDRAFT DAMPER	— C2	CARBON DIOXIDE	6	MECHANICAL INSTALLER IS RESPONSIBLE FOR PATCHING OF WALLS, CEILINGS, AND FLOORS WHERE FIXTURES, MECHANICAL EQUIPMENT, SHEET METAL, OR PIPING HAS BEEN REMOVED, RELOCATED, OR INSTALLED.
B.T.U.	BTU	— C.V.	CHECK VALVE	7	ALL PIPING AND DUCTWORK SHALL AVOID LOCATIONS DIRECTLY ABOVE ALL ELECTRICAL EQUIPMENT. COORDINATE WITH ELECTRICAL.
B.T.U.H.	BRITISH THERMAL UNIT PER HOUR	— CR	CHILLER RETURN	8	ALL LOW VOLTAGE CABLEING SHALL BE RUN IN CONDUIT BETWEEN DEVICE AND CABLE TRAY OR TECHNOLOGY RACE. NO CABLEING SHALL BE VISIBLE IN EXPOSED CEILING SPACES AND SHALL BE ROUTED IN CONDUIT THAT IS PAINTED TO MATCH SURFACE IT IS SUPPORTED FROM. CABLEING THAT IS ROUTED ABOVE AN ACCESSIBLE CEILING SPACE CAN BE INDEPENDENTLY SUPPORTED WITH COMM HOOKS OR RINGS.
B.V.	BALANCING VALVE	— CS	CHILLER SUPPLY	9	COORDINATE ALL TEMPERATURE SENSOR LOCATIONS WITH "ELECTRICAL DEVICES ALIGNMENT GUIDELINES" DETAIL ON SHEET GO03.
C.B.	CATCH BASIN	— CWR	CHILLED WATER RETURN	10	ALL SPACE PERMITS, ALL HYDRONIC BRANCH PIPING SHALL TAP OFF OF BOTTOM OR SIDE OF PIPING MAINS PER BRANCH PIPING TAKE-OFF PIPING DETAIL THIS SHEET. MANUAL AIR VENTS SHALL BE INSTALLED AT THE TOP OF ALL HYDRONIC SYSTEMS.
C.C.W.	CLOSED COLD WATER BALANCING VALVE	— CWS	CHILLED WATER SUPPLY	11	ALL EXISTING CLOSED SYSTEMS SHALL BE ISOLATED AND FLUSHED/CLEANED PRIOR TO CONNECTION TO NEW SYSTEMS.
C.F.H.	CUBIC FEET PER HOUR	— CWT	COLD WATER (DOMESTIC)	12	ALL BRANCH PIPING SHALL BE FURNISHED WITH SHUT-OFF VALVES IN AN ACCESSIBLE LOCATION NEAR MAIN CONNECTION.
C.H.	CABINET HEATER	— A	COMPRESSED AIR	13	NEW EQUIPMENT IS NOT PERMITTED TO BE USED FOR TEMPORARY HEAT WITHOUT THE OWNER'S WRITTEN APPROVAL.
C.I.	Ceiling	— COND	CONDENSATE	14	THE CONTRACTOR IS RESPONSIBLE FOR PROTECTING NEW AND EXISTING EQUIPMENT FROM DAMAGE.
C.M.	CEILING MOUNTED	— CD	CONDENSATE DRAIN		
C.O.	CLEAN OUT	— CTR	CONTROL VALVE		
C.V.	CONTROL VALVE	— CTW	CLOUDING TOWER RETURN		
C.W.	COLD WATER (DOMESTIC)	— CSW	CLOUDING TOWER SUPPLY		
D.F.	DRINKING FOUNTAIN	— DI	DEIONIZED WATER		
D.N.	DOWN	— DPH	FIRE DAMPER (HORIZONTAL)		
D.S.	DOWN SPOUT	— DPV	FIRE DAMPER (VERTICAL)		
E.A.T.	ENTERING AIR	— FP	FIREPROOF DAMPER		
E.D.B.	ENTERING DRY BULB	— FMT	FLOW METER (PROBE TYPE)		
E.F.	EXHAUST FAN	— FMTW	FLOW METER (WATER TYPE)		
E.G.P.	EXHAUST STATIC PRESSURE	— FS	FLOW SWITCH		
E.W.B.	ENTERING WET BULB	— FD	FOOTING DRAIN		
E.W.C.	ELECTRIC WATER COOLER	— FOR	FUEL OIL RETURN		
E.W.T.	ENTERING WATER TEMPERATURE	— FOS	FUEL OIL SUPPLY		
E.D.P.	EXISTING DRY BULB	— G	GAS		
E.T.R.	EXISTING TO REMAIN	— GLR	GROUND LOOP WATER RETURN		
F.C.	FLEXIBLE CONNECTION	— GLS	GROUND LOOP WATER SUPPLY		
F.D.	FLOOR DRAIN	— HK	HEATING HOT WATER RETURN		
F.H.	FIRE HOSE CABINET	— HWS	HEATING HOT WATER SUPPLY		
F.I.	FIELD INSTALLED	— HPR	HEAT PUMP RETURN		
F.M.	FLOOR MOUNTED	— HPS	HEAT PUMP SUPPLY		
F.P.M.	FIRE PROOF MOUNT	— HWR	HOT WATER RETURN (DOMESTIC)		
F.R.	FIN RADIATION	— HWS	HOT WATER SUPPLY (DOMESTIC)		
G.P.M.	GALLONS PER MINUTE	— O	HUMIDISTAT		
H.B.	HOSE BIBB	— MA	MEDICAL AIR		
H.H.	HIGH HEAT EXCHANGER	— MMVAC	MEDICAL VACUUM		
H.W.	HOT WATER SUPPLY (DOMESTIC)	— N	NITROGEN		
H.W.R.	HOT WATER RETURN (DOMESTIC)	— N2O	NITROUS OXIDE		
I.E.	INVERT ELEVATION	— OS	OUTSIDE STEM AND YOKE VALVE		
I.L.	INLET LINE TEMPERATURE	— O2	OXYGEN		
L.A.V.	LAVATORY	— PG	PRESSURE GAUGE		
L.D.B.	LEAVING DRY BULB	— PRV	PRESSURE RELIEF VALVE		
LOUV.	LOUVER	— PT	PRESSURE / TEMPERATURE TAPPING		
L.W.B.	LEAVING WET BULb	— PRVTR	PRESSURE RELIEF VALVE		
L.W.T.	LEAVING WATER TEMPERATURE	— PHS	PRIMARY HEATING HOT WATER RETURN		
M.A.	MIXED AIR	— PHS	PRIMARY HEATING HOT WATER SUPPLY		
M.A.T.	MIXED AIR TEMPERATURE	— PC	PUMPED CONDENSATE		
M.A.V.	MIXED AIR VENT	— RPPD	REDUCED PRESSURE PRINCIPLE BACKFLOW PREVENTER		
N.C.	NORMALLY CLOSED	— RL	REFRIGERANT LINE (LIQUID)		
N.F.W.H.	NON-FREEZE WALL HYDRANT	— RS	REFRIGERANT LINE (SUCTION)		
N.I.C.	NOT IN CONTRACT	— SAN	SANITARY SEWER (ABOVE FLOOR)		
N.O.	NOT OPEN	— SAN-	SANITARY SEWER (BELOW FLOOR)		
O.A.I.	OUTSIDE AIR	— SHV	SHUT-OFF VALVE		
O.A.I.	OUTSIDE AIR INTAKE	— SD	SMOKE DAMPER		
OCT.	OCTAVE	— SCW	SOFT COLD WATER		
P.A.	PARTICLE AIR	— SCV	SPRING CHECK VALVE		
P.D.	PRESSURE DROP	— STM (I)	STEAM		
P.I.V.	POST INDICATOR VALVE	— STM	STEAM TRAP		
P.R.V.	PRESSURE REDUCING VALVE	— ST	STORM SEWER (ABOVE FLOOR)		
P.T.T.	PRIMARY TEMPERATURE TAPPING	— ST (OF)	STORM SEWER (OVERFLOW SYSTEM)		
R.A.	RETURN AIR	— ST	STORM (BELOW FLOOR)		
R.D.	ROOF DRAIN	— STR	STRAINER		
R.H.	RELATIVE HUMIDITY	— SMR	SNOWMELT RETURN		
R.H.	RELATIVE HUMIDITY	— SMS	SNOWMELT SUPPLY		
R.P.M.	REVOLUTIONS PER MINUTE	— TS	TEMPERATURE SENSOR		
R.P.P.D.	REDUCED PRESSURE PRINCIPAL BACKFLOW PREVENTER	— CO2	TEMPERATURE SENSOR		
R.V.	REFRIGERATION VALVE	— DP	DIFFERENTIAL PRESSURE SENSOR		
S.A.	SUPPLY AIR	— AS	AIRFLOW SENSOR		
S.C.W.	SOFT COLD WATER (DOMESTIC)	— MS	MOISTURE SENSOR		
SENS.	SENSIBLE	— DS	DUCT SMOKE SENSOR		
S.H.R.	SUPERHEATER				
S.H.	SINK				
S.O.V.	SHUT-OFF VALVE				
S.P.	STATIC PRESSURE				
S.S.	SINK				
S.T.M.P.	STATIC TEMPERATURE				
TOT.	TOTAL				
T.T.R.	TEMPERATURE RISE				
T.T.D.	TEMPERATURE DROP				
T.S.P.	TOTAL STATIC PRESSURE				
T.U.	TERMINAL UNIT BOX				
T.W.C.	TEPID WATER CONNECTION				
U.H.	UNDER HEATER				
U.R.H.	UNDER HEAT				
V.	VENT				
VEL.	VELOCITY				
V.I.	VENT ISOLATORS				
V.I.F.	VERIFY IN FIELD				
V.S.	VENT STACK				
V.T.R.	VENT THRU ROOF				
W.C.	WATER CLOSET				
W.M.	WALL MOUNTED				
W.P.D.	WATER PRESSURE DROP				
W.S.K.	WASH SINK				
CONTROL SYMBOLS					
— C	CONTROL VALVE				
— FMT	FLOW METER (PROBE TYPE)				
— FMTW	FLOW METER (WATER TYPE)				
— FV	THREE-WAY CONTROL VALVE				
— HS	HUMIDITY SENSOR				
— TS	TEMPERATURE SENSOR				
— CO2	CARBON DIOXIDE SENSOR				
— DP	DIFFERENTIAL PRESSURE SENSOR				
— AS	AIRFLOW SENSOR				
— MS	MOISTURE SENSOR				
— DS	DUCT SMOKE SENSOR				
DUCTWORK COLOR LEGEND					
— LOWER PRESSURE SUPPLY AIR	— EXHAUST AIR	— RETURN AIR			
— MEDIUM PRESSURE SUPPLY AIR	— OUTSIDE AIR				
NOTE: NOT ALL SYMBOLS AND ABBREVIATIONS ARE APPLICABLE TO THE SCOPE OF WORK INDICATED ON SUBSEQUENT DRAWINGS. CONTRACTOR SHALL DETERMINE WHICH SYMBOLS AND ABBREVIATIONS ARE APPLICABLE TO THE SPECIFIC SCOPE OF WORK UPON REVIEWING THE PROJECT DRAWINGS AND SPECIFICATIONS.					
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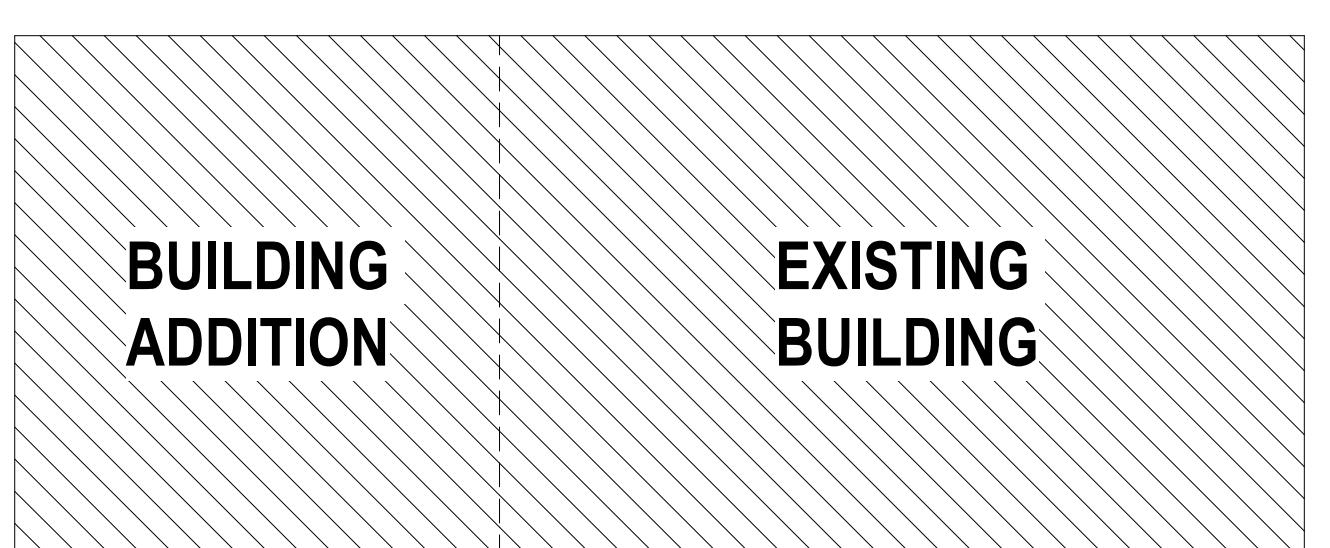
PLUMBING RISER DIAGRAM
P 001

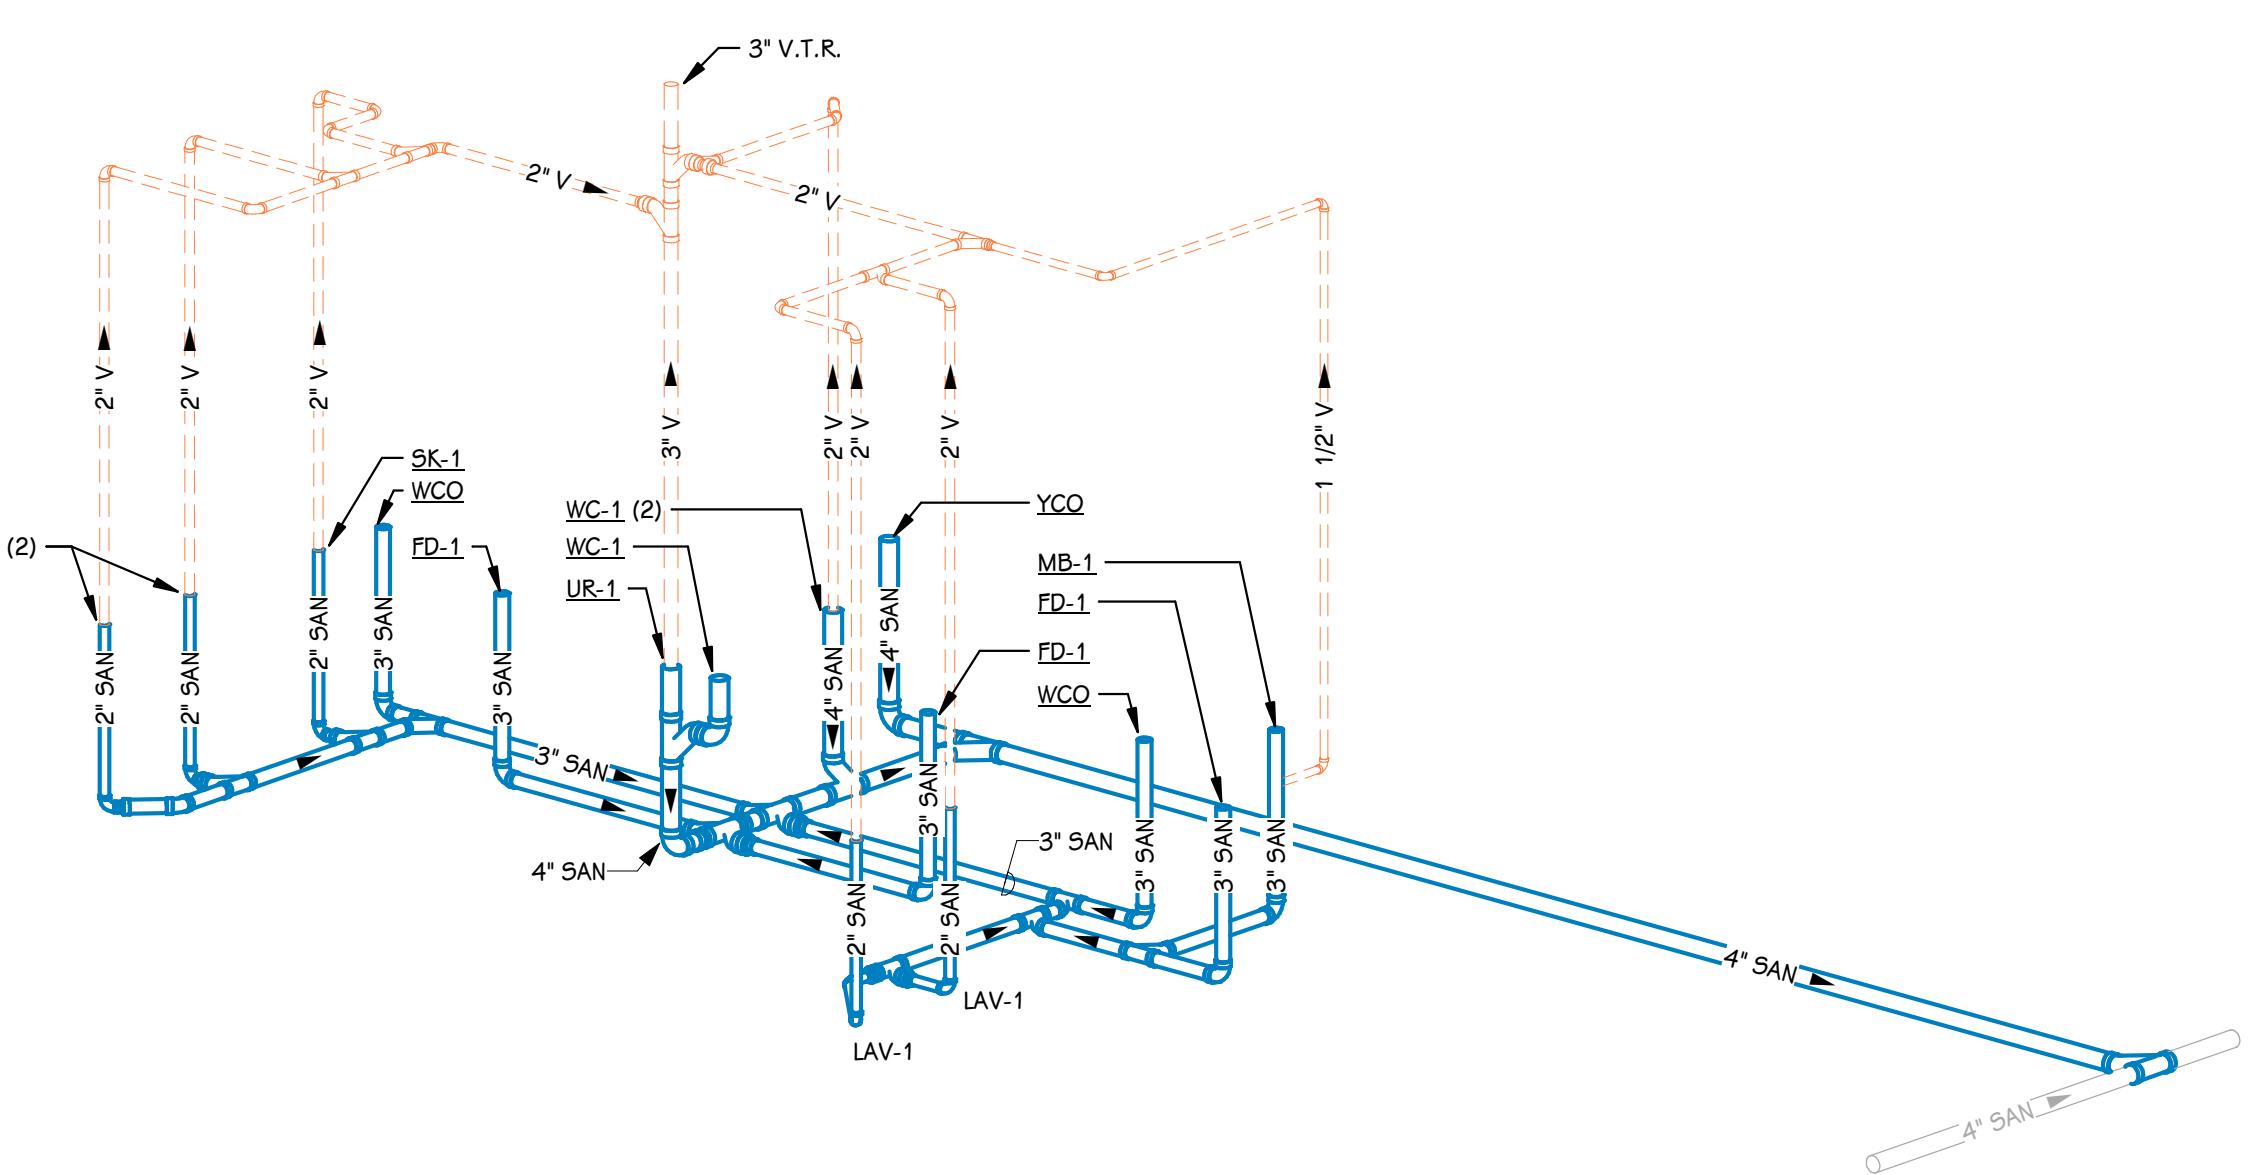

OVERALL FOUNDATION PLUMBING PLAN
1/8" = 1'-0"
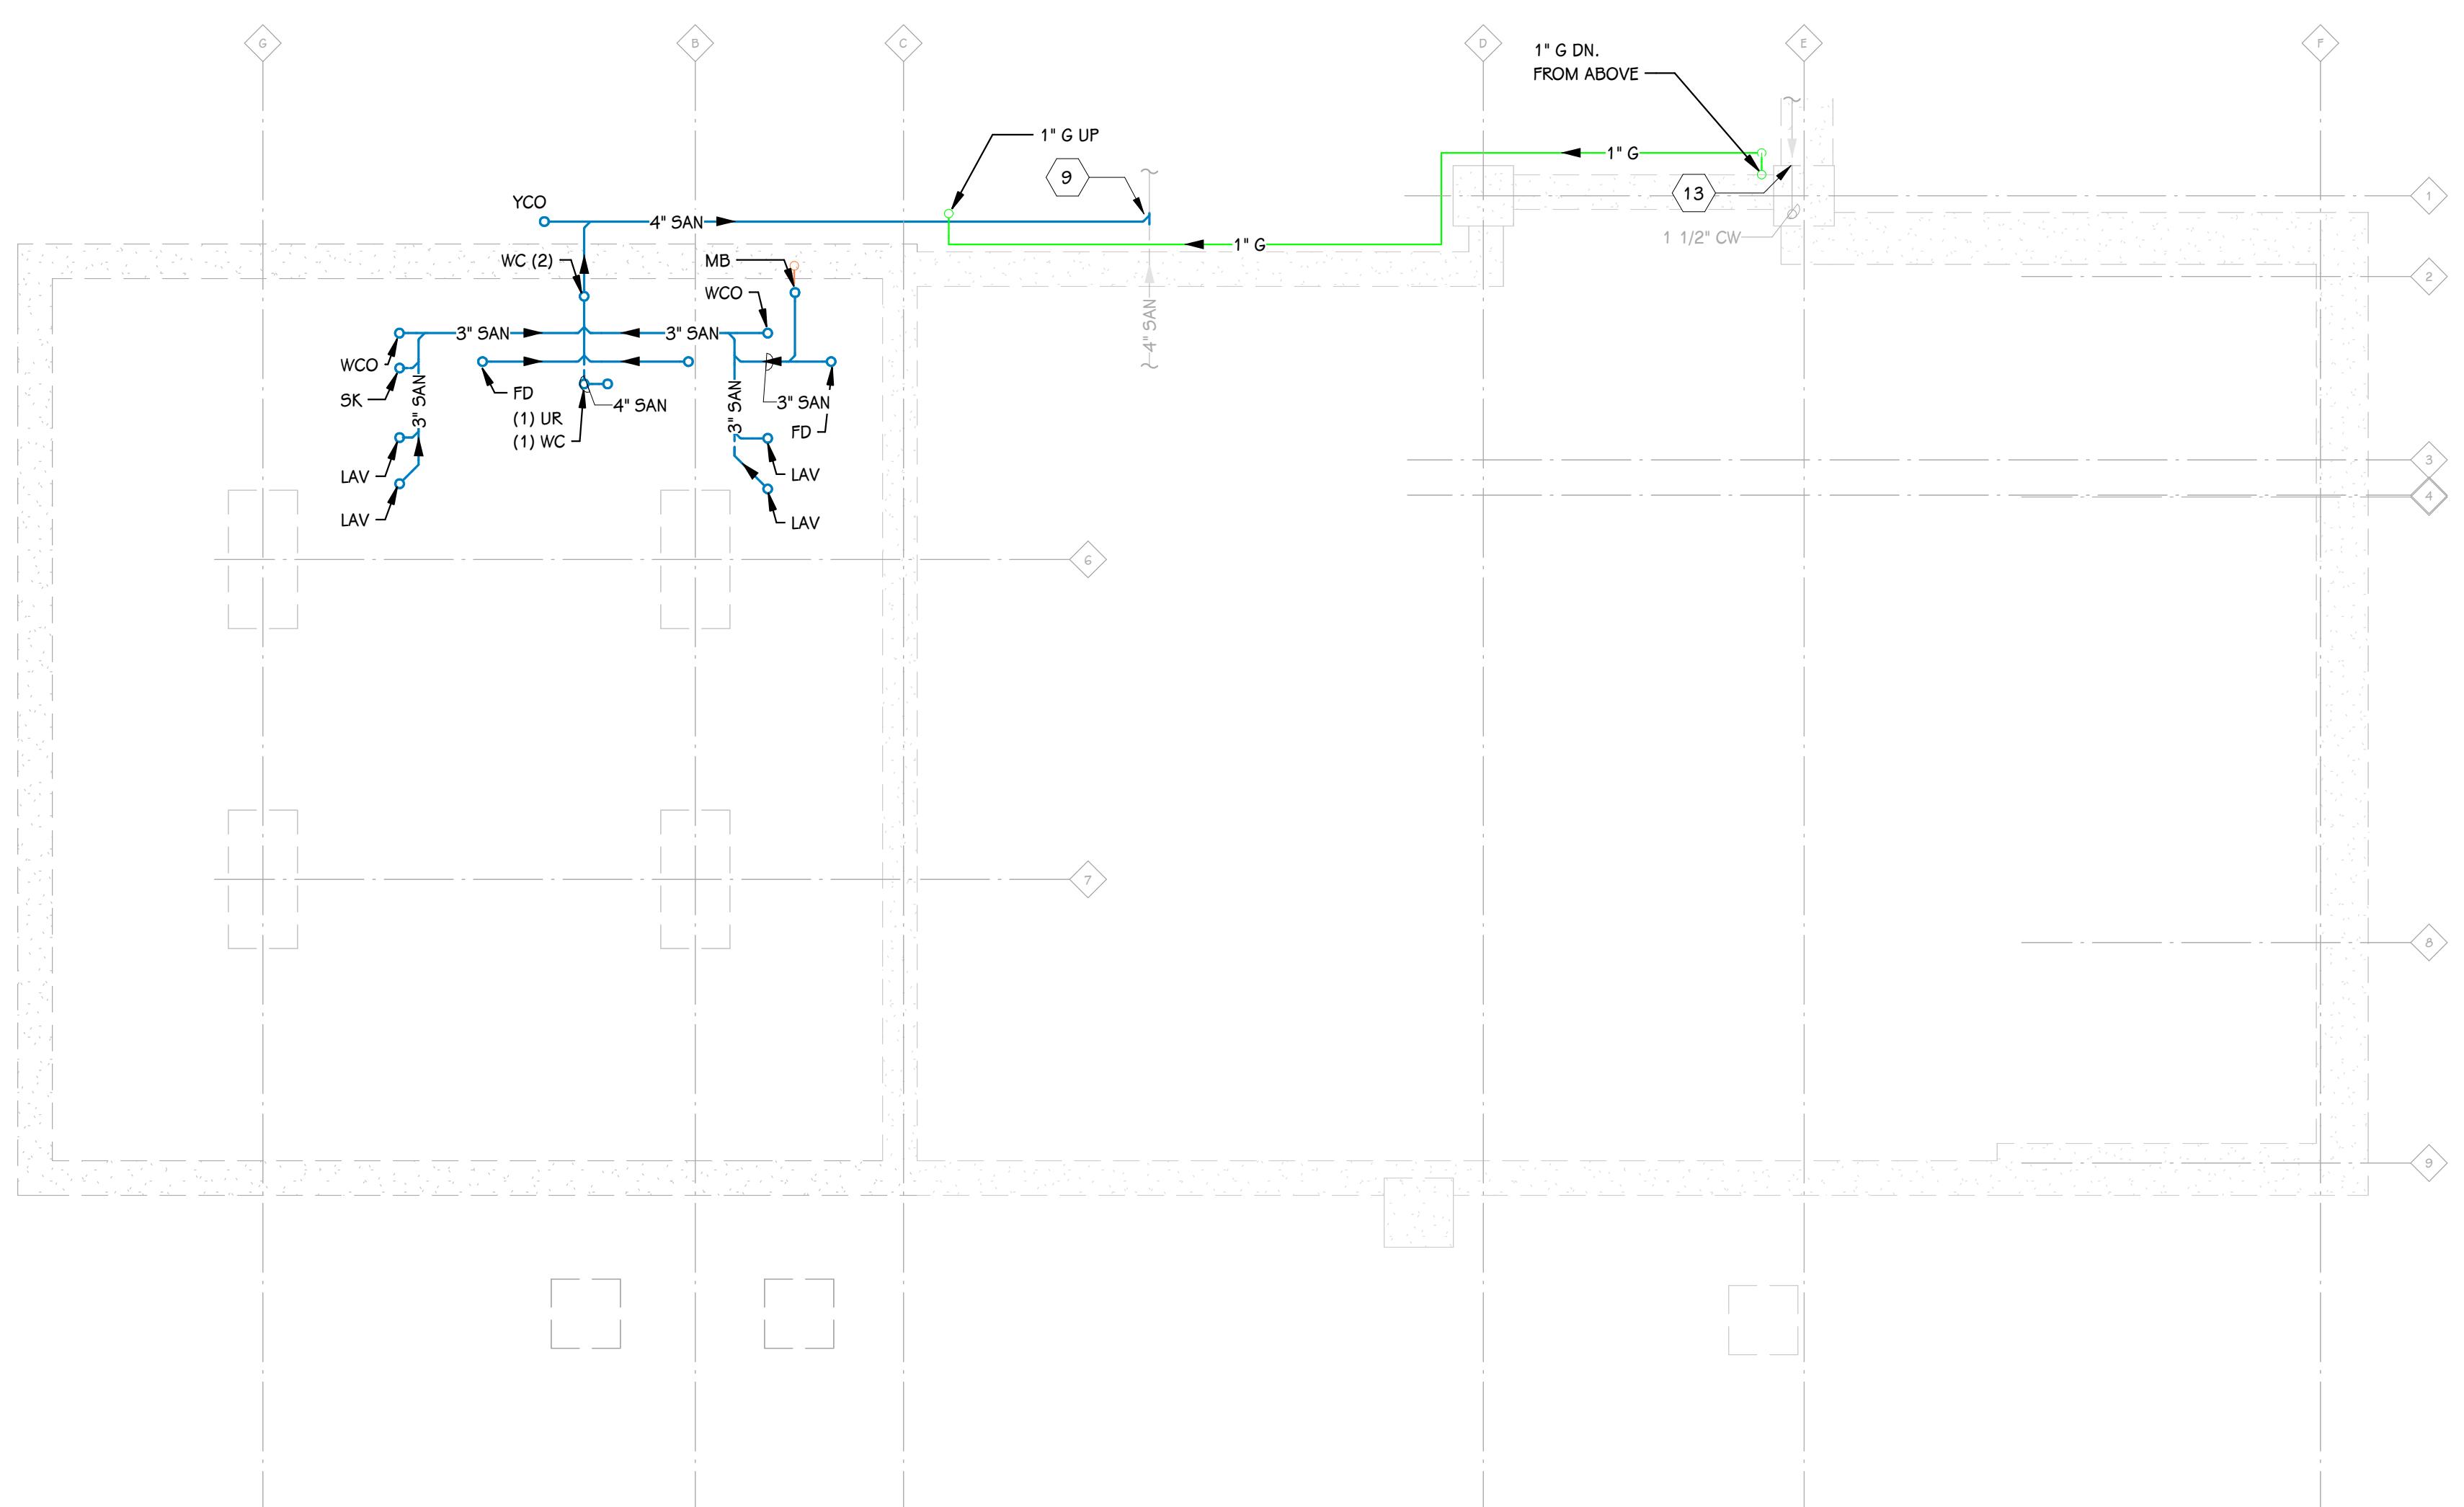
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TEAMSTERS LOCAL 2727



KEY PLAN

PROJECT TITLE
TEAMSTERS LOCAL 2727 Building Addition

OWNER
TEAMSTERS LOCAL 2727


ADDRESS
4810 N Preston Hwy
Sheppardsville, KY

SHEET NUMBER
P 001
25-376.000


DATE
JANUARY 16, 2026

KEYED NOTES - PLUMBING - DOMESTIC

- WC: 1 1/4" CW, 4" SAN, 2" V.
- UR: 3/4" CW, 2" SAN, 2" V.
- LAV OR SK: 1/2" CW, 1/2" HW, 2" SAN, 1 1/2" V.
- PROVIDE 1/2" CW (RAW) TO SK-1, PROVIDE 1/2" CW BRANCH UNDER SINK AND ROUTE TO WATER FILTER MOUNTED IN BASE CABINET. ROUTE 1/2" FILTERED WATER FROM FILTER TO ICE MAKER BY OTHERS. PROVIDE INLINE WATER FILTER IN ACCORDANCE WITH NSPI/ANSI 42 & 53.
- REFER TO OVERALL PLUMBING PLAN FOR CONTINUATION.
- 3" SAN DN. FROM FLOOR DRAIN.
- REFER TO SHEET METAL PLAN.
- MB: 3/4" HW, 3/4" CW, 3" SAN, 1 1/2" VENT.
- CONNECT TO EXISTING SANITARY. VERIFY INVERT IN FIELD.
- PROVIDE 3" V.T.R. PAINT TO MATCH ROOF.
- CONNECT TO EXISTING.
- CONTRACTOR TO FIELD VERIFY EXISTING LINE SIZE AND NOTIFY ENGINEER OF ANY DISCREPANCY.

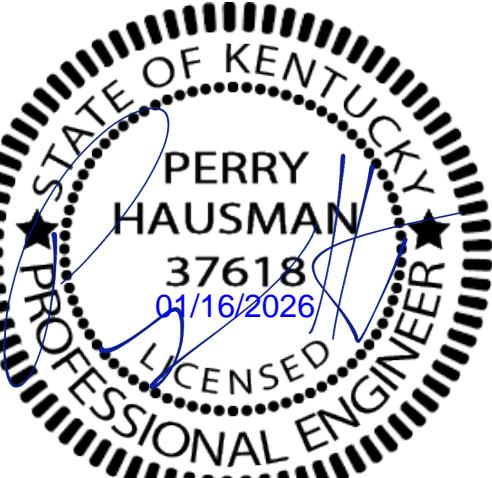

ISSUED FOR DATE

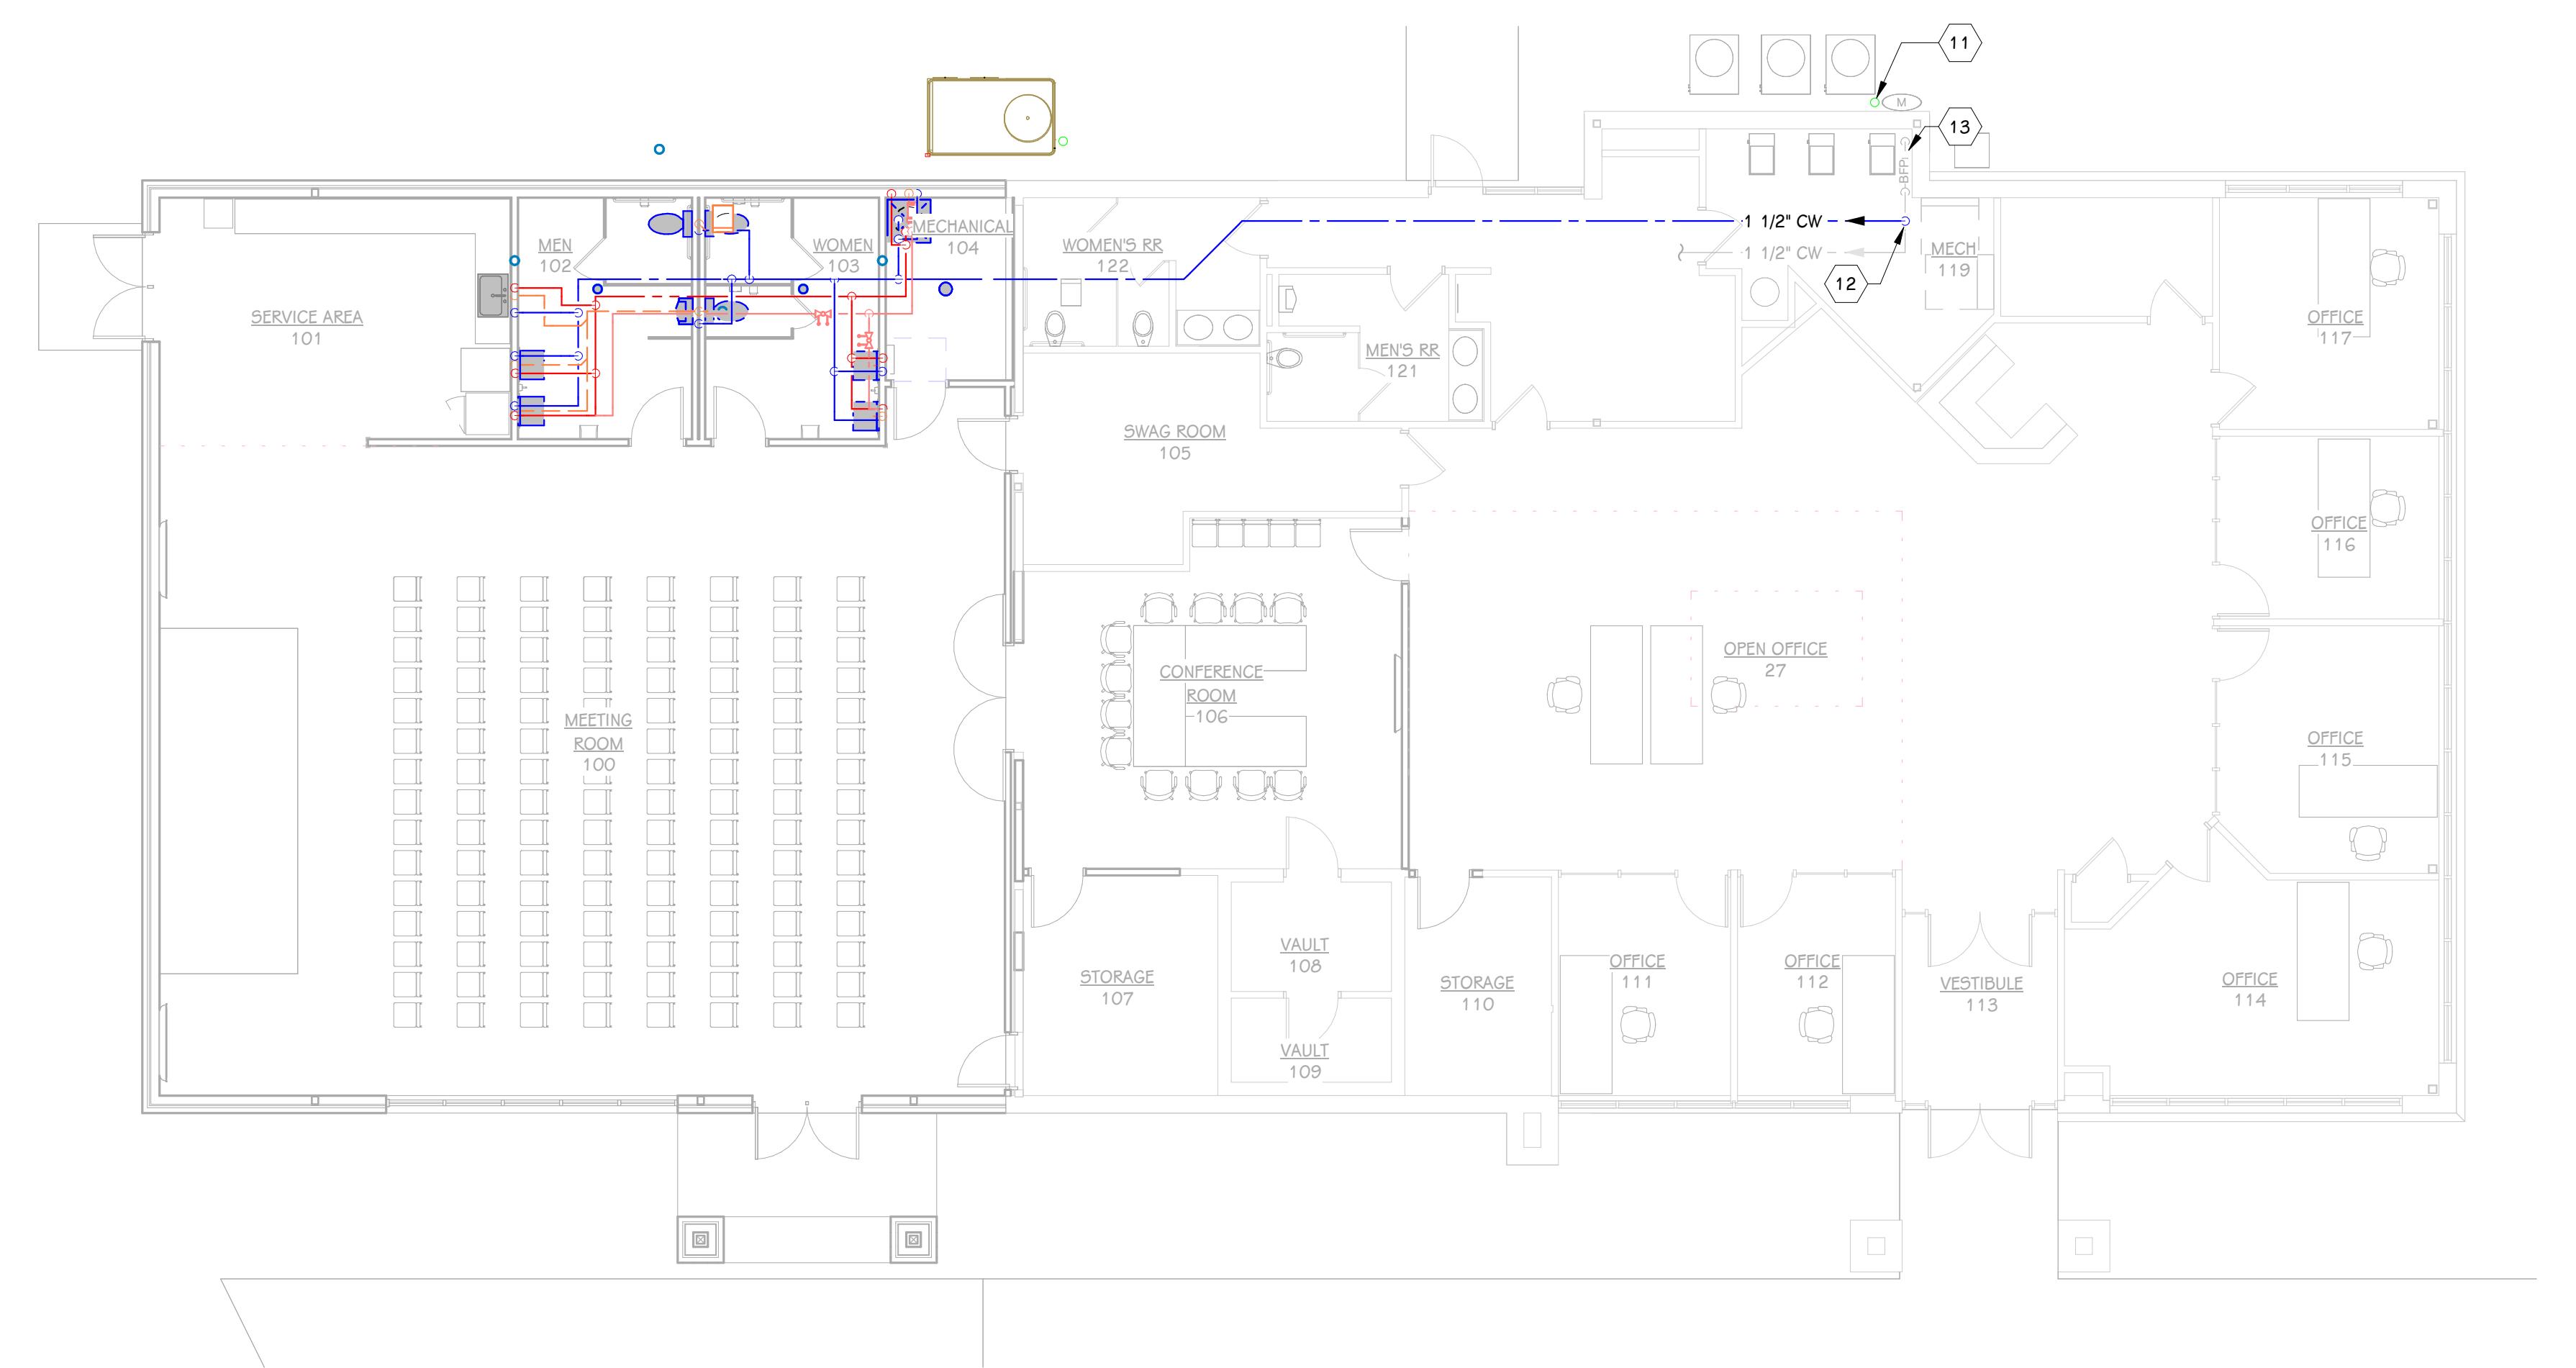


OVERALL FIRST FLOOR PLUMBING PLAN

1/8" = 1'-0"

THIS DRAWING SHEET IS INTENDED TO BE PLOTTED IN COLOR. IF THIS TEXT APPEARS IN BLACK AND WHITE, IT IS PLOTTED INCORRECTLY. DISCARD AND OBTAIN AN ACCURATE DRAWING

TEAMSTERS LOCAL 2727

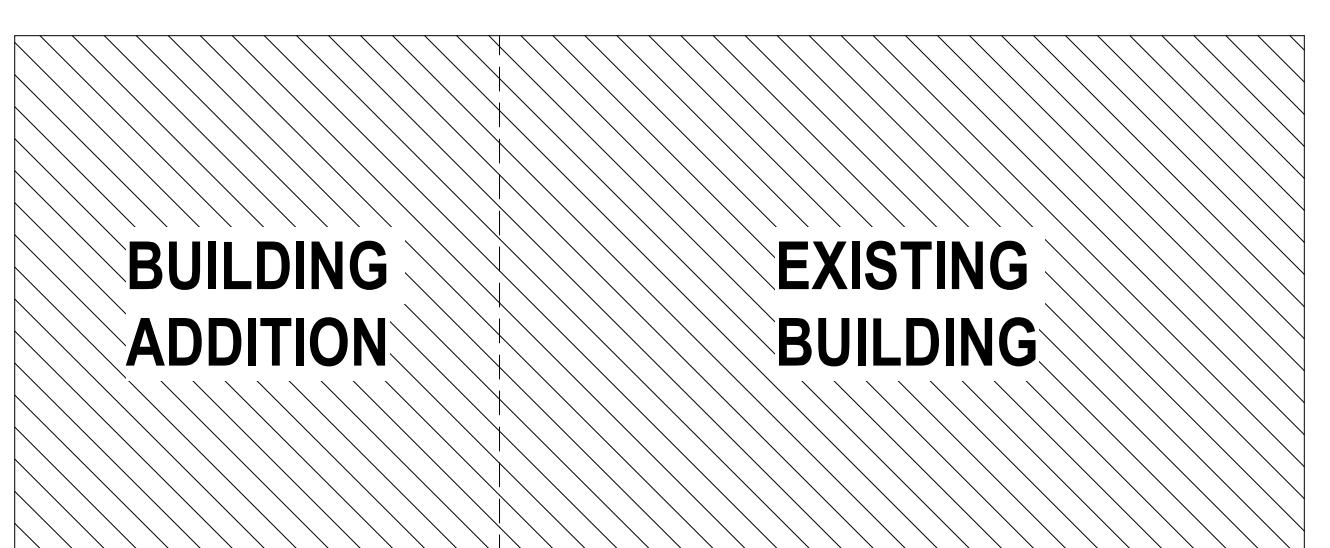

KEY PLAN

PROJECT TITLE
TEAMSTERS LOCAL 2727 Building Addition

OWNER
TEAMSTERS LOCAL 2727

4810 N Preston Hwy
Sheppardsville, KY

SHEET TITLE
OVERALL FIRST FLOOR PLUMBING PLAN

DATE
JANUARY 16, 2026


SHEET NUMBER
P 100
25-376.000

KEYED NOTES - PLUMBING - DOMESTIC	
1	WC: 1 1/4" CW, 4" SAN, 2" V.
2	UR: 3/4" CW, 2" SAN, 1 1/2" V.
3	LAV OR SK: 1/2" CW, 1/2" HW, 2" SAN, 2" V, 3" SAN BELOW SLAB.
4	PROVIDE 1/2" CW (RAW TO SK-1, PROVIDE 1/2" CW BRANCH UNDER SINK AND ROUTE TO WATER FILTER MOUNTED IN BASE CABINET. ROUTE 1/2" FILTERED WATER FROM FILTER TO ICE MAKER BY OTHERS. PROVIDE INLINE WATER FILTER IN ACCORDANCE WITH NSF/ANSI 42 & 53.
5	REFER TO OVERALL PLUMBING PLAN FOR CONTINUATION.
6	3" SAN DN. FROM FLOOR DRAIN.
7	REFER TO SHEET METAL PLAN.
8	MB: 3/4" HW, 3/4" CW, 3" SAN, 1 1/2" VENT.
9	CONNECT TO EXISTING SANITARY. VERIFY INVERT IN FIELD.
10	PROVIDE 3" V.T.R. PAINT TO MATCH ROOF.
11	CONNECT TO EXISTING GAS PIPING. REFER TO DETAIL ON P 501. ROUTE BELOW GRADE TO NEW GRADE MOUNTED RTU. REFER TO SPECIFICATION FOR BELOW GRADE GAS PIPING.
12	CONNECT TO EXISTING.
13	CONTRACTOR TO FIELD VERIFY EXISTING LINE SIZE AND NOTIFY ENGINEER OF ANY DISCREPANCY.

ISSUED FOR DATE

PERRY HAUSMAN
37618
1/19/2026



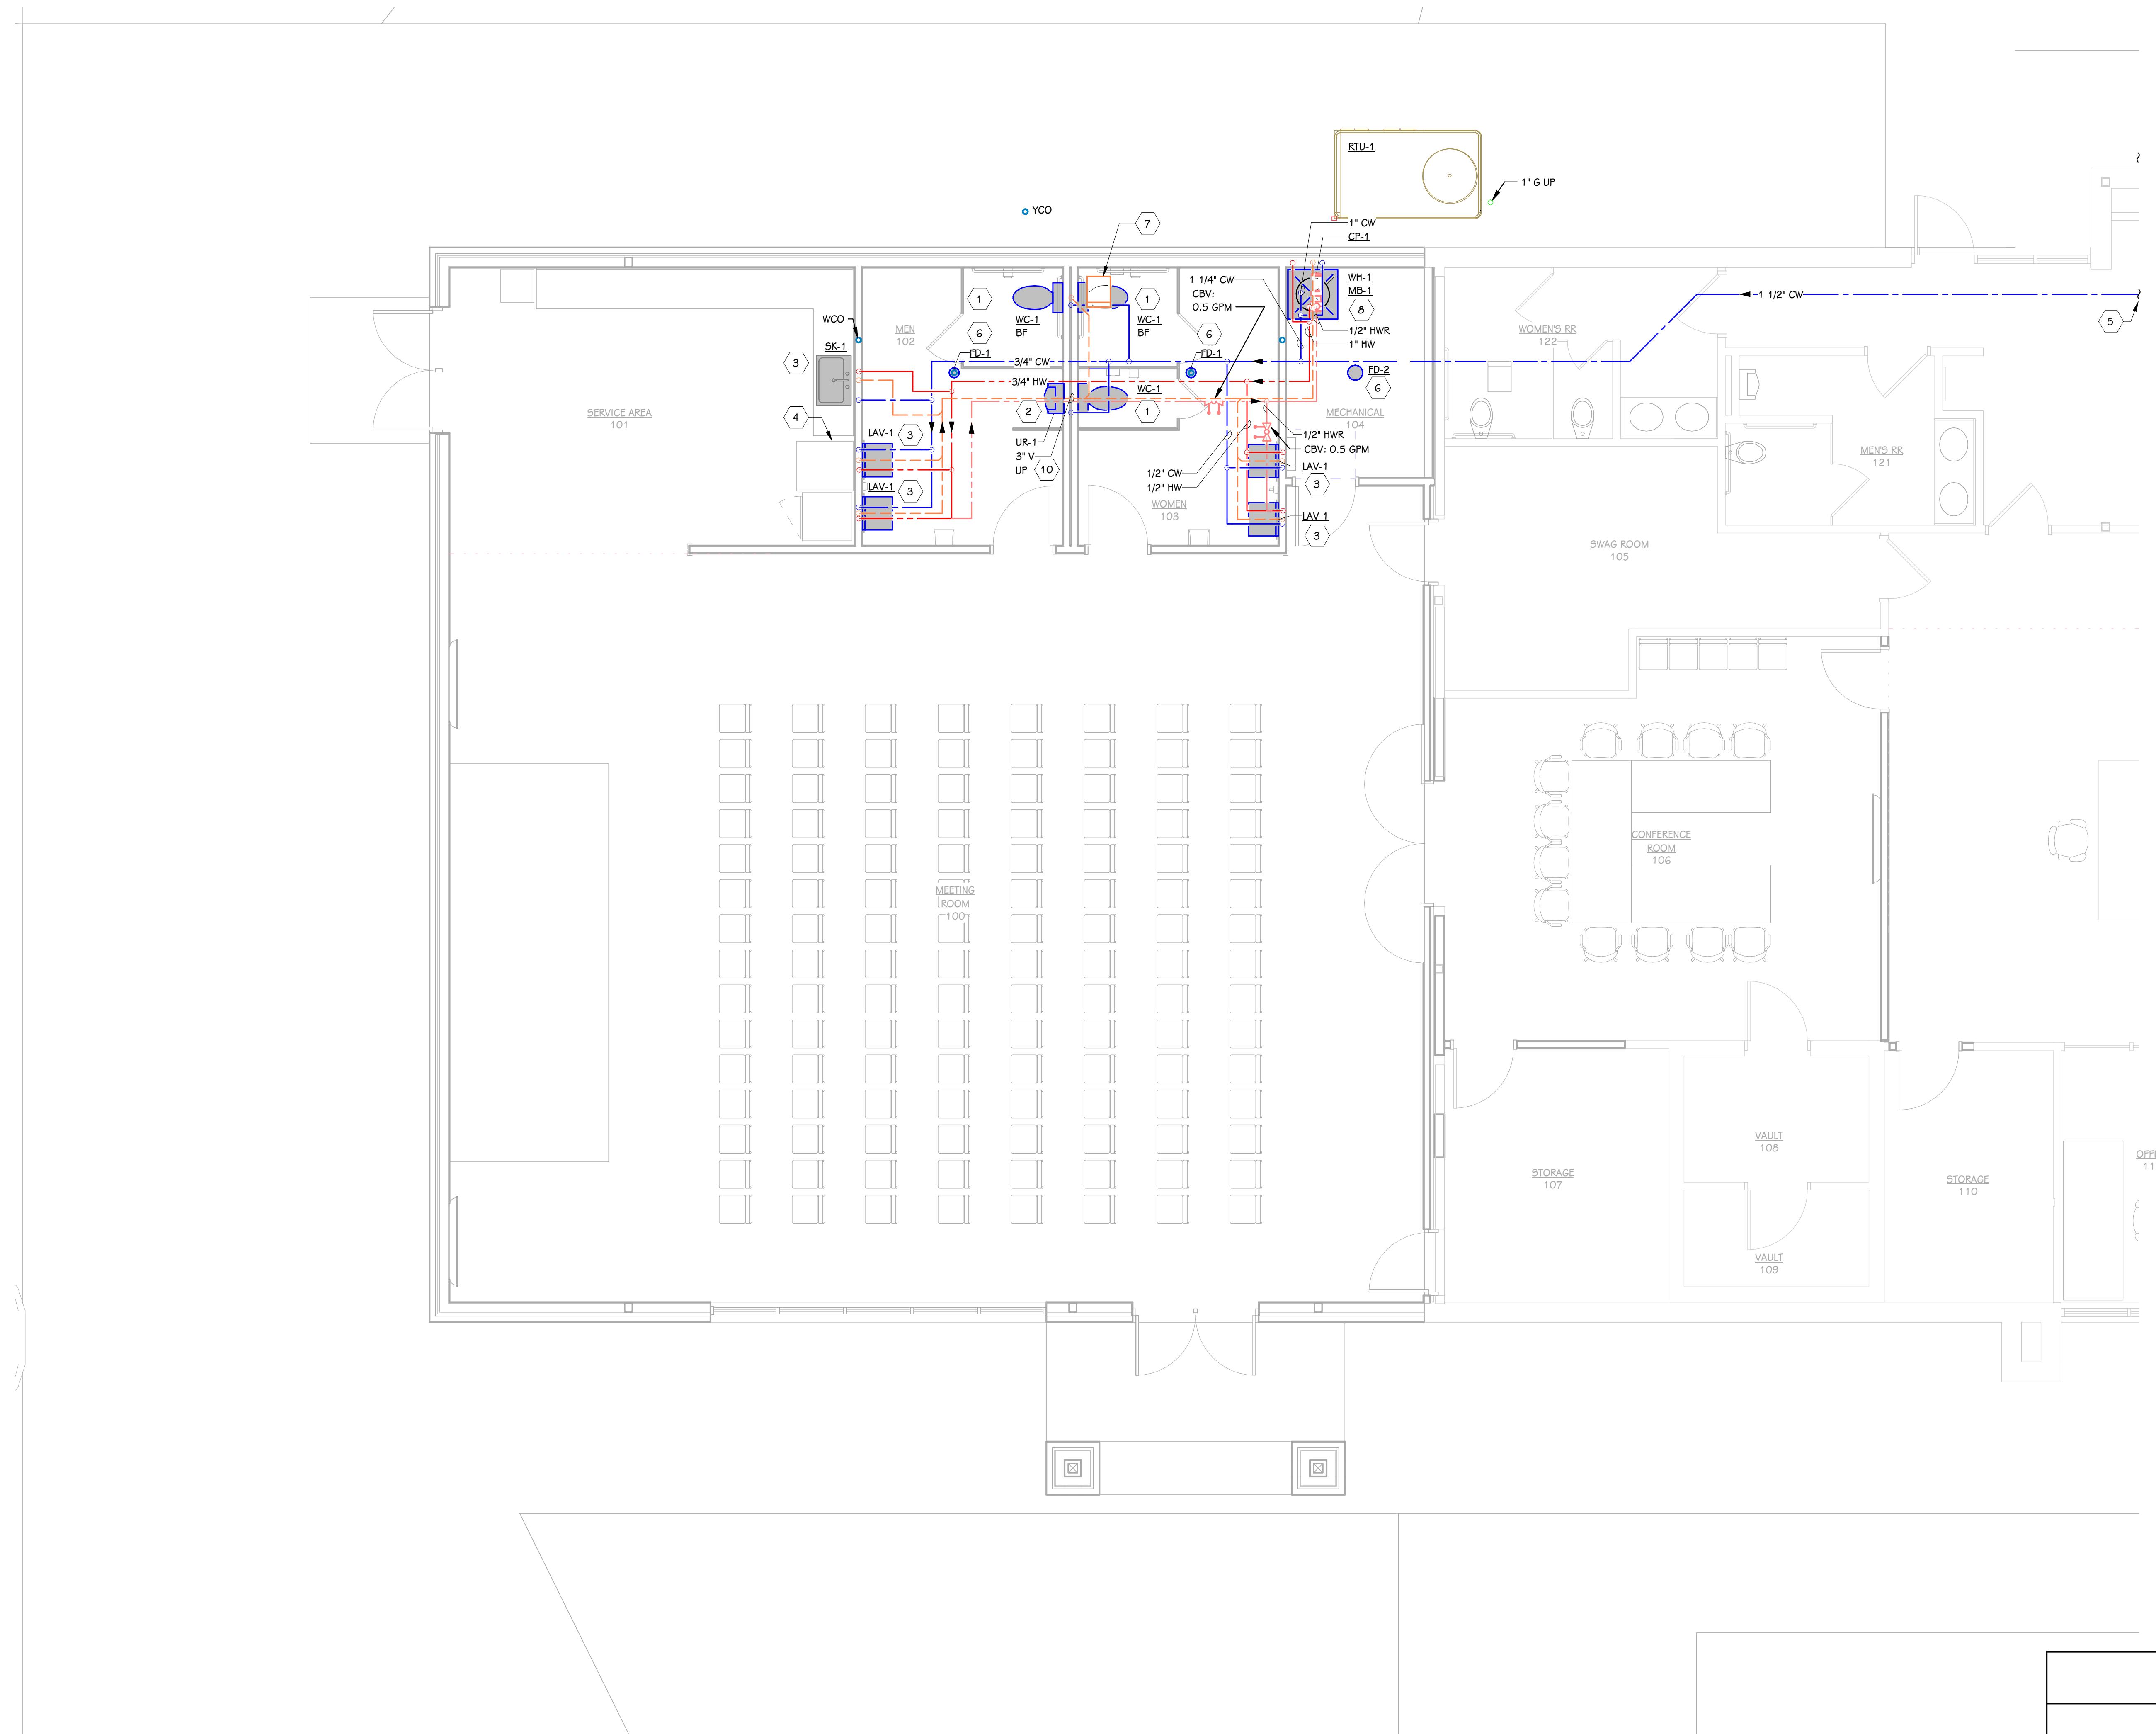

KEYED NOTES - PLUMBING - DOMESTIC


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- 13 CONTRACTOR TO FIELD VERIFY EXISTING LINE SIZE AND NOTIFY ENGINEER OF ANY DISCREPANCY.

ISSUED FOR DATE

PROJECT TITLE
TEAMSTERS LOCAL 2727 Building AdditionOWNER
TEAMSTERS LOCAL 2727
4810 N Preston Hwy
Sheppardsville, KYSHEET TITLE
PLUMBING PLAN - ADDITION
SHEET NUMBER
P 101
25-376.000DATE
JANUARY 16, 2026


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TEAMSTERS LOCAL 2727

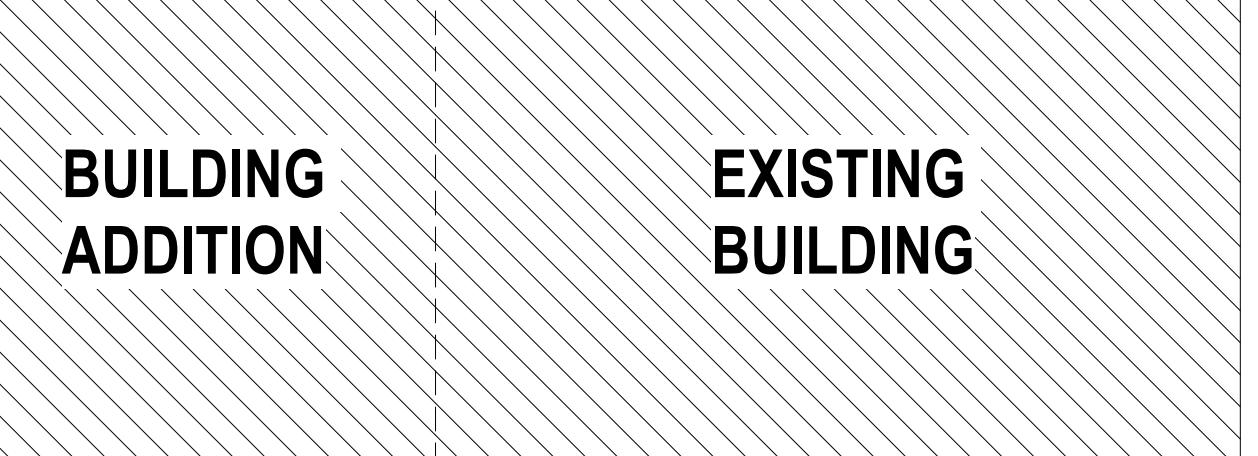


KEY PLAN

PLUMBING PLAN - ADDITION
1/4" = 1'-0"

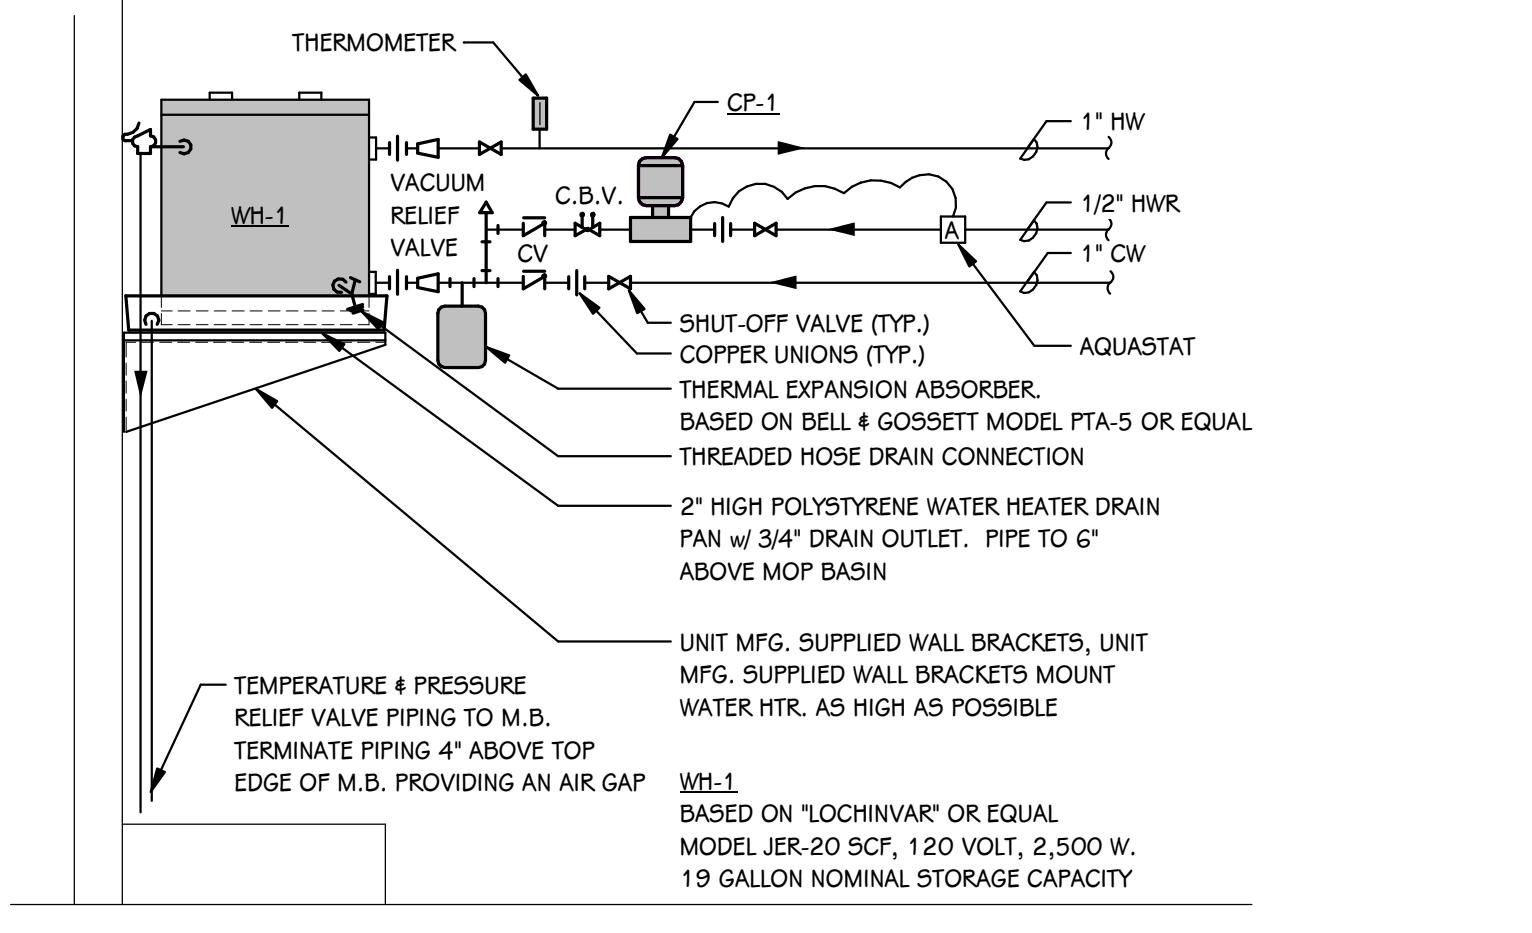


SHELF MOUNTED ELECTRIC WATER HEATER DETAIL (WH-1)

PIPING SLEEVE DETAIL - INTERIOR WALL

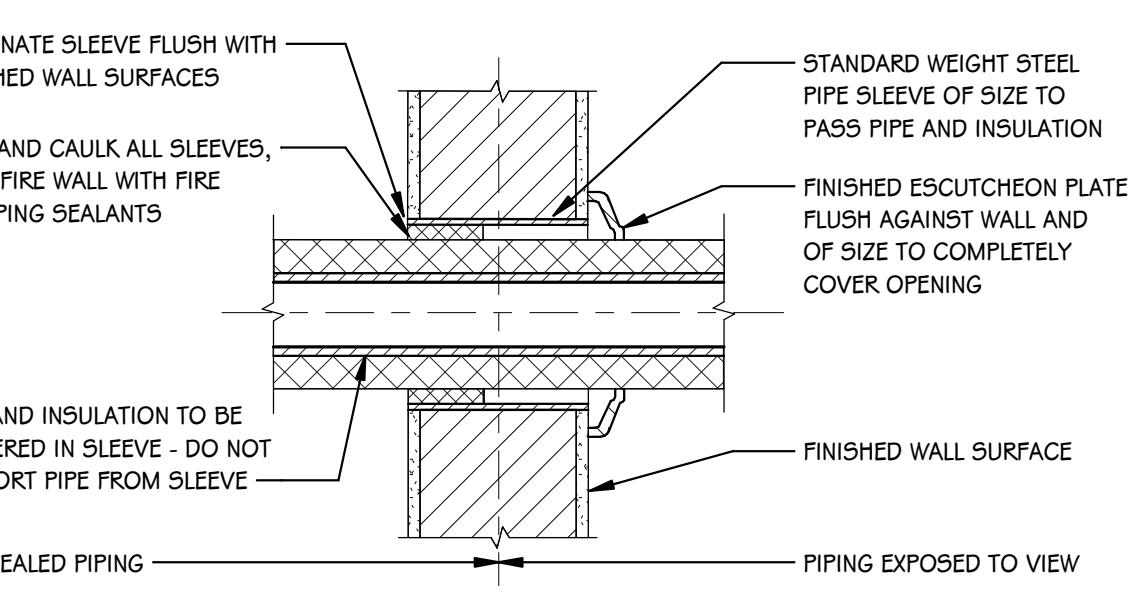


SCALE: NONE

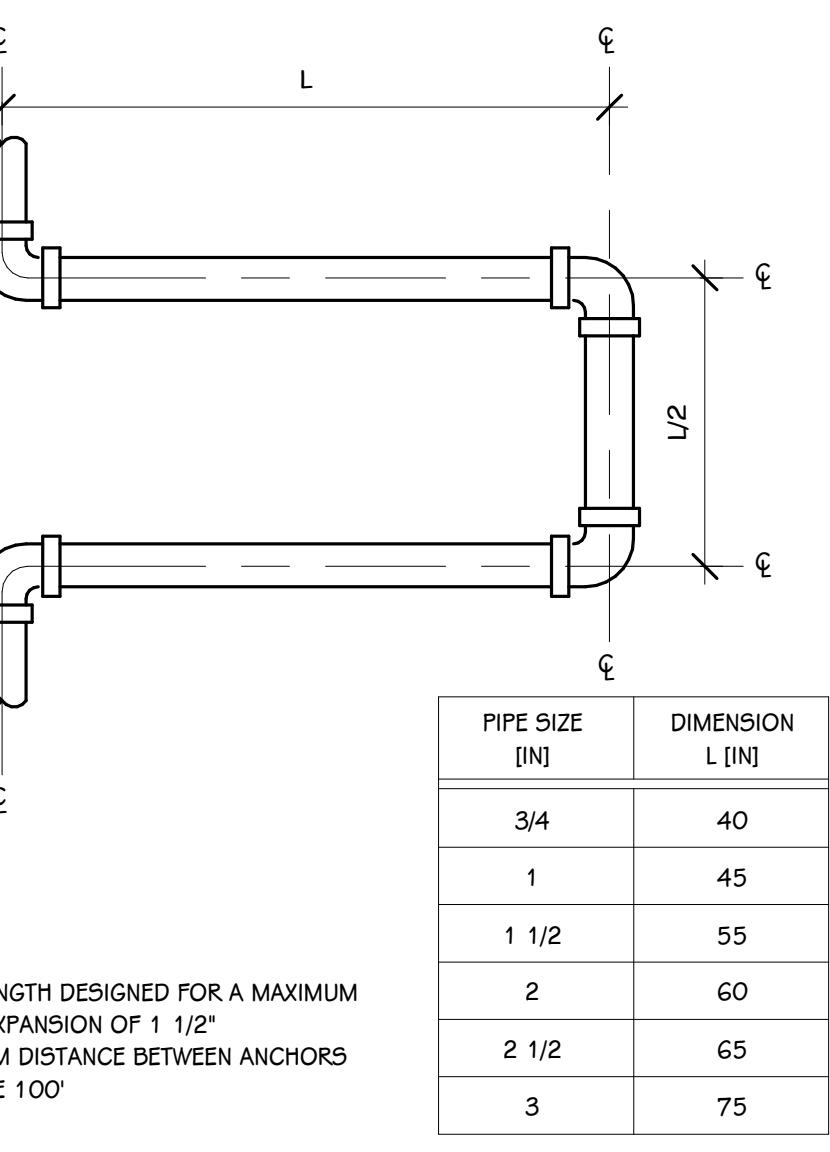


DOMESTIC HOT WATER EXPANSION LOOP DETAIL

SCALE: NONE

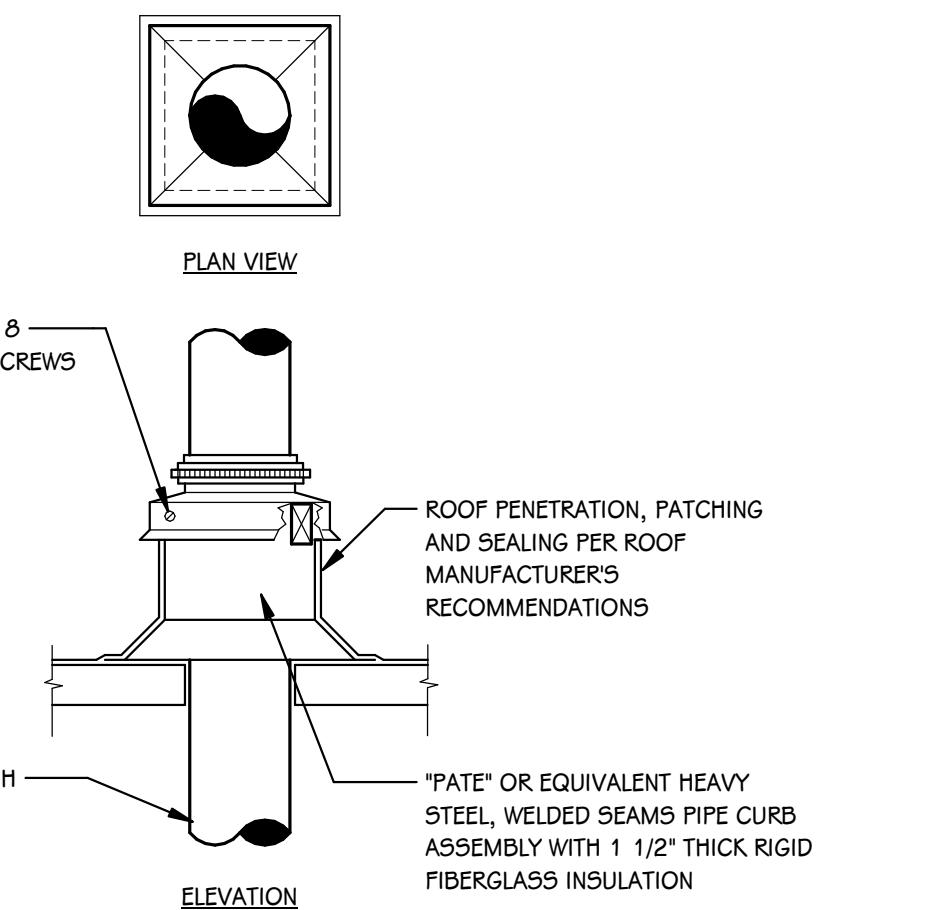


PIPE CURB DETAIL - SINGLE

SCALE: NONE

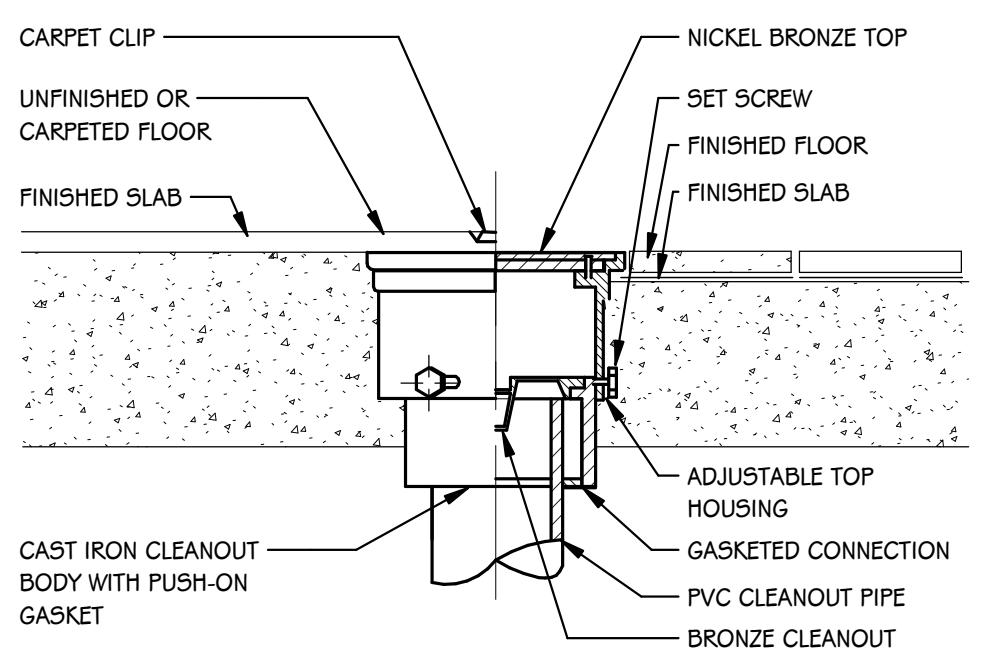


FLOOR CLEANOUT DETAIL

SCALE: NONE

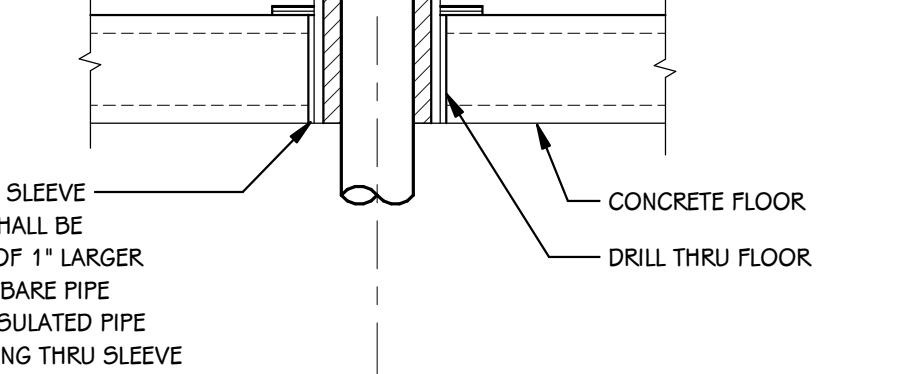


PIPING SLEEVE DETAIL - THRU FLOOR

SCALE: NONE

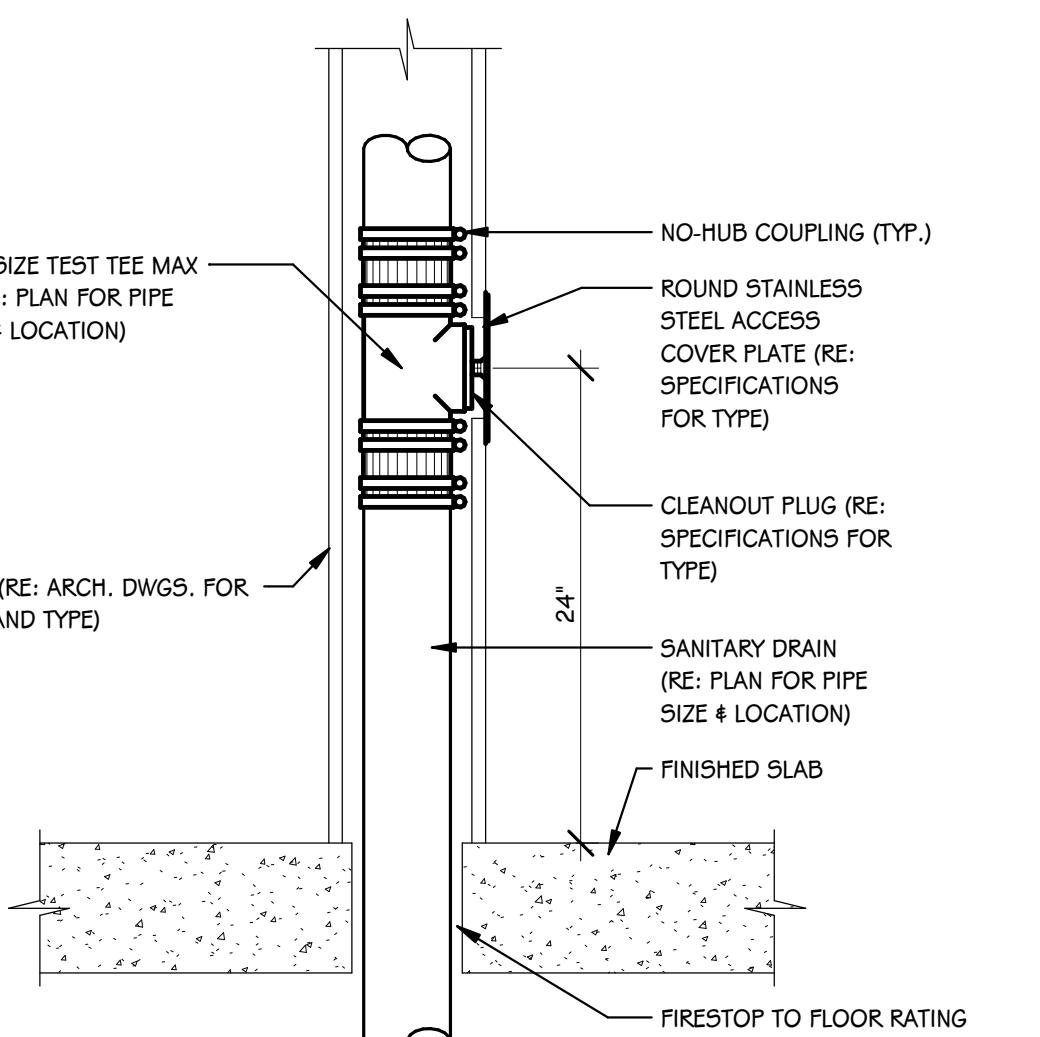


WALL CLEANOUT DETAIL

SCALE: NONE

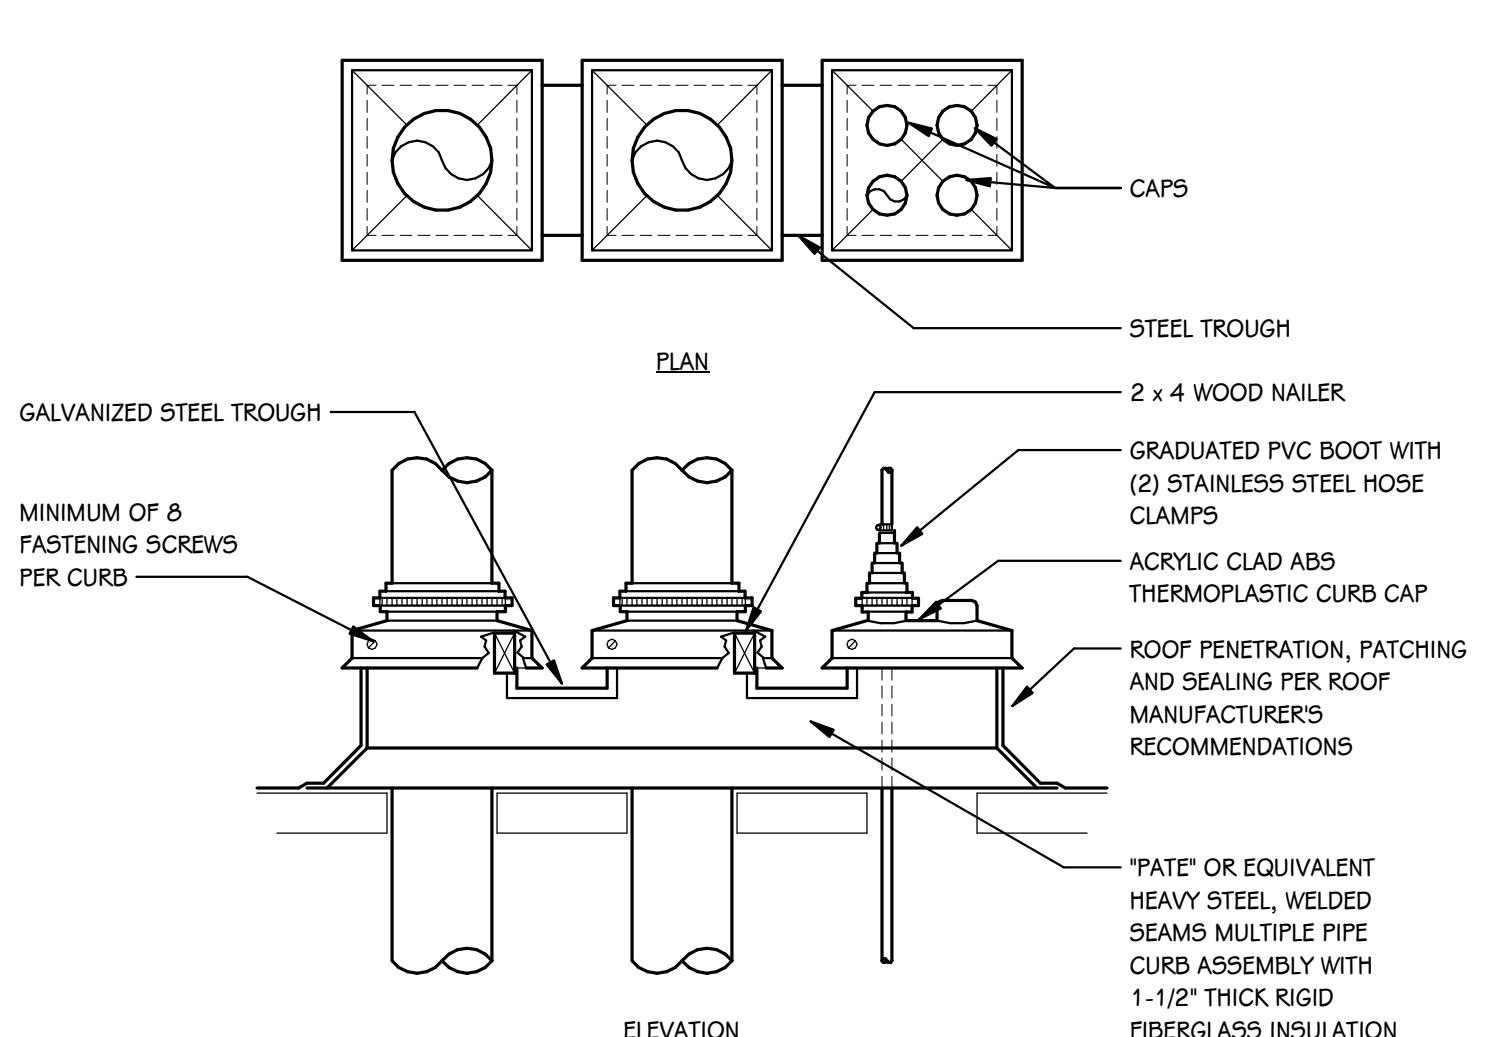


PIPE CURB DETAIL - MULTIPLE

SCALE: NONE

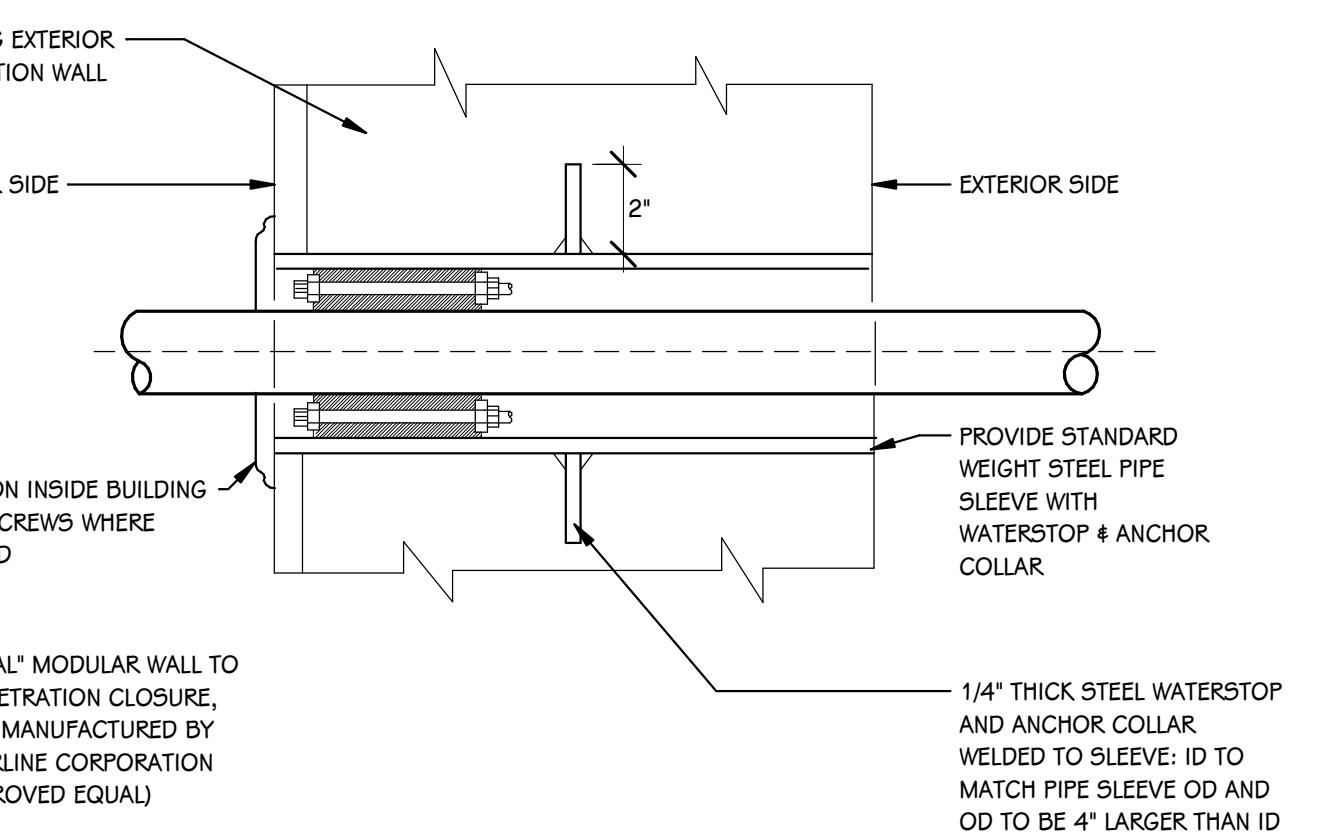

EXTERIOR WALL SLEEVE DETAIL

SCALE: NONE

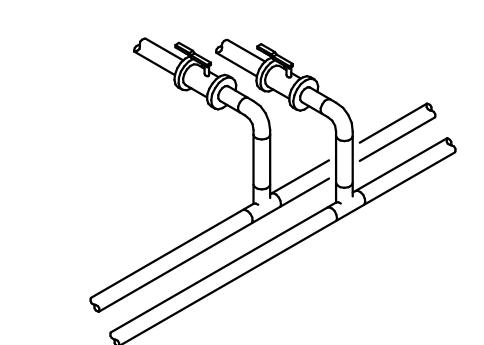

BRANCH CONNECTION OFF TOP

APPLIES TO THE FOLLOWING SYSTEMS:
DOMESTIC WATER
NATURAL GAS
COMPRESSED AIR
STEAM / CONDENSATE


BRANCH TAKE-OFF PIPING DETAIL

SCALE: NONE

NATURAL GAS LOAD SCHEDULE - TOTAL BUILDING		
EQUIPMENT	LOAD (CFH)	PRESSURE (IN WC)
EXIST. GF-1	80	4" - 14"
EXIST. GF-2	80	4" - 14"
EXIST. GF-3	80	4" - 14"
RTU-1	150	4" - 14"
	390	


NATURAL GAS LOAD SCHEDULE - TOTAL BUILDING

SCALE: NONE

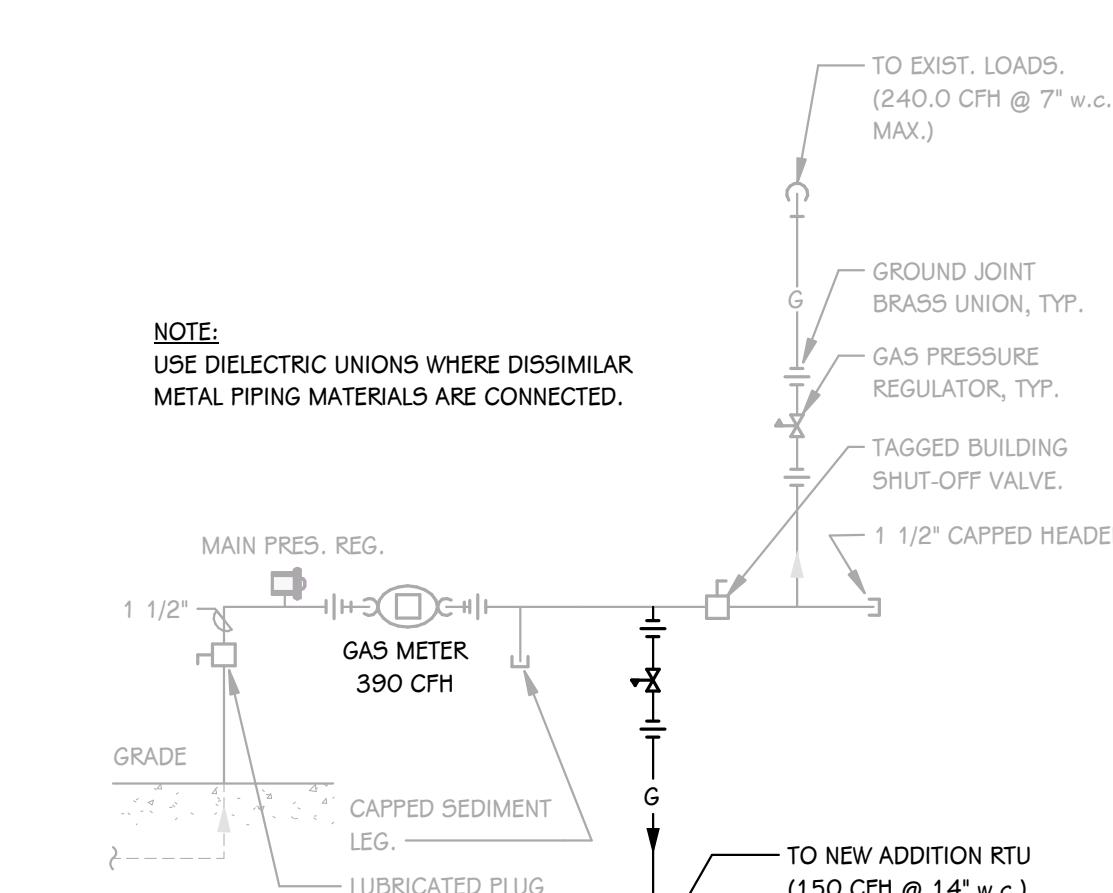


GAS SERVICE PIPING DETAIL

SCALE: NONE

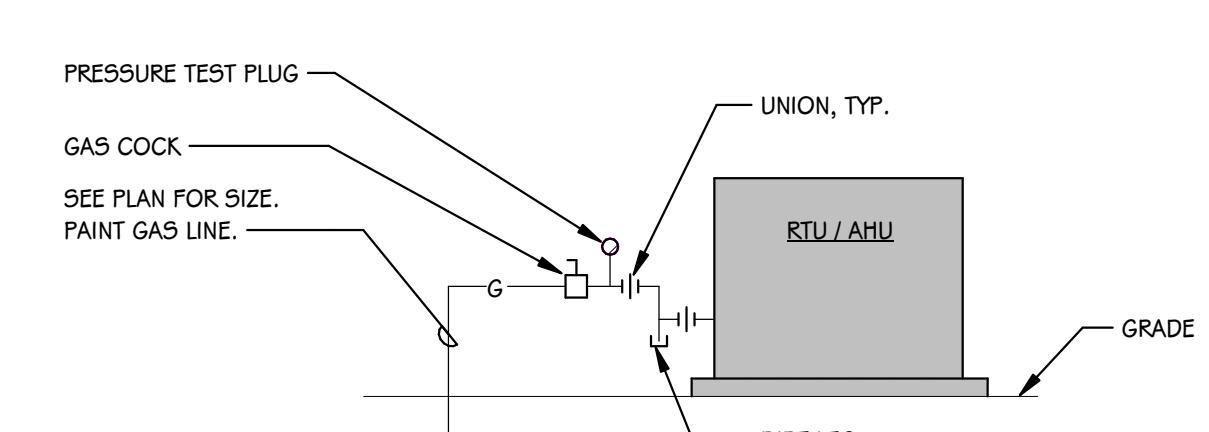

TYPICAL RTU GAS PIPING DETAIL

SCALE: NONE

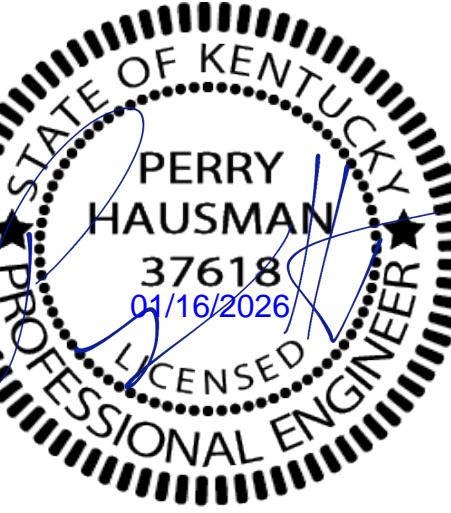

ISSUED FOR DATE

PROJECT TITLE TEAMSTERS LOCAL 2727 Building Addition

OWNER TEAMSTERS LOCAL 2727

SHEET TITLE FIRST FLOOR MECHANICAL DEMOLITION PLAN - ADDITION


SHEET NUMBER MD 101

DATE JANUARY 16, 2026

PAGE 25-376.000


KEYED NOTES - MECHANICAL - DEMOLITION

1 REMOVE GRILLE OR DIFFUSER AND ASSOCIATED DUCTWORK AS INDICATED. PREPARE FOR NEW WORK.

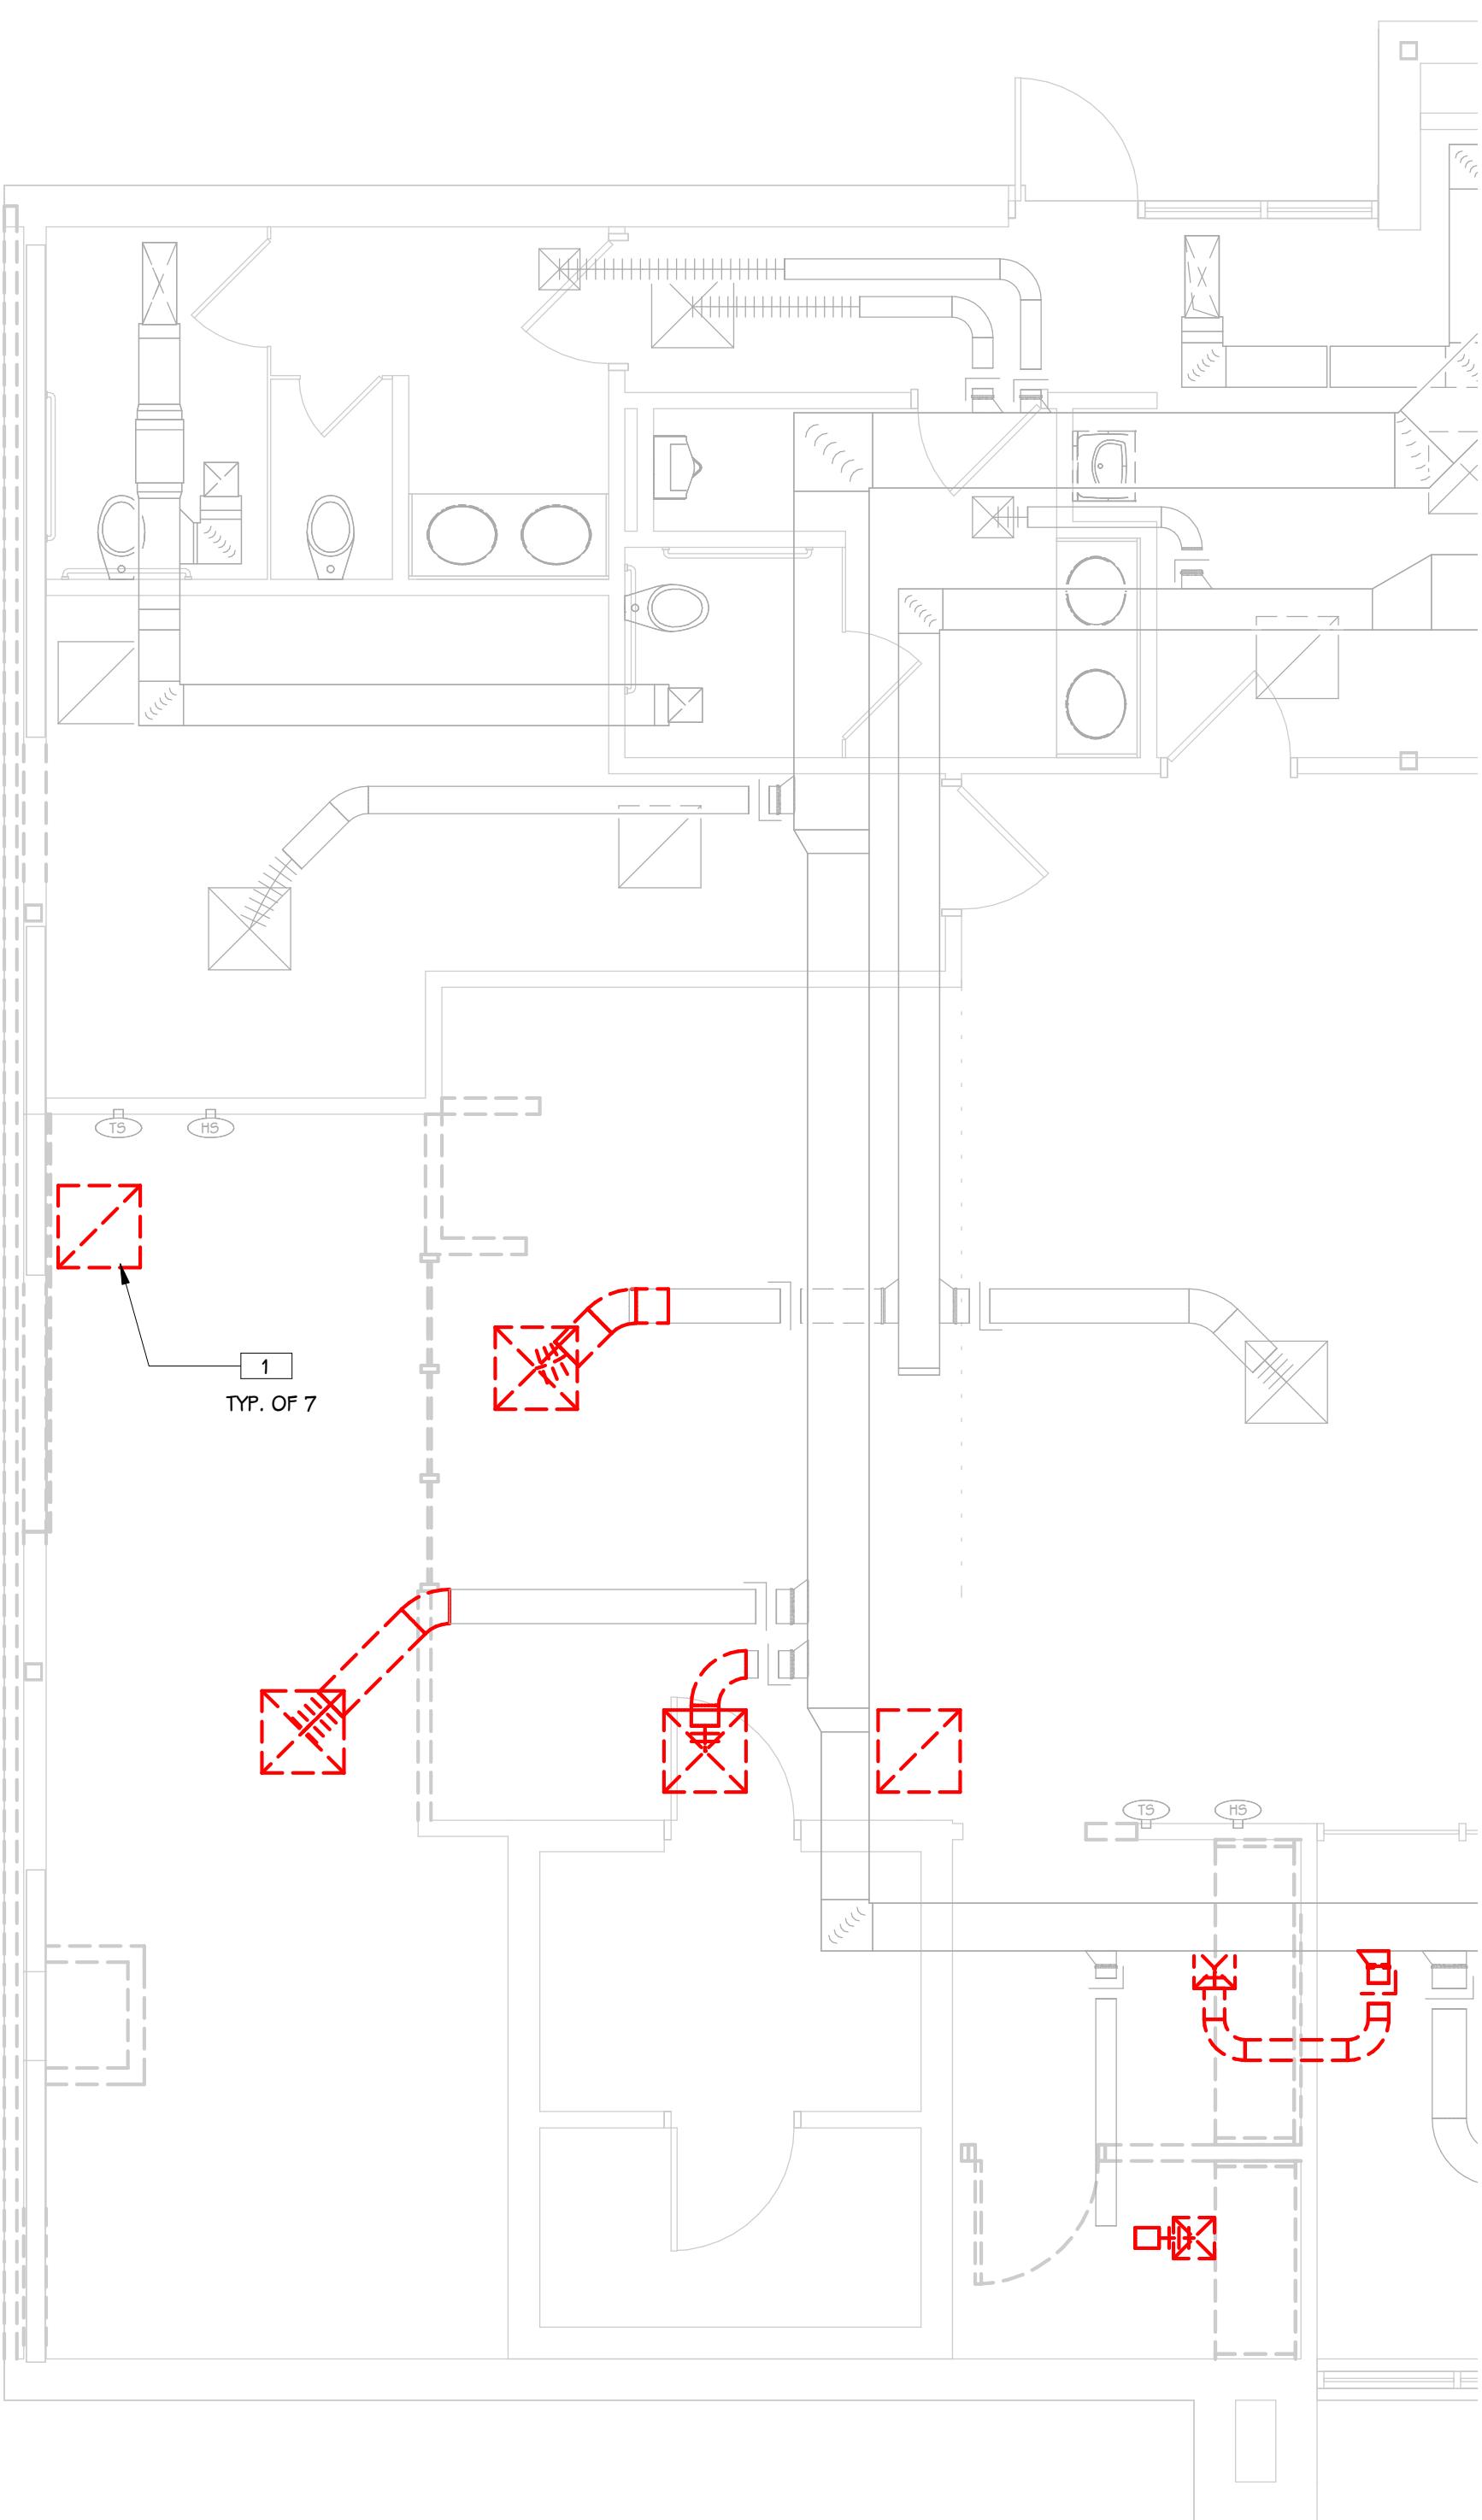

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TEAMSTERS LOCAL 2727

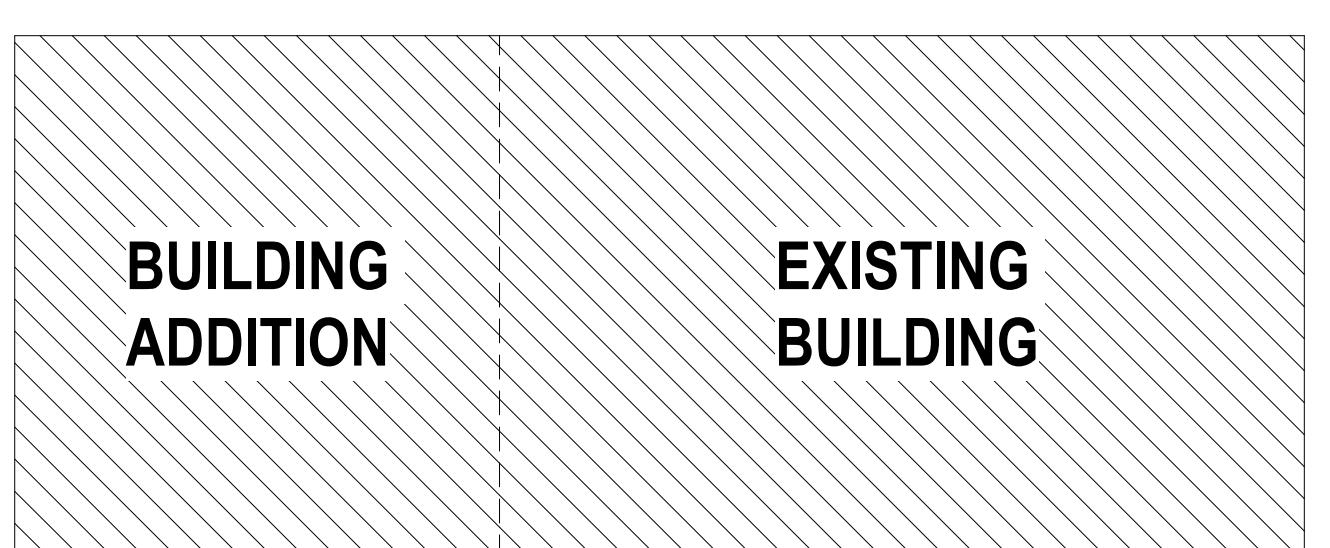


KEY PLAN



FIRST FLOOR MECHANICAL DEMOLITION PLAN - ADDITION


1/4" = 1'-0"

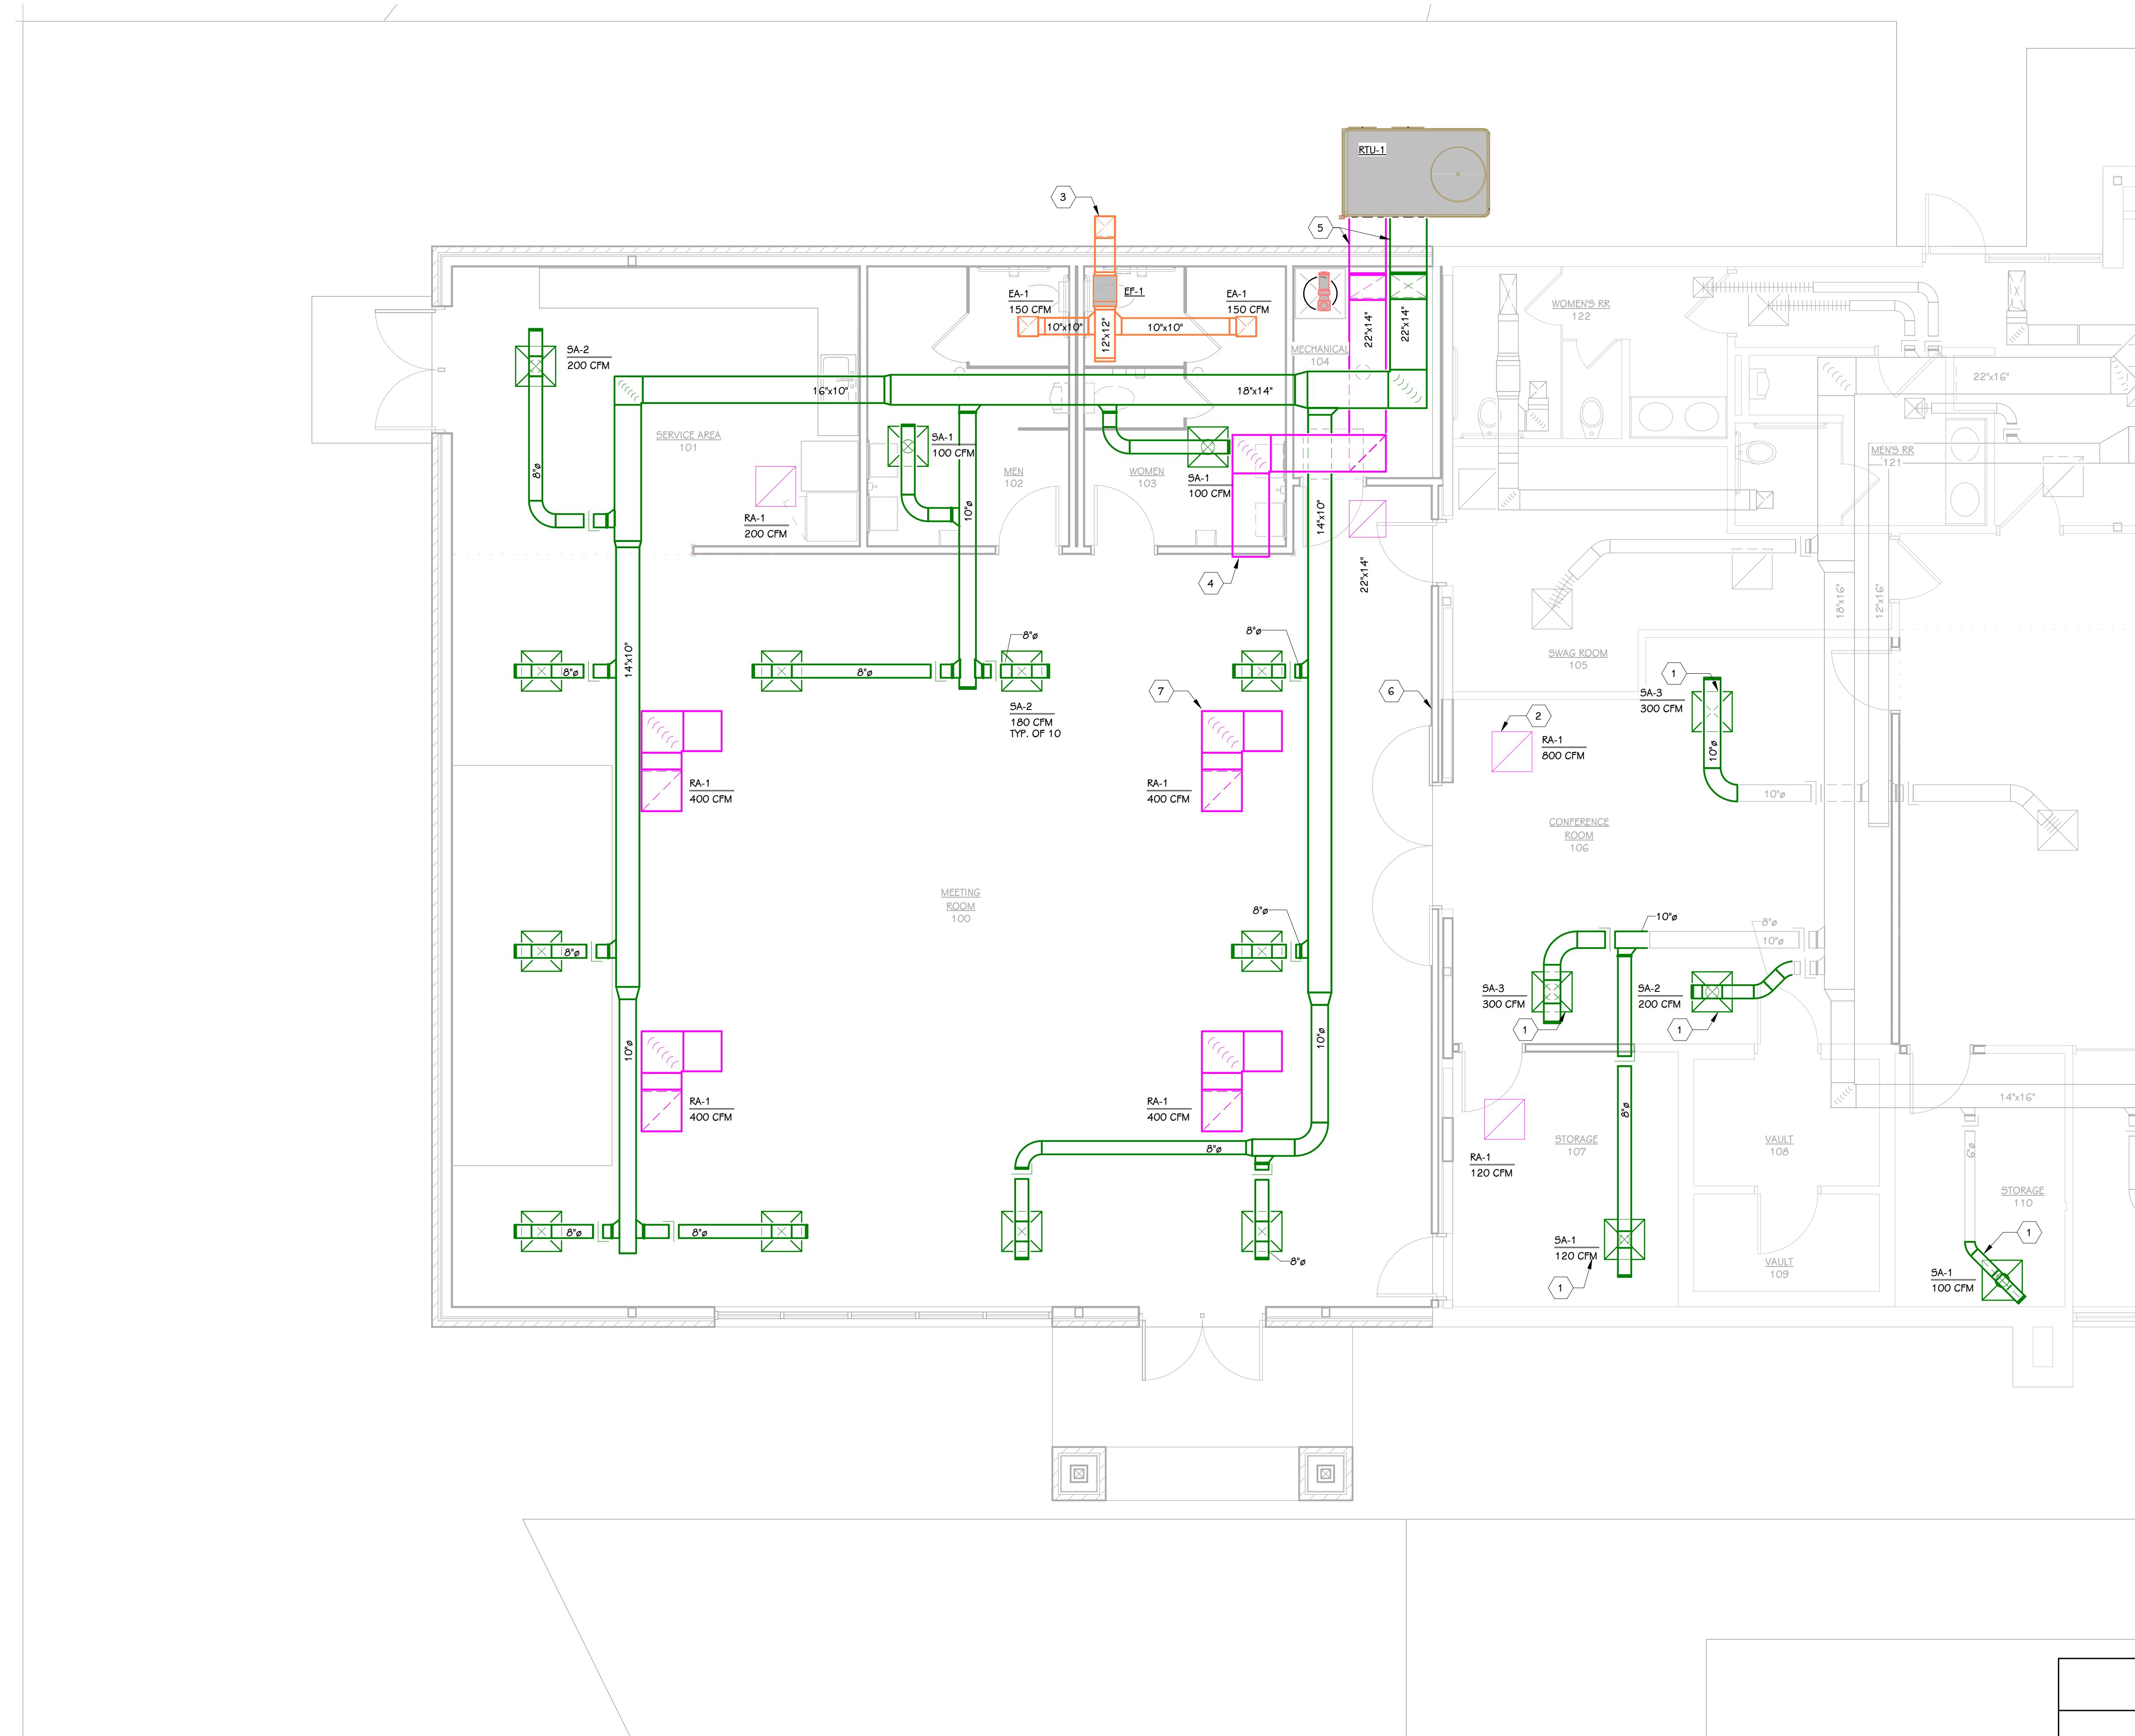

MECHANICAL FLOOR PLAN - ADDITION
1/4" = 1'-0"

KEYED NOTES - MECHANICAL - SHEET METAL

- 1 TIE NEW GRILLE OR DIFFUSER INTO EXISTING DUCTWORK AS INDICATED. BALANCE TO CFM LISTED ON DRAWING.
- 2 REFER TO RETURN AIR BOOT DETAIL.
- 3 DUCT HORIZONTAL THROUGH SOFFIT. TERMINATE WITH SOFFIT VENT.
- 4 CONNECT TO CEILING RETURN PLENUM.
- 5 EXTERIOR DUCTWORK BASED ON "THERMA-DUCT" PHENOLIC DUCT.
- 6 THERMOSTAT.
- 7 REFER TO RETURN AIR PLUMEN TRANSFER DUCT DETAIL SHEET M501.

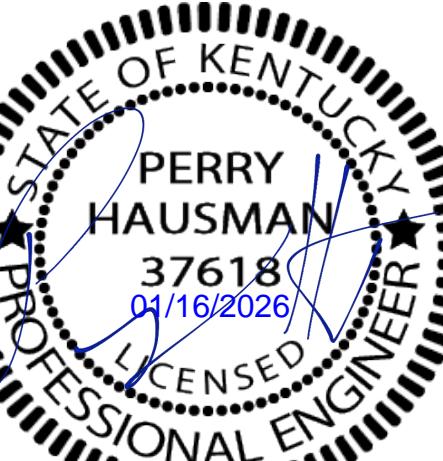


ISSUED FOR DATE


PROJECT TITLE
TEAMSTERS LOCAL 2727 Building AdditionOWNER
TEAMSTERS LOCAL 2727SHEET TITLE
FIRST FLOOR SHEET METAL PLAN -
ADDITIONSHEET NUMBER
M 101
25-376.000
DATE
JANUARY 16, 2006

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TEAMSTERS LOCAL 2727

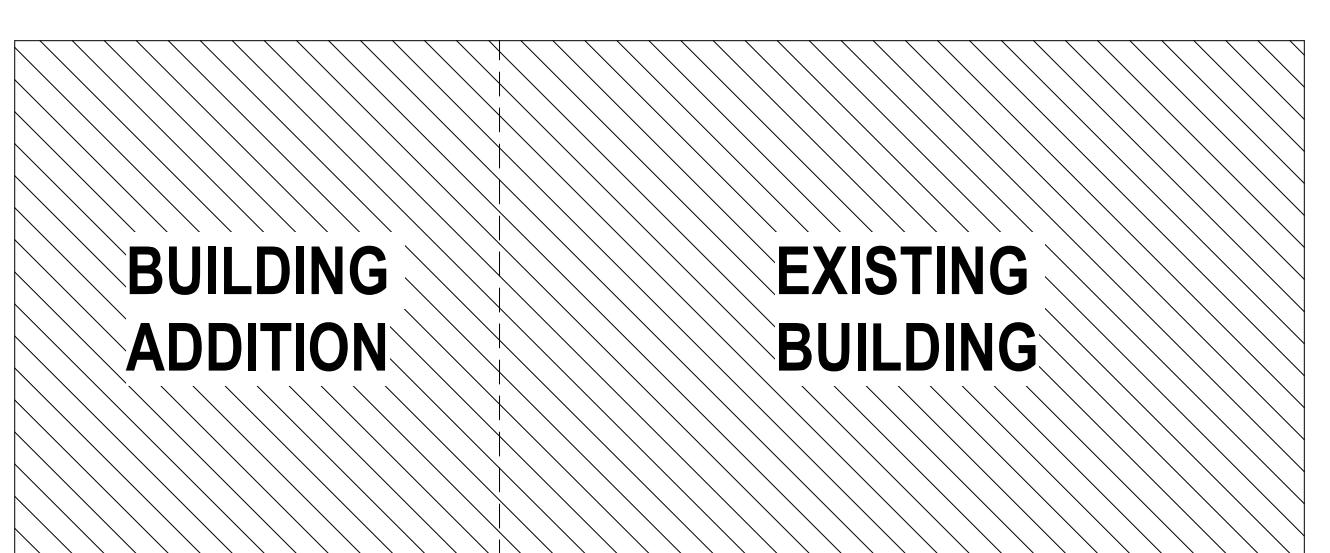

KEY PLAN

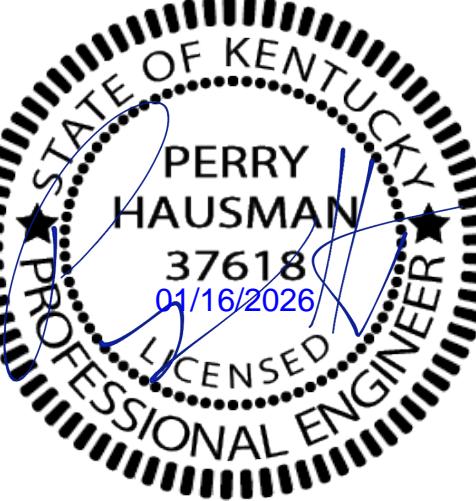



ISSUED FOR DATE

PROJECT TITLE
TEAMSTERS LOCAL 2727 Building Addition

OWNER
TEAMSTERS LOCAL 2727
4810 N Preston Hwy
Sheppardsville, KY

SHEET TITLE
MECHANICAL SCHEDULES AND DETAILS
SHEET NUMBER
M 501
25-376.000

DATE
JANUARY 16, 2026

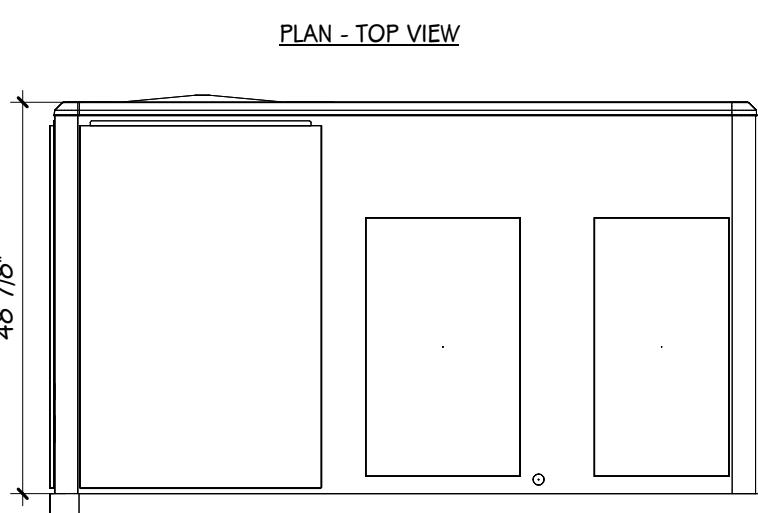
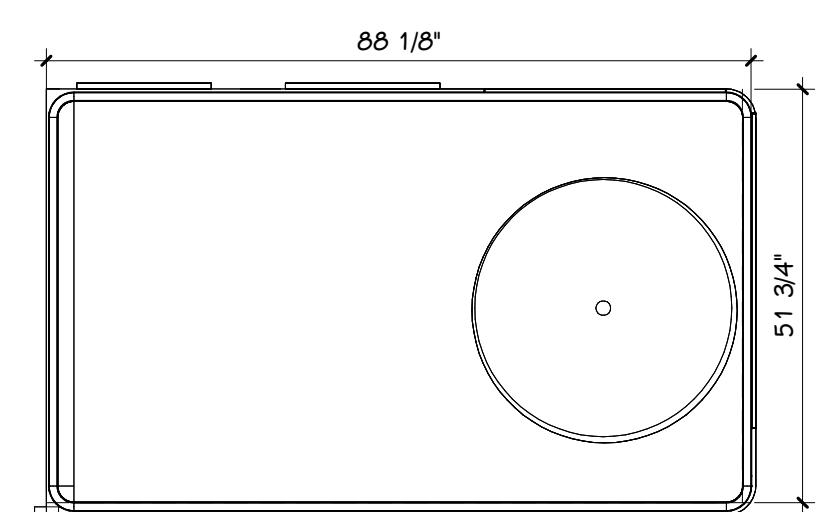


GRADE MOUNTED VAV AIR HANDLING UNIT (RTU-1)


DISCHARGE / INLET SOUND POWER LEVELS (dB)						
	63.1Hz	125.1Hz	250.1Hz	500.1Hz	1.1kHz	2.1kHz
RETURN IN	75	74	68	57	54	52
SUPPLY	80	82	74	70	64	61
OA IN	84	85	84	85	82	76
					73	67
4.1kHz 6.1kHz						

AREA SERVED: ADDITION
TYPE: GRADE MOUNTED, SINGLE ZONE, VARIABLE VOLUME, NATURAL GAS HEATING, DX COOLING, SIDE DISCHARGE
MANUFACTURER: BASED ON "TRANE" MODEL YSK072A35B
WEIGHT: 1,130 LB
OUTSIDE AIR: 150 CFM (MIN) - 760 CFM (MAX) OA. PROVIDE WITH ECONOMIZER AND DEMAND CONTROL VENTILATION
LOCATION: GRADE
UNIT MOUNTING: MOUNTED ON CONCRETE EQUIPMENT PAD
FILTER SECTION: 2" PLEATED MERV 13 FILTERS
DX COOLING SECTION: 61.20 MBH, 59.07 SMRH, 81.60°F EDB, 67.31°F DB, 53.57°F LDB, 53.50°F LWD, R-454B REFRIGERANT.
NATURAL GAS HEATING SECTION: 150 MBH INPUT, 121.5 MBH OUTPUT, 46.80°F EAT, 103.56°F LAT.
SUPPLY FAN: 1 FAN @ 3 HP, 0.782 BHP, 2000 CFM @ 1" ESP, 1.266" TSP, 1068 RPM, 208/360.
ELECTRICAL: SINGLE-POINT POWER CONNECTION WITH FACTORY FUSED DISCONNECT W/ LOCKING HANDLE, 208/360, COMPRESSOR 1 RLA 14.8 A, COMPRESSOR 2 RLA 7.4 A, CONDENSER FAN PLA 3.3 A, EVAPORATOR FAN PLA 8.0 A, 38.00 MCA, 50 MOP, 7.6 kW AND DEDICATED 120/160 POWER CONNECTION FOR CONVENIENCE RECEPTACLE AND LIGHTS.
OPTIONS: PROVIDE WITH MINIMUM 3 YEAR MANUFACTURER'S WARRANTY, DUCT DETECTORS, & CONVENIENCE RECEPTACLE.


DUCTWORK GENERAL NOTES
1. ALL JOINTS, CORNERS AND SEAMS TO BE FULLY
SEALED WITH SMACNA APPROVED DUCTWORK
SEALANT.
2. ALL DUCTWORK IS TO BE LEAK TESTED AT PRESSURES
SPECIFIED.
3. ALL RADIUS ELBOWS SHALL HAVE MINIMUM 1.5
CENTERLINE RADIUS.
4. USE 45° ELBOW WITH TURNING VENES WHEN
CENTERLINE RADIUS IS LESS THAN 1.5.

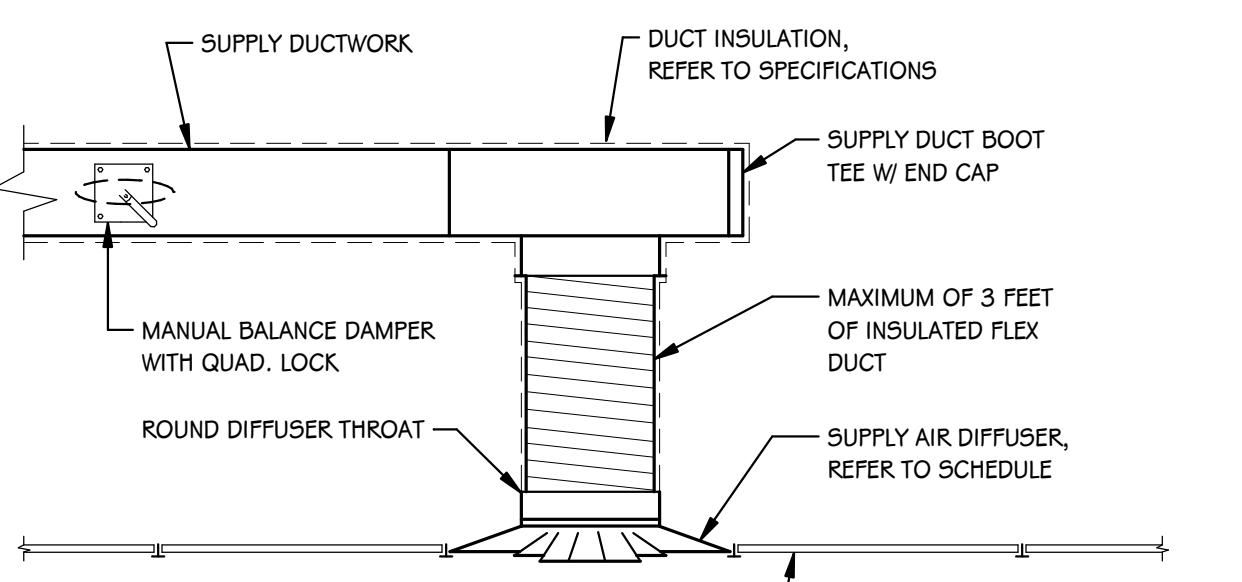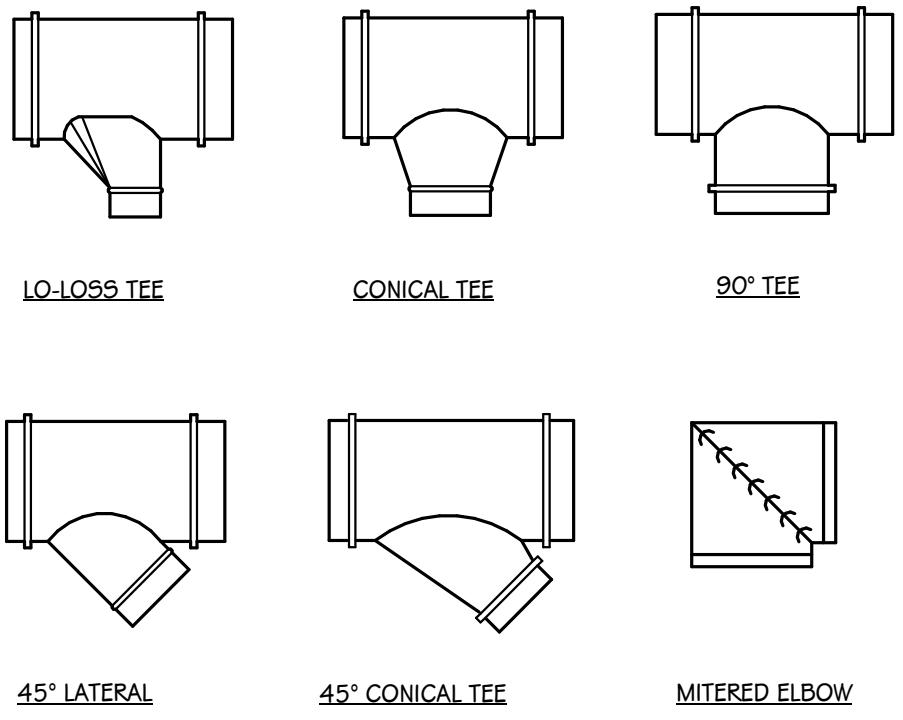

CEILING MOUNTED SUPPLY DIFFUSER DETAIL - TYPICAL

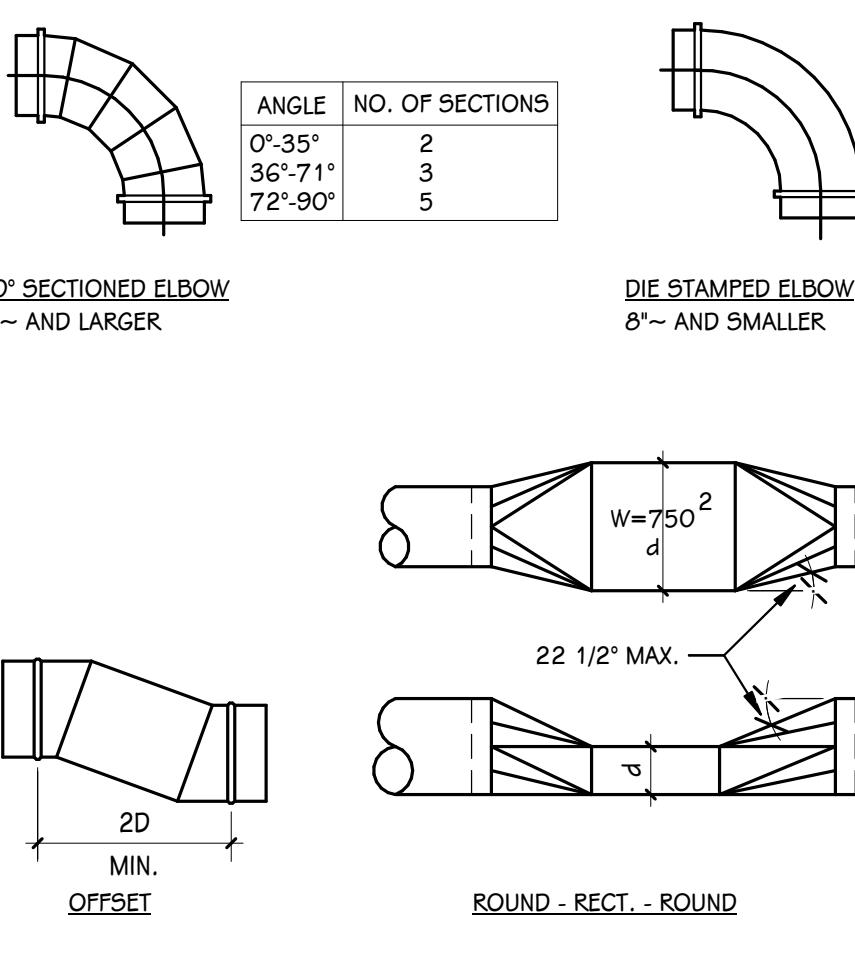

DUCTWORK FITTING DETAILS - ROUND/oval

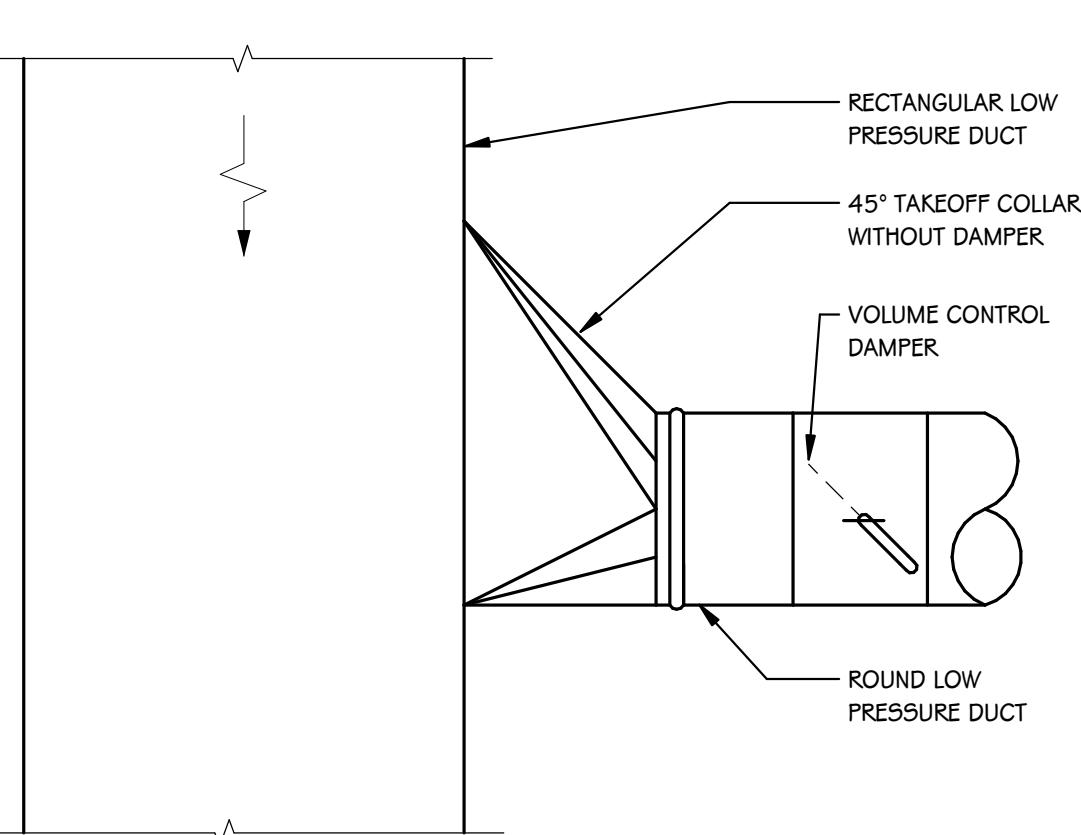

TAKEOFF DETAIL - RECTANGULAR TO ROUND

EXHAUST FANS

BASED ON GREENHECK										
MARK	MODEL	TYPE	AIR FLOW (CFM)	ESP (IN WC)	SONES	MOTOR DATA				REMARKS
EF-1	CSP-A390-VG	DIRECT DRIVE	300	0.50	2.2	Yes	0.05	0.05	1249	120 1 PROVIDE VARI-GREEN MOTOR.

GRILLES, REGISTERS, & DIFFUSERS


MARK	PANEL SIZE	FACE SIZE	NECK SIZE	MODEL	CFM RANGE	VCD	THROW	MATERIAL	FINISH	INSTALLATION
SA-1	24x24	-	6" Ø	ASCDA	120-200	NO		ALUMINUM	WHITE	LAY-IN
SA-2	24x24	-	8" Ø	ASCDA	175-315	NO		ALUMINUM	WHITE	LAY-IN
SA-3	24x24	-	10" Ø	ASCDA	210-490	NO		ALUMINUM	WHITE	LAY-IN
RA-1	24x24"	-	22x22"	80	500 - 2000	NO	-	ALUMINUM	WHITE	LAY-IN
EA-1	12x12"	-	12x12"	80	0-500	NO	-	ALUMINUM	WHITE	SURFACE

PUMPS

MARK	MODEL	FLOW RATE (GPM)	HEAD (FT)	RPM	VOLTAGE	PHASE	SYSTEM	LOCATION	REMARKS
CP-1	NBF-85/LW	4	5	2800	120	1	HWR	MECHANICAL	CONTROLLED BY AQUASTAT. LEAD-FREE BRONZE CIRCULATOR.



BRANCH TAKE OFFS DETAIL

SCALE: NONE

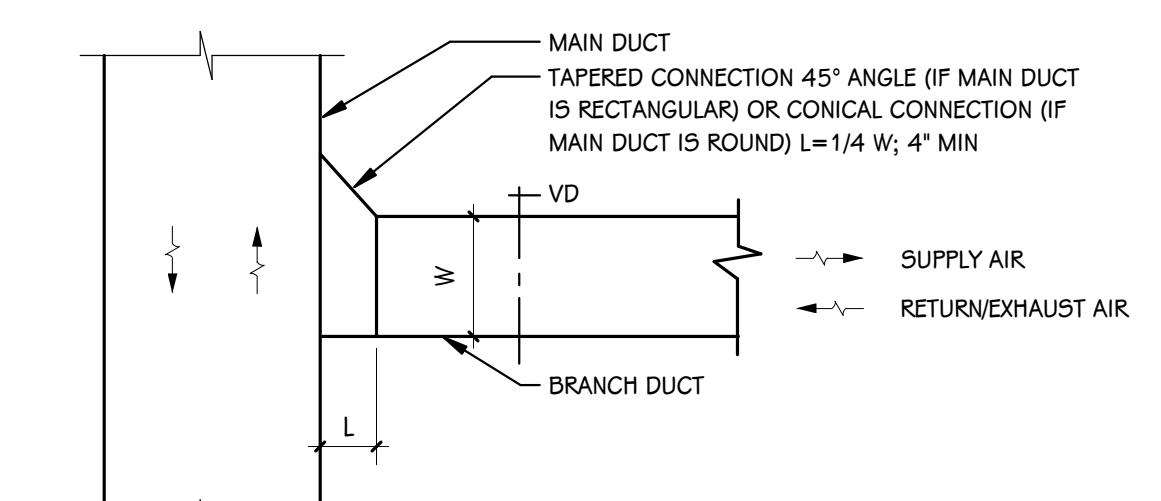

RETURN AIR BOOT DETAIL


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NOTE: 1. SEE PLANS LOCATION OF RETURN AIR TRANSFER DUCTS.

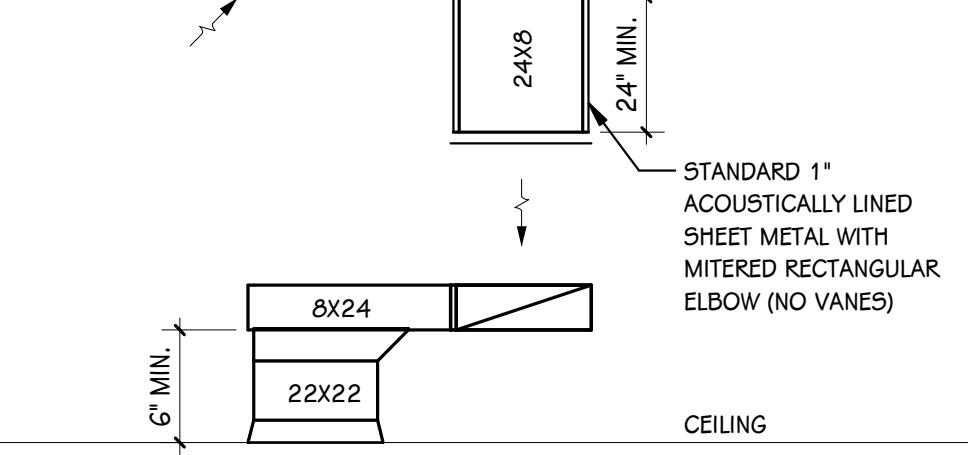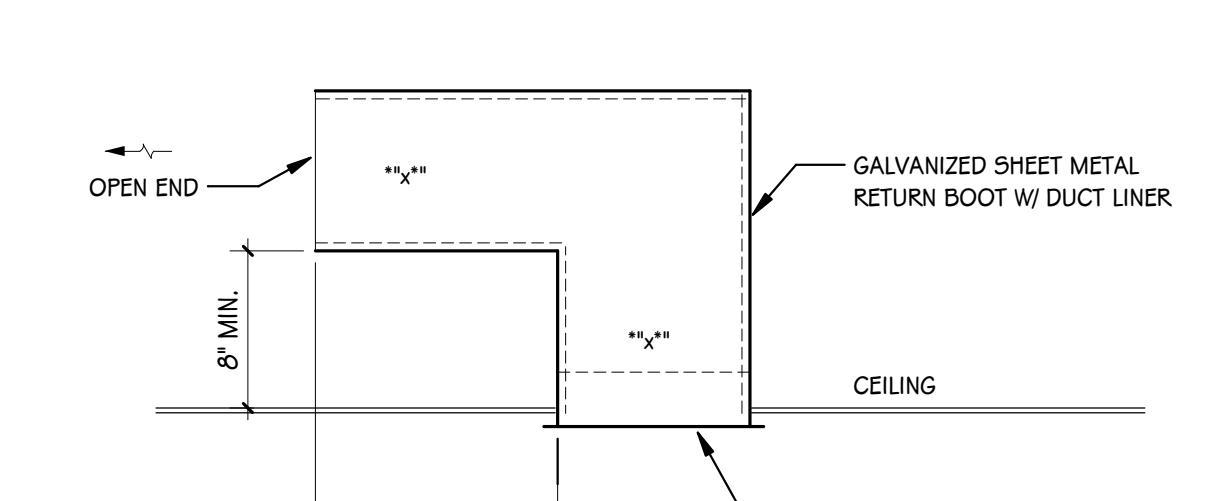
RETURN AIR PLUMEN TRANSFER DUCT DETAIL

SCALE: NONE



RETURN / EXHAUST AIR GRILLE PLENUM DETAIL


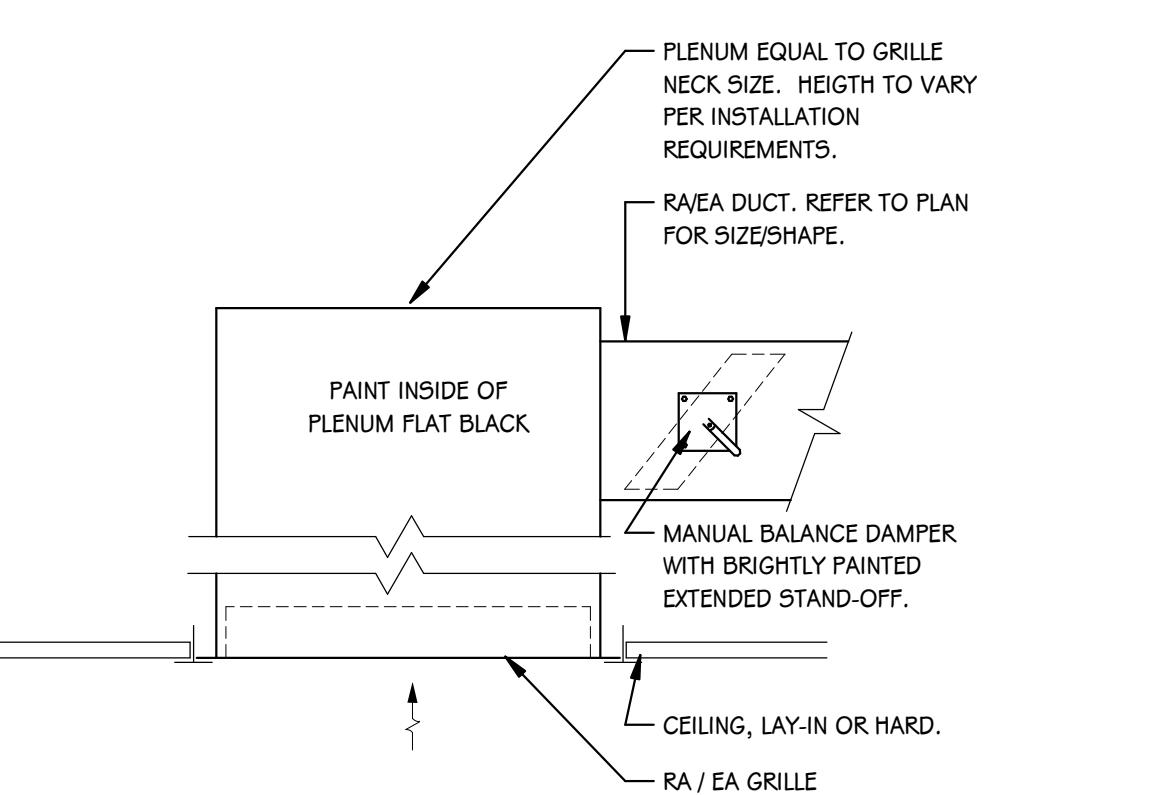
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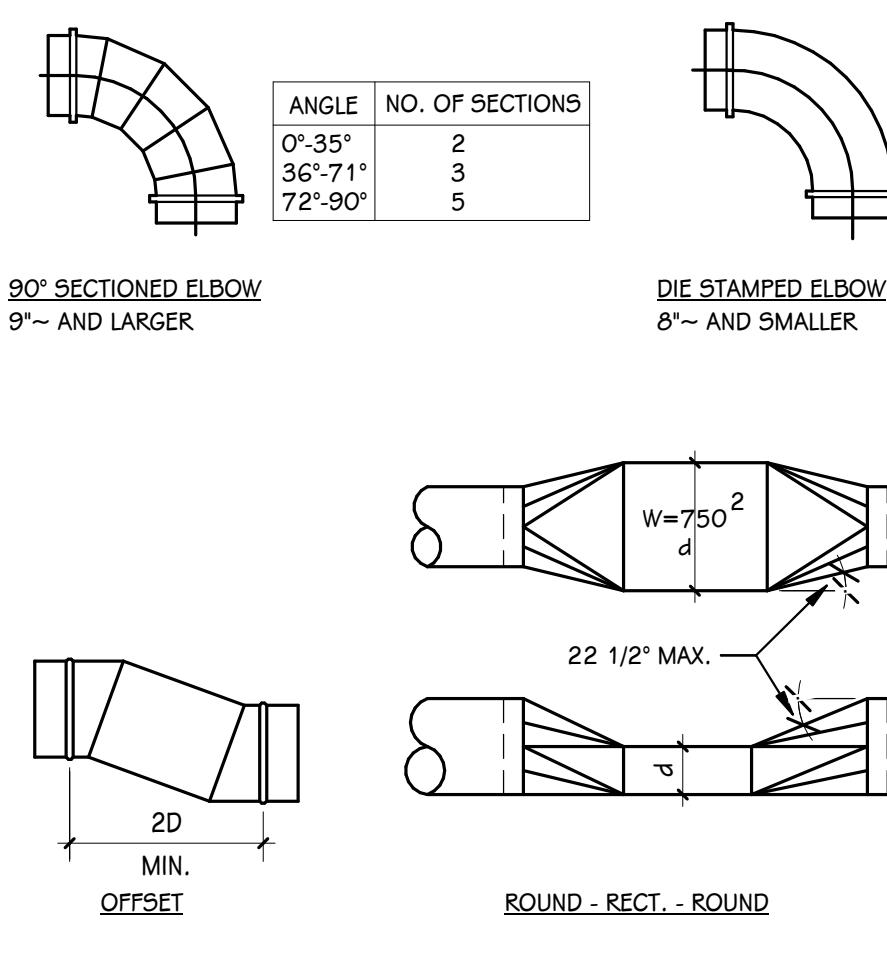
EXHAUST FAN DETAIL - DUCT THROUGH SOFFIT

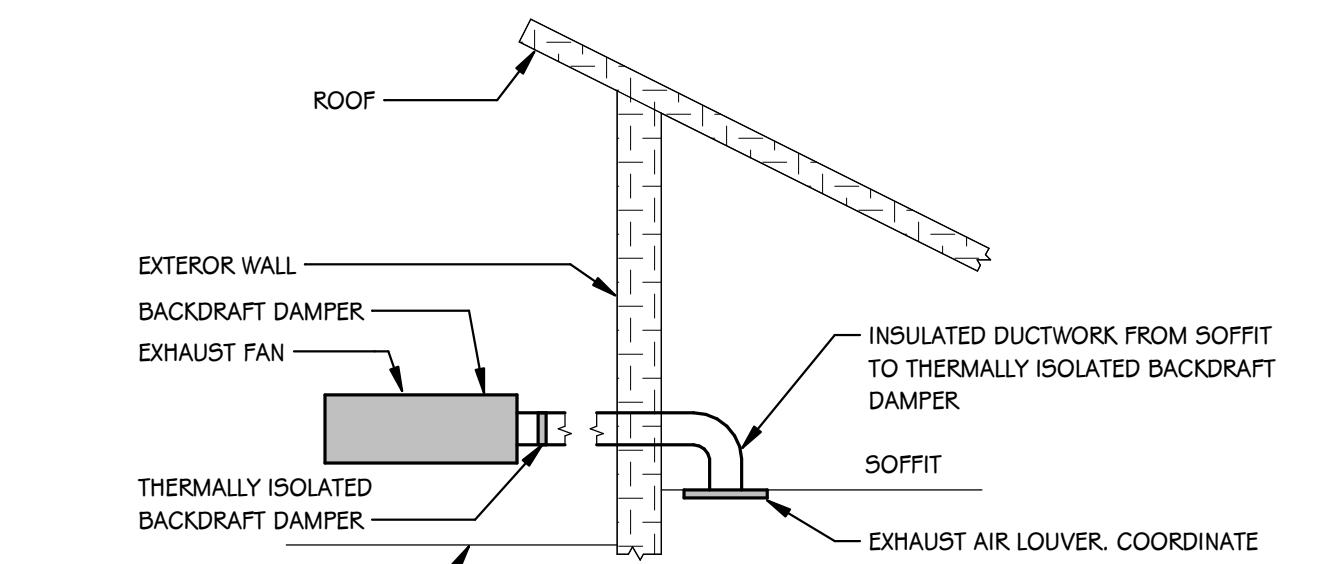SCALE: NONE


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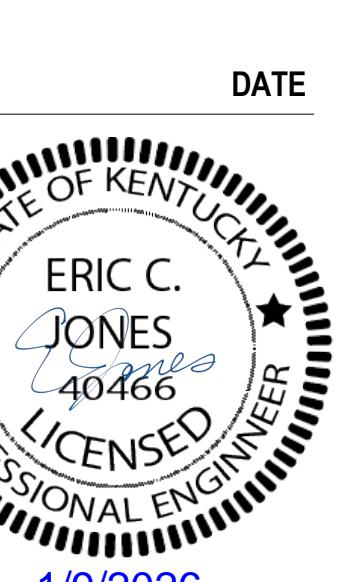
CEILING MOUNTED SUPPLY DIFFUSER DETAIL - TYPICAL



DUCTWORK FITTING DETAILS - ROUND/oval

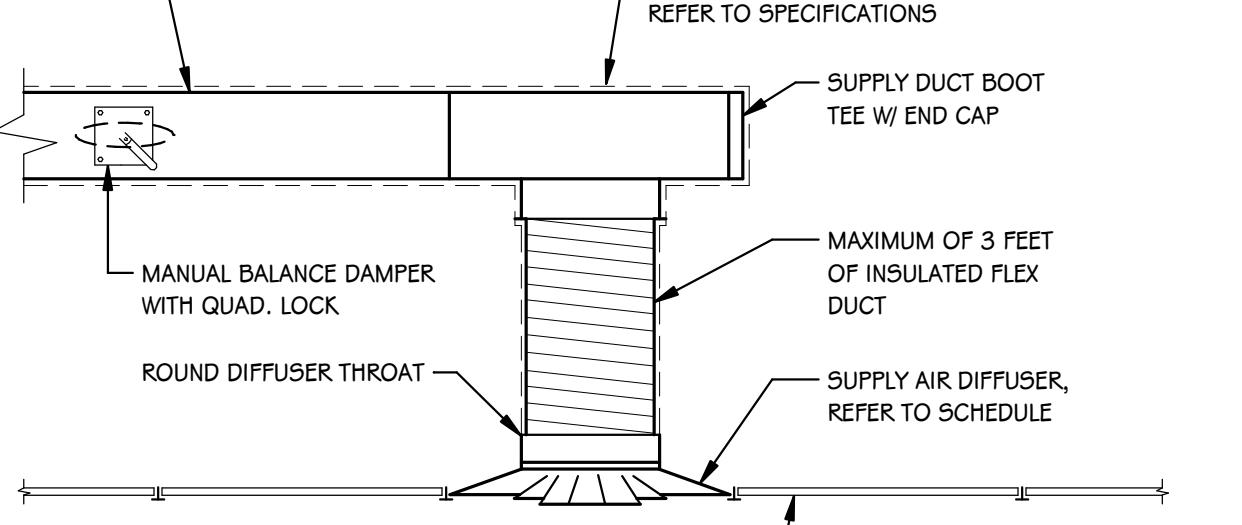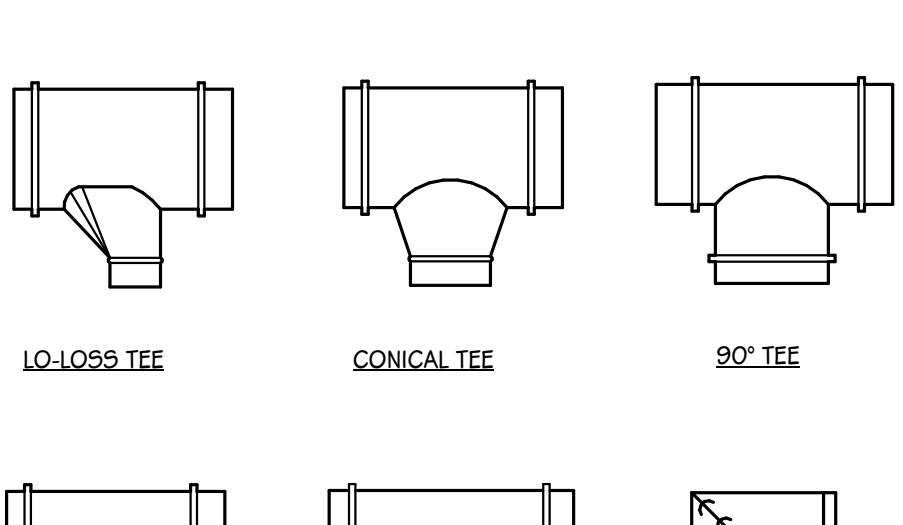

TAKEOFF DETAIL - RECTANGULAR TO ROUND

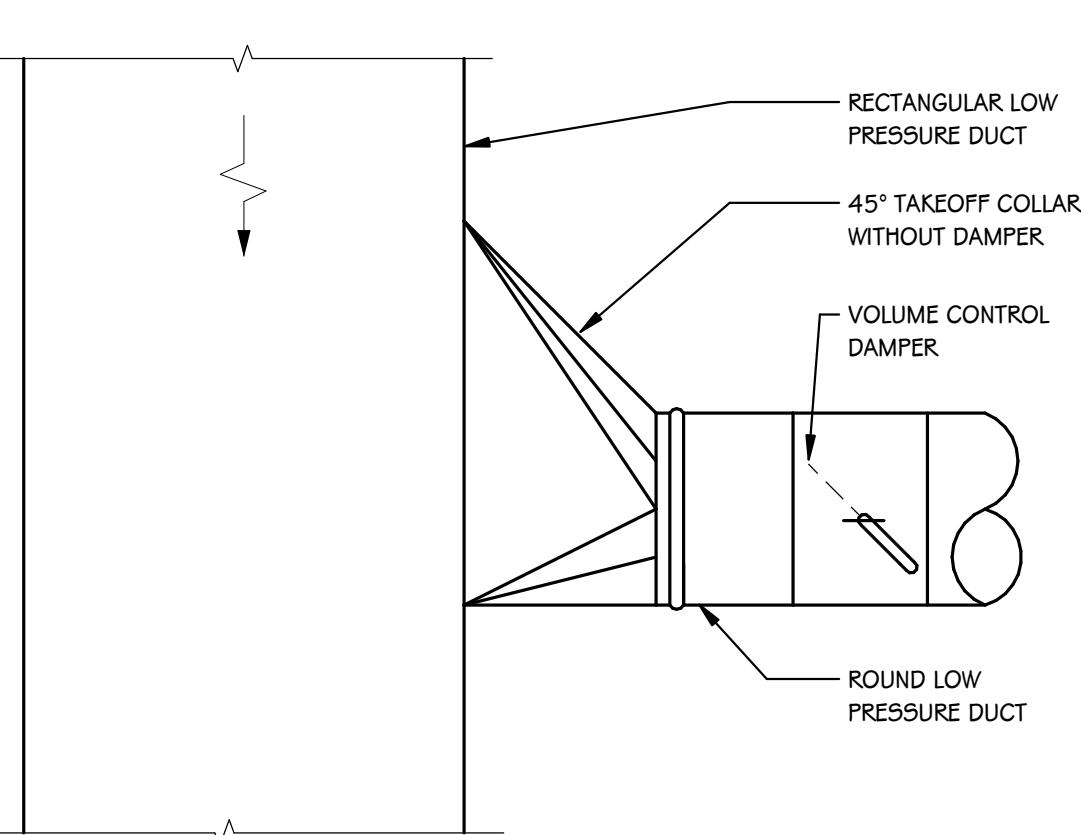

OWNER
TEAMSTERS LOCAL 2727
Shepardsville, Kentucky

PROJECT TITLE
TEAMSTERS LOCAL 2727 BUILDING
ADDITION

SHEET NUMBER
EG 001
NOTES

DATE
JANUARY 9, 2026

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10/20/2025 14:23:13 AM

PAGE NUMBER
25-376.000

STRUCTURED CABLING	MOUNTING HEIGHTS	LIGHTING SYMBOLS	MOUNTING HEIGHTS	POWER SYMBOLS	MOUNTING HEIGHTS	GENERAL NOTES - ELECTRICAL - LIGHTING
DATA VOICE OUTLET		S SINGLE POLE SWITCH	40"	Electric Meter		1 ALL OCCUPANCY SENSORS AND PHOTOCELLS MOUNTED IN THE SAME ROOM SHALL BE CONCEALED WITHIN THE CONDUIT OR CONDUIT SYSTEM. DAYLIGHT HAVING SENSORS SHALL BE SELF CONTAINED WITHIN EACH ROOM AND SHALL BE FIELD ADJUSTED WITH ENGINEER. MANUFACTURER SHALL PROVIDE FLOOR PLANS DURING SHOP DRAWING PHASE SHOWING EXACT LOCATIONS AND QUANTITIES AS REQUIRED FOR A COMPLETE SYSTEM.
DATA VOICE OUTLET - SURFACE		Sos OCCUPANCY SENSOR (SET TO VACANCY MODE) - SWITCH MOUNTED	40"	Surge Protection Device		2 ALL OCCUPANCY SENSOR WIRING SHALL BE CONCEALED WITHIN CONDUIT WHERE EXPOSED. NO LOW VOLTAGE WIRING SHALL BE EXPOSED.
DATA VOICE OUTLET - ABOVE BACKSPLASH		Low Voltage Control Switch, REFER TO DETAIL	40"	Multi Channel Meter		3 ALL CONDUITS SHALL RUN AS TIGHT AS DECK AS PERMITTED BY CODE. CONDUITS SHALL BE RUN IN A NEAT MANNER. MAINTAIN THE SAME SPACING WHEN CONDUITS ARE RUN TOGETHER. CONCEAL JUNCTION BOXES OVER LAY-IN CEILING AND USE EMT DROPS DOWN TO CLOUDS. LOCATE CONDUIT DROPS TO CLOUDS AND CEILING ELEMENTS IN LEAST VISIBLE LOCATION. NO MC-CABLE TO LIGHT FIXTURES SHALL BE VISIBLE FROM ANY ANGLE.
SECURITY CONTROLS PATHWAY		S3 THREE-WAY SWITCH	40"	Motor Control Center	90" TO TOP	4 RECESS NEW DEVICES AND ASSOCIATED CONDUIT AND BACKBOX IN EXISTING WALL. CUT AND PATCH AS REQUIRED.
WIRELESS ACCESS POINT		S4 KEY OPERATED, SINGLE POLE SWITCH	40"	Panelboard	72" TO TOP	5 COORDINATE LIGHTING RUNS FOR LINEAR FIXTURES. ALL TRADES - NO PIPES, DUCTS, CONDUIT, CABLE TRAY OR ANY OTHER SYSTEMS SHALL BE ROUTED UNDER LIGHTS.
GROUNDING BUS BAR		S5 KEY OPERATED, THREE-WAY SWITCH	40"	Distribution Panelboard	72" TO TOP	GENERAL NOTES - ELECTRICAL - POWER
CABLE TRAY		S6 KEY OPERATED, FOUR-WAY SWITCH	40"	Electrical Equipment Connection - REFER TO CONNECTION SCHEDULES FOR FEEDER SIZE, BREAKERS, DISCONNECT MEANS ETC.		1 ELECTRICAL CONTRACTOR SHALL BE RESPONSIBLE FOR ALL CUTTING AND PATCHING REQUIRED FOR NEW WORK OR WHERE DEVICES ARE REMOVED AND NOT REPLACED.
CLOCK		S7 DUAL SINGLE POLE SWITCH	40"	Temperature Control Panel	72" TO TOP	2 ELECTRICAL CONTRACTOR SHALL VERIFY VOLTAGE OF TRANSFORMER OR ANY MECHANICAL OR OTHER EQUIPMENT PRIOR TO ORDERING ELECTRICAL EQUIPMENT.
MASTER CLOCK PANEL		S8 OCCUPANCY SENSOR (SET TO VACANCY MODE) CEILING MOUNTED	40"	Disconnect Switch - UNUSED		3 ELECTRICAL CONTRACTOR SHALL COORDINATE WITH DEVICE ALIGNMENT GUIDELINES. DEVICES ARE TO ALIGN VERTICALLY AND HORIZONTALLY AND FOLLOW THE RULES OF THIS DETAIL CONSISTENTLY. A PRE-INSTALL DEVICE COORDINATION MEETING FOR DEVICE FINISHES AND LAYOUT MAY BE REQUIRED IN THE SPECIFICATION FOR THIS PROJECT.
PAGING SYSTEM HEAD END		WALL MTD. LIGHT FIXTURE		Disconnect Switch - FUSED		4 PATCH ALL PENETRATIONS AS REQUIRED TO MAINTAIN FIRE RATING.
NETWORK COMMUNICATION RACK		DOWNLIGHT FIXTURE - EMERGENCY, SWITCHABLE		Combination Disconnect/Magnetic Motor Starter		5 REFER TO INTERIOR ELEVATIONS, SECTIONS, ARCHITECTURAL ELEVATIONS AND RELATED DRAWINGS FOR EXACT DEVICE LOCATIONS AND MOUNTING HEIGHTS. WHERE DEVICES ARE MOUNTED UNDER OR ABOVE TACK BOARDS, DOORS, WINDOWS, OR ANY PIECE OF EQUIPMENT, THE ELECTRICAL DEVICE SHALL BE CENTERED AS SHOWN. COORDINATE LOCATION OF FURNITURE CONNECTIONS AND/OR RECEPTACLES AND DATA RACEWAYS WITH APPROVED FURNITURE SHOP DRAWINGS, FINAL CONNECTIONS TO FURNITURE BY ELECTRICAL CONTRACTOR.
4'x8'x3/4" FIRE-RATED PLYWOOD		RECTANGULAR LIGHT FIXTURE		Manual Motor Starter with Pilot Light	40"	6 ALL CONDUITS SHALL RUN AS NEAR TO DECK AS PERMITTED BY CODE. SOME CONDUITS WILL BE EXPOSED AND SHALL BE RUN IN A NEAT MANNER. MAINTAIN THE SAME SPACING WHEN CONDUITS ARE RUN TOGETHER. CONCEAL JUNCTION BOXES OVER LAY-IN CEILING AND USE EMT DROPS DOWN TO CLOUDS. LOCATE CONDUIT DROPS TO CLOUDS AND CEILING ELEMENTS IN LEAST VISIBLE LOCATION.
CONDUIT SLEEVE		INDUSTRIAL LIGHT FIXTURE		Bussmann 150V fuses		7 WHEN CEILINGS ARE REMOVED ELECTRICAL CONTRACTOR SHALL PROPERLY SUPPORT ALL CONDUIT AND LOW VOLTAGE WIRING AS REQUIRED PER NEC.
AUDIO/VIDEO		EXIT SIGN - CEILING MOUNTED		VARIABLE FREQUENCY DRIVE		8 REMOVE CEILINGS AND GRID AS REQUIRED. REPLACE ANY DAMAGED CEILINGS.
TV WALL BACKBOX		EXIT SIGN - WALL MOUNTED		MOTOR - HP AS INDICATED		9 ALL KITCHEN RECEPTACLES, BATHROOM RECEPTACLES, OUTDOOR RECEPTACLES, OUTLETS WITHIN 6' OF SINK AND ANY OTHER REQUIRED BY 210.68 TO BE GFCI PROTECTED PER NEC REQUIREMENTS. PROVIDE REMOTE GFCI TESTING DEVICE FOR INACCESSIBLE GFCI DEVICES.
PROJECTOR (OUTLET WITHIN 16' OF PROJECTOR LOCATION)		EXTERIOR POLE LIGHT		FUSE		10 FLOORBOX AND POKE THROUGH POWER AND RACEWAY TO FEED BACK UP TO CEILING OF ROOM THAT FLOORBOX SERVES.
AV WALL STATION BOXES		EXTERIOR POLE LIGHT - POLE AND BASE PREPARED FOR CAMERA PER DETAIL		Circuit Breaker		11 PROVIDE FINAL CONNECTION TO ALL OWNER CONTRACTOR PROVIDED EQUIPMENT. COORDINATE RECEPTACLE SIZES AND TYPE WITH EQUIPMENT, ADJUST CIRCUIT SIZE AS REQUIRED.
TECHNOLOGY OR TEACHERS STATION BOXES		RECEPTACLE SYMBOLS		Circuit Breaker - Electronic Trip		12 CONNECT POWER TO ALL VAV, TERMINAL UNITS AND MISCELLANEOUS MECHANICAL DAMPERS AND VALVES PROVIDED WITH LOW VOLTAGE TRANSFORMERS. PROVIDE AT LEAST A CIRCUIT FOR EVERY 4 UNITS TO BE ON A TRANSFORMER. COORDINATE EXACT LOCATIONS AND TRANSFORMER QUANTITIES WITH BUILDING AUTOMATION SYSTEM AND MECHANICAL CONTRACTORS AND REFER TO MECHANICAL CONTROLS AND SEQUENCE OF OPERATIONS. PROVIDE FLOOR PLANS AND SHADINGS ON ELEVATIONS DRAWINGS. DO NOT USE SPARE BREAKERS INDICATED IN PLANS. SCHEDULES FOR THESE CIRCUITS, NOTIFY PANELBOARD MANUFACTURERS OF QUANTITIES OF THESE BREAKERS REQUIRED. ELECTRICAL CONTRACTOR IS RESPONSIBLE FOR POWERING EACH TRANSFORMER REGARDLESS OF QUANTITY OR LOCATION.
MICROPHONE JACK		DUPLEX RECEPTACLE	16"	SWITCH		13 CONNECT BAS CONTROL PANEL TO EMERGENCY CIRCUIT (IF AVAILABLE) AND COORDINATE BAS PANEL LOCATION WITH CONTROLS CONTRACTOR.
CEILING BOX		DUPLEX RECEPTACLE - 4" ABOVE COUNTER BACKSPLASH		POWER FACTOR CORRECTION CAPACITOR		14 ALL CONDUITS SHALL ENTER/EXIT THE BUILDING BELOW GRADE. PROVIDE TRENCHING AND DIRECTIONAL BORING AS REQUIRED. CUT AND PATCH AS REQUIRED. NO EXPOSED CONDUIT SHALL BE ALLOWED ON EXTERIOR OF BUILDING.
BLUETOOTH DEVICE		DUPLEX RECEPTACLE - WET LOCATION ENCLOSURE WITH GFI		COIL		15 RECESS NEW DEVICES AND ASSOCIATED CONDUIT AND BACKBOX IN EXISTING WALLS WHERE POSSIBLE. CUT AND PATCH AS REQUIRED.
ANTENNA		SIMPLEX RECEPTACLE	16"	INDICATOR LIGHT (R=RED, G=GREEN, B=BLUE, Y=WHITE, A=AMBER)		
PROJECTOR SCREEN		RECEPTACLES VARIATIONS - HEIGHT PER ABOVE UNLESS INDICATED ON DRAWINGS:		CURRENT TRANSFORMER		
LOUDSPEAKER CEILING MOUNTED		DOUBLE DUPLEX RECEPTACLE		TRANSFORMER		
LOUDSPEAKER WALL MOUNTED		DUPLEX RECEPTACLE - SURFACE MOUNTED #WMS00		SYSTEM GROUND - REFER TO SPECIFICATIONS		
VOLUME CONTROL		DUPLEX RECEPTACLE - EMERGENCY		PUSH-BUTTON STATION - 1 HOLE	40"	
SECURITY SYMBOLS		GFI DUPLEX RECEPTACLE - WITH GFI		PUSH-BUTTON STATION - 2 HOLE	40"	
SECURITY CAMERA		EWC DUPLEX RECEPTACLE - FOR ELECTRIC WATER COOLER, WITH GFI		PUSH-BUTTON STATION - 3 HOLE	40"	
SECURITY CAMERA		USB DUPLEX RECEPTACLE - WITH (2) USB OUTLETS BETWEEN POWER		EMERGENCY MUSHROOM HEAD PUSH-BUTTON STATION - 1 HOLE	40"	
CARD READER		H DUPLEX RECEPTACLE - HORIZONTAL MOUNTING		LIGHTING CONTACTOR		
ELECTRICAL ABBREVIATIONS		ST DUPLEX RECEPTACLE - STACK ALIGNED BELOW DEVICE ABOVE (DEVICE ALIGNMENT IS NOT LIMITED TO THOSE LABELED, REFER TO ELECTRICAL DEVICE ALIGNMENT GUIDELINES)		TIME CLOCK	72" TO TOP	
(#)		SPECIAL PURPOSE RECEPTACLE	16"	JUNCTION BOX - SIZE AND TYPE AS REQUIRED		
(E)		POWER/COMMUNICATION FLOOR BOX		FULL BOX - SIZE AND TYPE AS REQUIRED		
EXISTING		LEGEND EVOLUTION #RPAF-0G-GCTC2(COLORS-1-1/4°C DATA		FLUSH IN-GRADE HAND HOLE		
APC		HD HAND/MAIR DRYER		DOOR OPERATOR		
ABOVE FINISHED CEILING				NOTES:		
APCI				1 MOUNT DEVICES AT HEIGHTS INDICATED UNLESS INDICATED OTHERWISE ON PLANS. HEIGHTS ARE TO BOTTOM OF DEVICE.		
ABOVE FINISHED FLOOR						
AHU						
AUTHORITY HAVING JURISDICTION						
AIC						
AMPERE INTERRUPTING CAPACITY						
AL						
ALUMINUM						
AWG						
BAS						
BUILDING AUTOMATION SYSTEM						
BMS						
BUILDING MANAGEMENT SYSTEM						
C						
CONDUIT						
CT						
CURRENT TRANSFORMER						
CU						
COPPER						
DFA						
DROP FROM ABOVE						
DW						
DISHWASHER						
EM						
EMERGENCY						
ET						
ELECTRONIC TRIP						
EWC						
ELECTRIC WATER COOLER						
FDS						
FUSIBLE DISCONNECT SWITCH						
GAP						
GENERATOR ANNUNCIATOR PANEL						
GD						
GARBAGE DISPOSAL						
GEC						
GROUNDING ELECTRODE CONDUCTOR						
GFCI						
GROUND FAULT CIRCUIT INTERRUPTER, 5mA						
GFP						
GROUND FAULT PROTECTION OF EQUIPMENT, 30mA						
GND						
GROUND						
IAW						
IN ACCORDANCE WITH						
IC						
INSULATION CONTACT						
IDF						
INTERMEDIATE DISTRIBUTION FRAME						
JB						
JUNCTION BOX						
KCMIL						
THOUSANDS OF CIRCULAR MILS						
LCP						
LIGHTING CONTROL PANEL						
MDF						
MAIN DISTRIBUTION FRAME						
NFDS						
NON-FUSIBLE DISCONNECT SWITCH						
NIC						
NOT IN CONTRACT						
NL						
NIGHT LIGHT						
NTS						
NOT TO SCALE						
OC						
ON CENTER						
PB						
PULL BOX						
REF						
REFRIGERATOR						
RT						
RAINTIGHT						
SPD						
SURGE PROTECTIVE DEVICE						
TR						
TAMPER RESISTANT						
TTB						
TELECOMMUNICATIONS TERMINAL BOARD						
TX						
TRANSFORMER						
Typical						
ULSE						
UL SERVICE ENTRANCE RATED						
UON						
UNLESS OTHERWISE NOTED						
VIF						
VERIFY IN FIELD						
WP						
WEATHERPROOF						

SHEET TITLE
ELECTRICAL SYMBOLS AND GENERAL
NOTES

EG 001
NOTES


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PROJECT TITLE: TEAMSTERS LOCAL 2727 BUILDING
ADDITION

OWNER: TEAMSTERS LOCAL 2727
Shepardsville, Kentucky

SHEET TITLE: ELECTRICAL DEMOLITION PLAN -
ADDITION
SHEET NUMBER: ED 101A
DATE: JANUARY 9, 2026
25-376.000

KEYED NOTES - ELECTRICAL - DEMOLITION	
1	REMOVE ALL ELECTRICAL CIRCUITS, CONNECTIONS, AND CONDUITS BACK TO SOURCE. UPDATE PANEL SCHEDULES AND LABEL CIRCUITS THAT WERE USED AS SPARES.
2	SALVAGE LIGHT FIXTURE FOR REUSE.

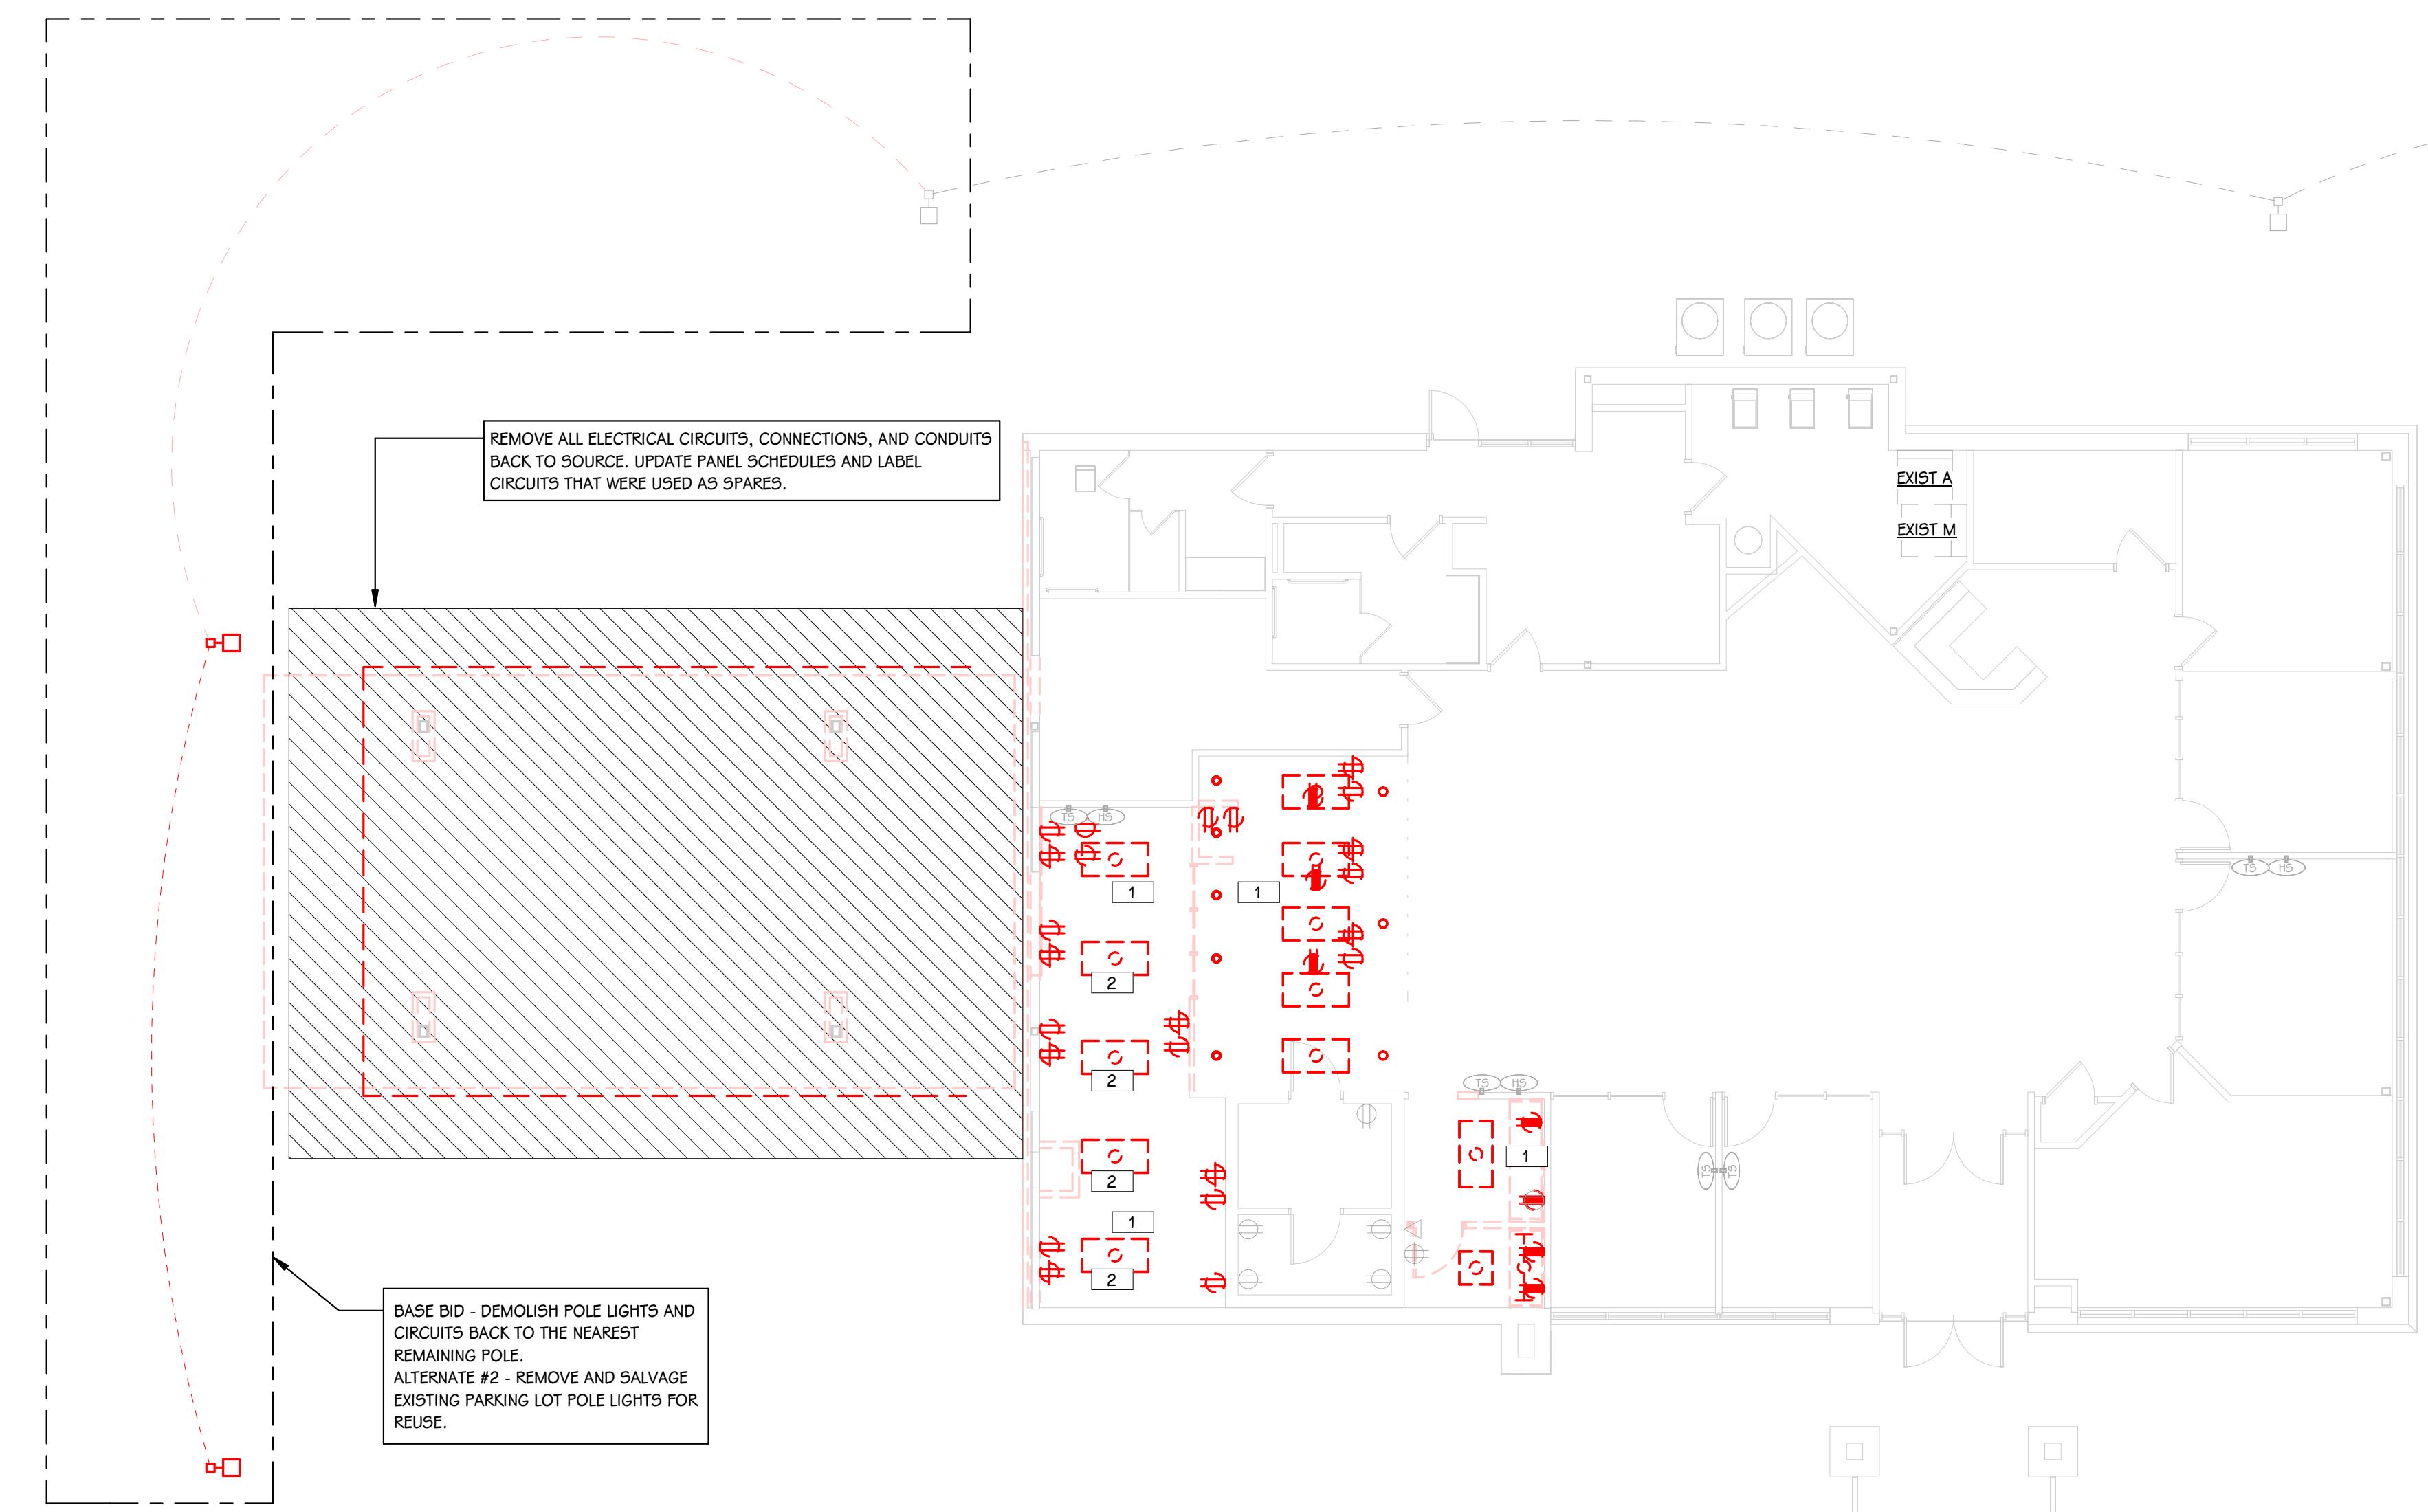

ELECTRICAL DEMOLITION PLAN - ADDITION



1/8" = 1'-0"

THIS DRAWING SHEET IS INTENDED TO BE PLOTTED IN COLOR. IF THIS TEXT APPEARS IN BLACK AND WHITE, IT IS PLOTTED INCORRECTLY. DISCARD AND OBTAIN AN ACCURATE DRAWING

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STATE OF KENTUCKY
ERIC C. JONES
40165
LICENSED
PROFESSIONAL ENGINEER
1/9/2026


PROJECT TITLE
TEAMSTERS LOCAL 2727 BUILDING
ADDITION

OWNER
TEAMSTERS LOCAL 2727
Shepardsville, Kentucky

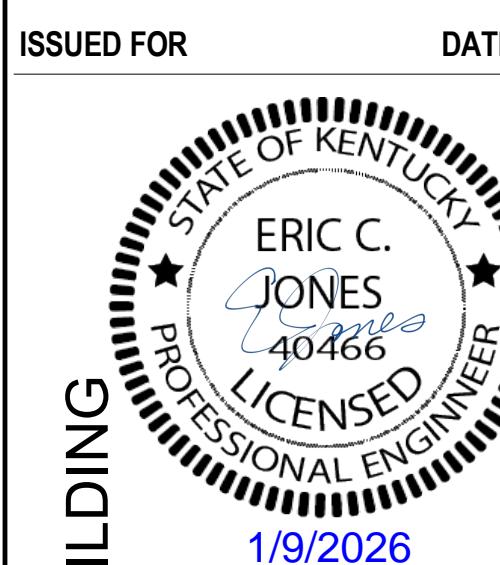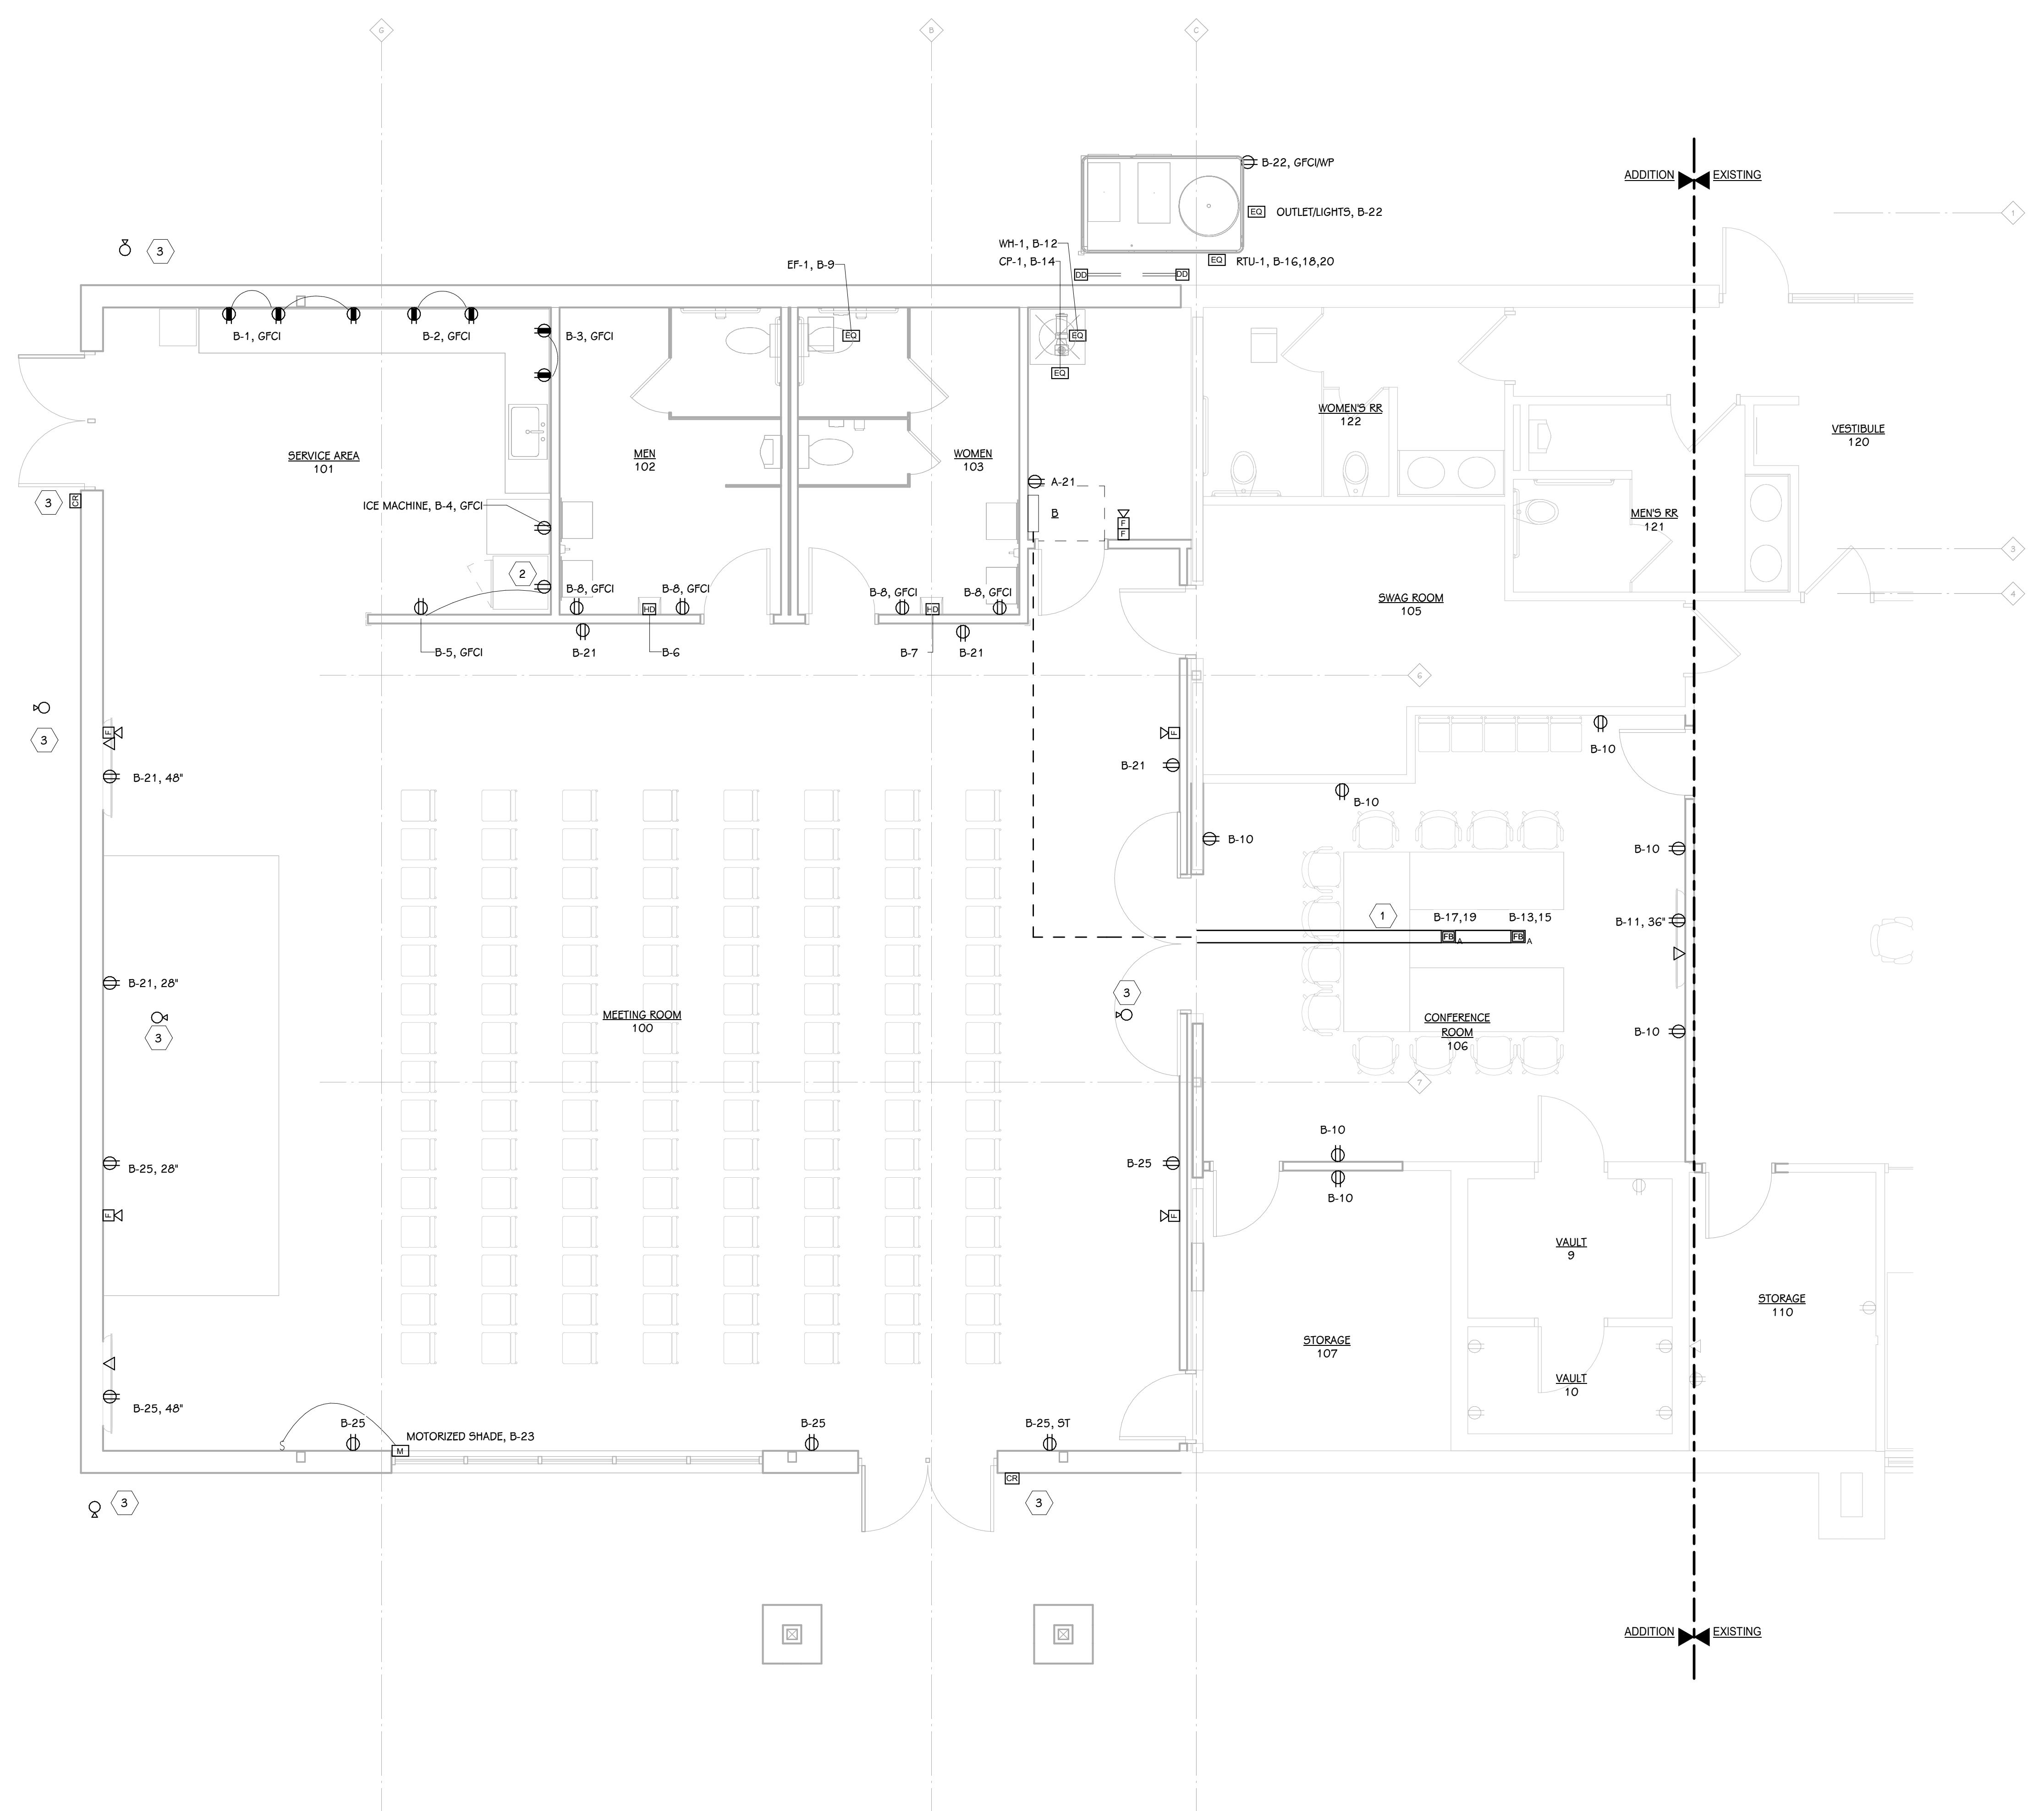SHEET TITLE
POWER PLAN - ADDITION
E 101A
25-376.000

DATE
JANUARY 9, 2026


POWER PLAN - ADDITION
1/4" = 1'-0"

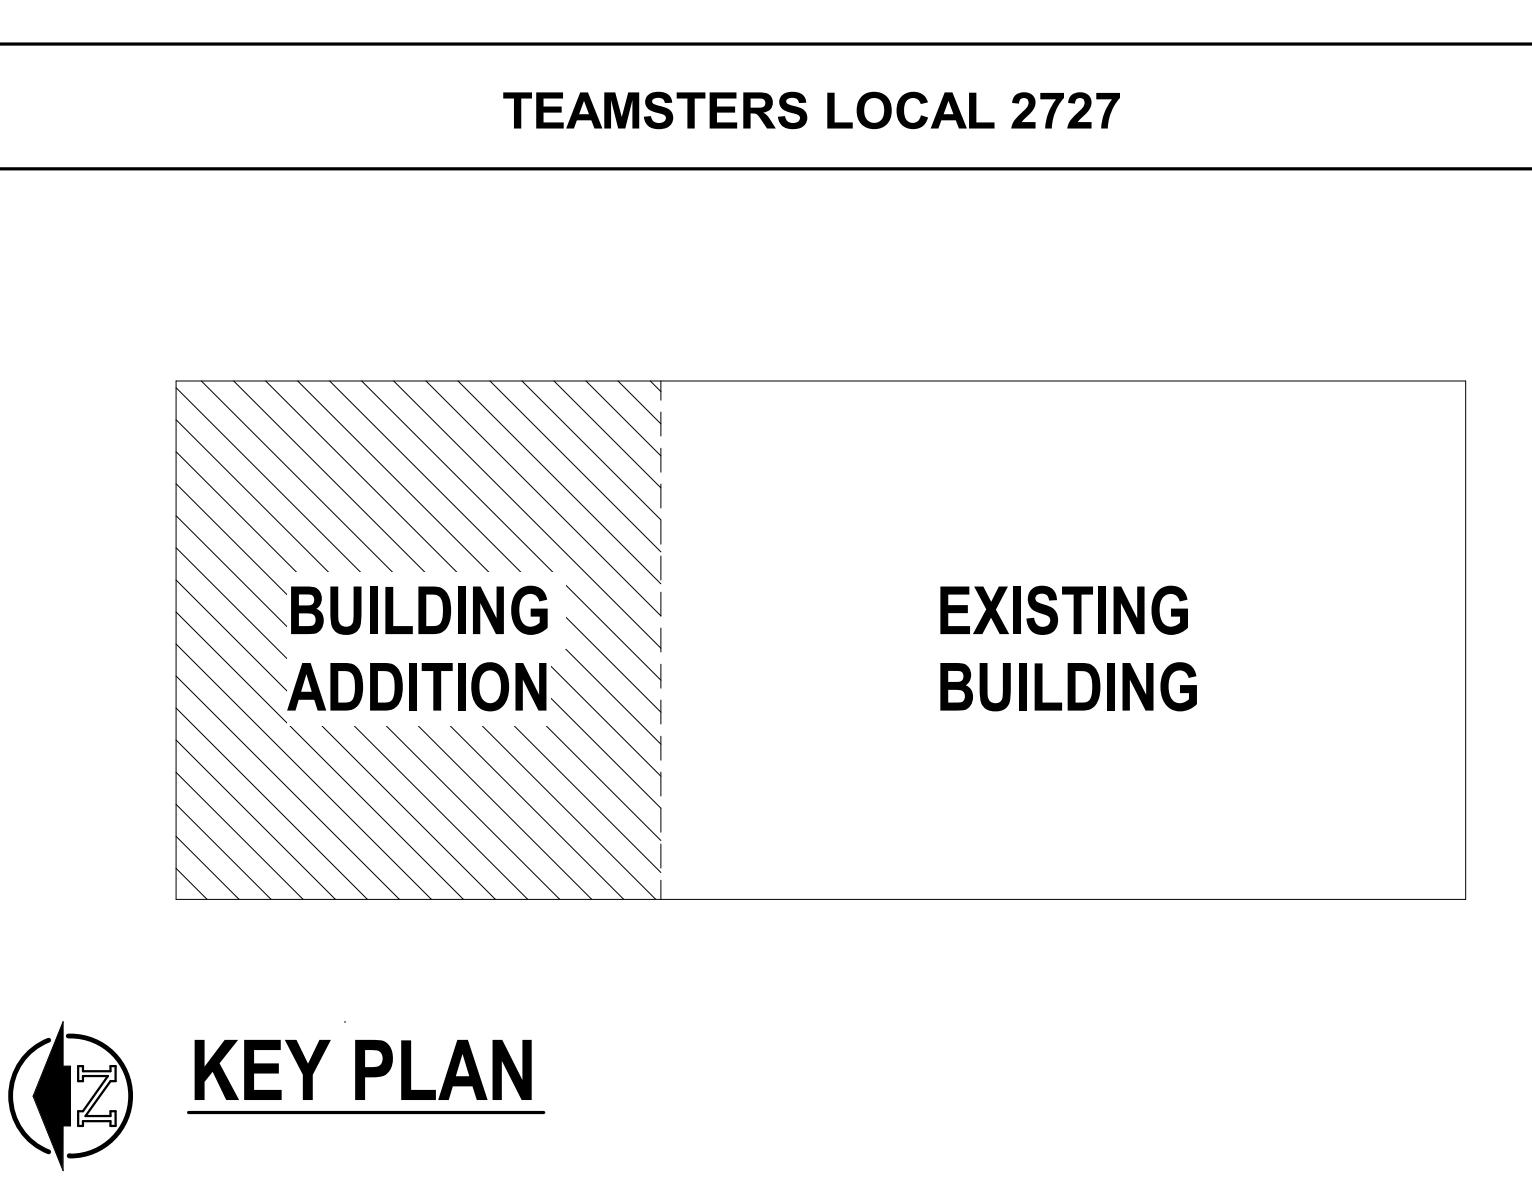

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 LIGHTING PLAN - ADDITION
1/4" = 1'-0"

TEAMSTERS LOCAL 2727

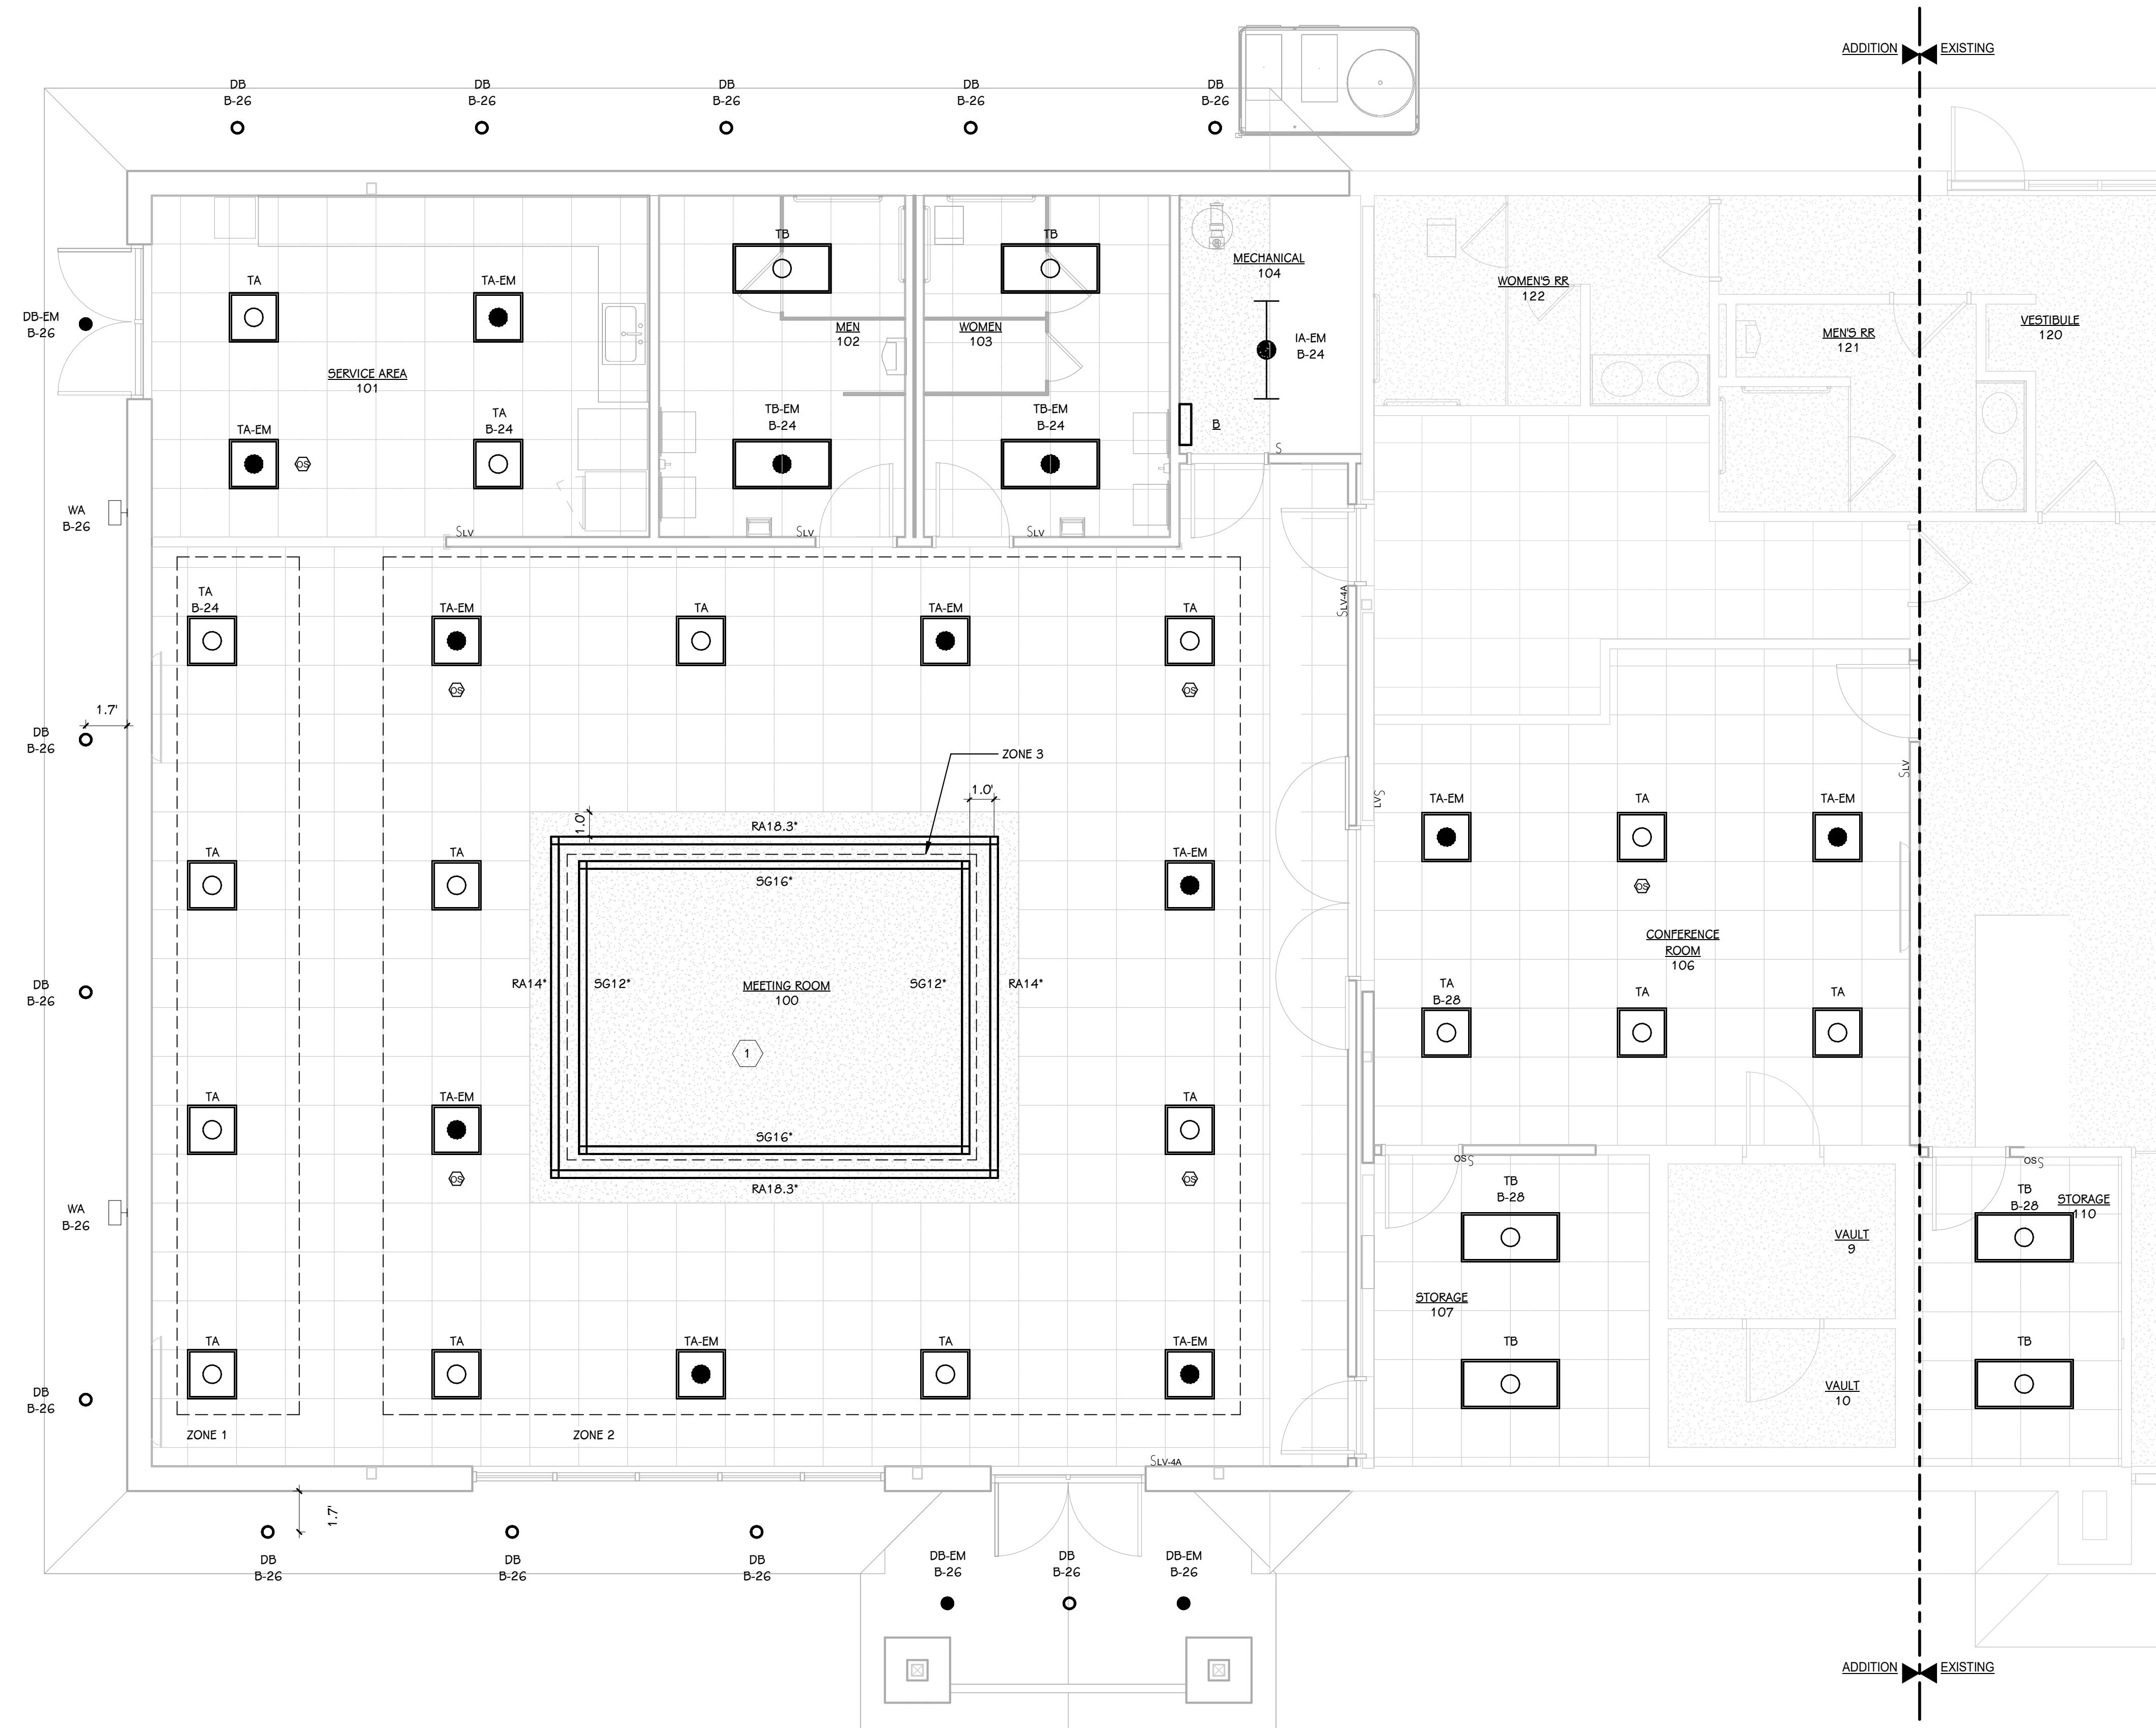

 KEY PLAN

SHEET TITLE LIGHTING PLAN - ADDITION
E 201A
25-376.000

OWNER TEAMSTERS LOCAL 2727
Shepardsville, Kentucky

PROJECT TITLE TEAMSTERS LOCAL 2727 BUILDING
ADDITION
ERIC C. JONES
40466
LICENSED PROFESSIONAL ENGINEER
1/9/2026



DATE JANUARY 9, 2026

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OVERALL FIRST FLOOR FIRE ALARM PLAN

1/4" = 1'-0"

KEYED NOTES - ELECTRICAL - POWER	
1	SCAN SLAB WITH GROUND PENETRATING RADAR (GPR) AND SAW CUT / FLOOR CORE PRIOR TO INSTALLATION. COORDINATE FINAL LOCATION WITH DIMENSIONED FURNITURE PLANS PRIOR TO SAW CUTTING FLOOR OR INSTALLING FLOOR BOX.
2	RECEPTACLES FED FROM LOAD SIDE OF GFCI RECEPTACLE
3	SECURITY DEVICE SHOWN FOR REFERENCE. VERIFY WITH OWNER FOR EXACT DETAILS AND FINAL LOCATION.


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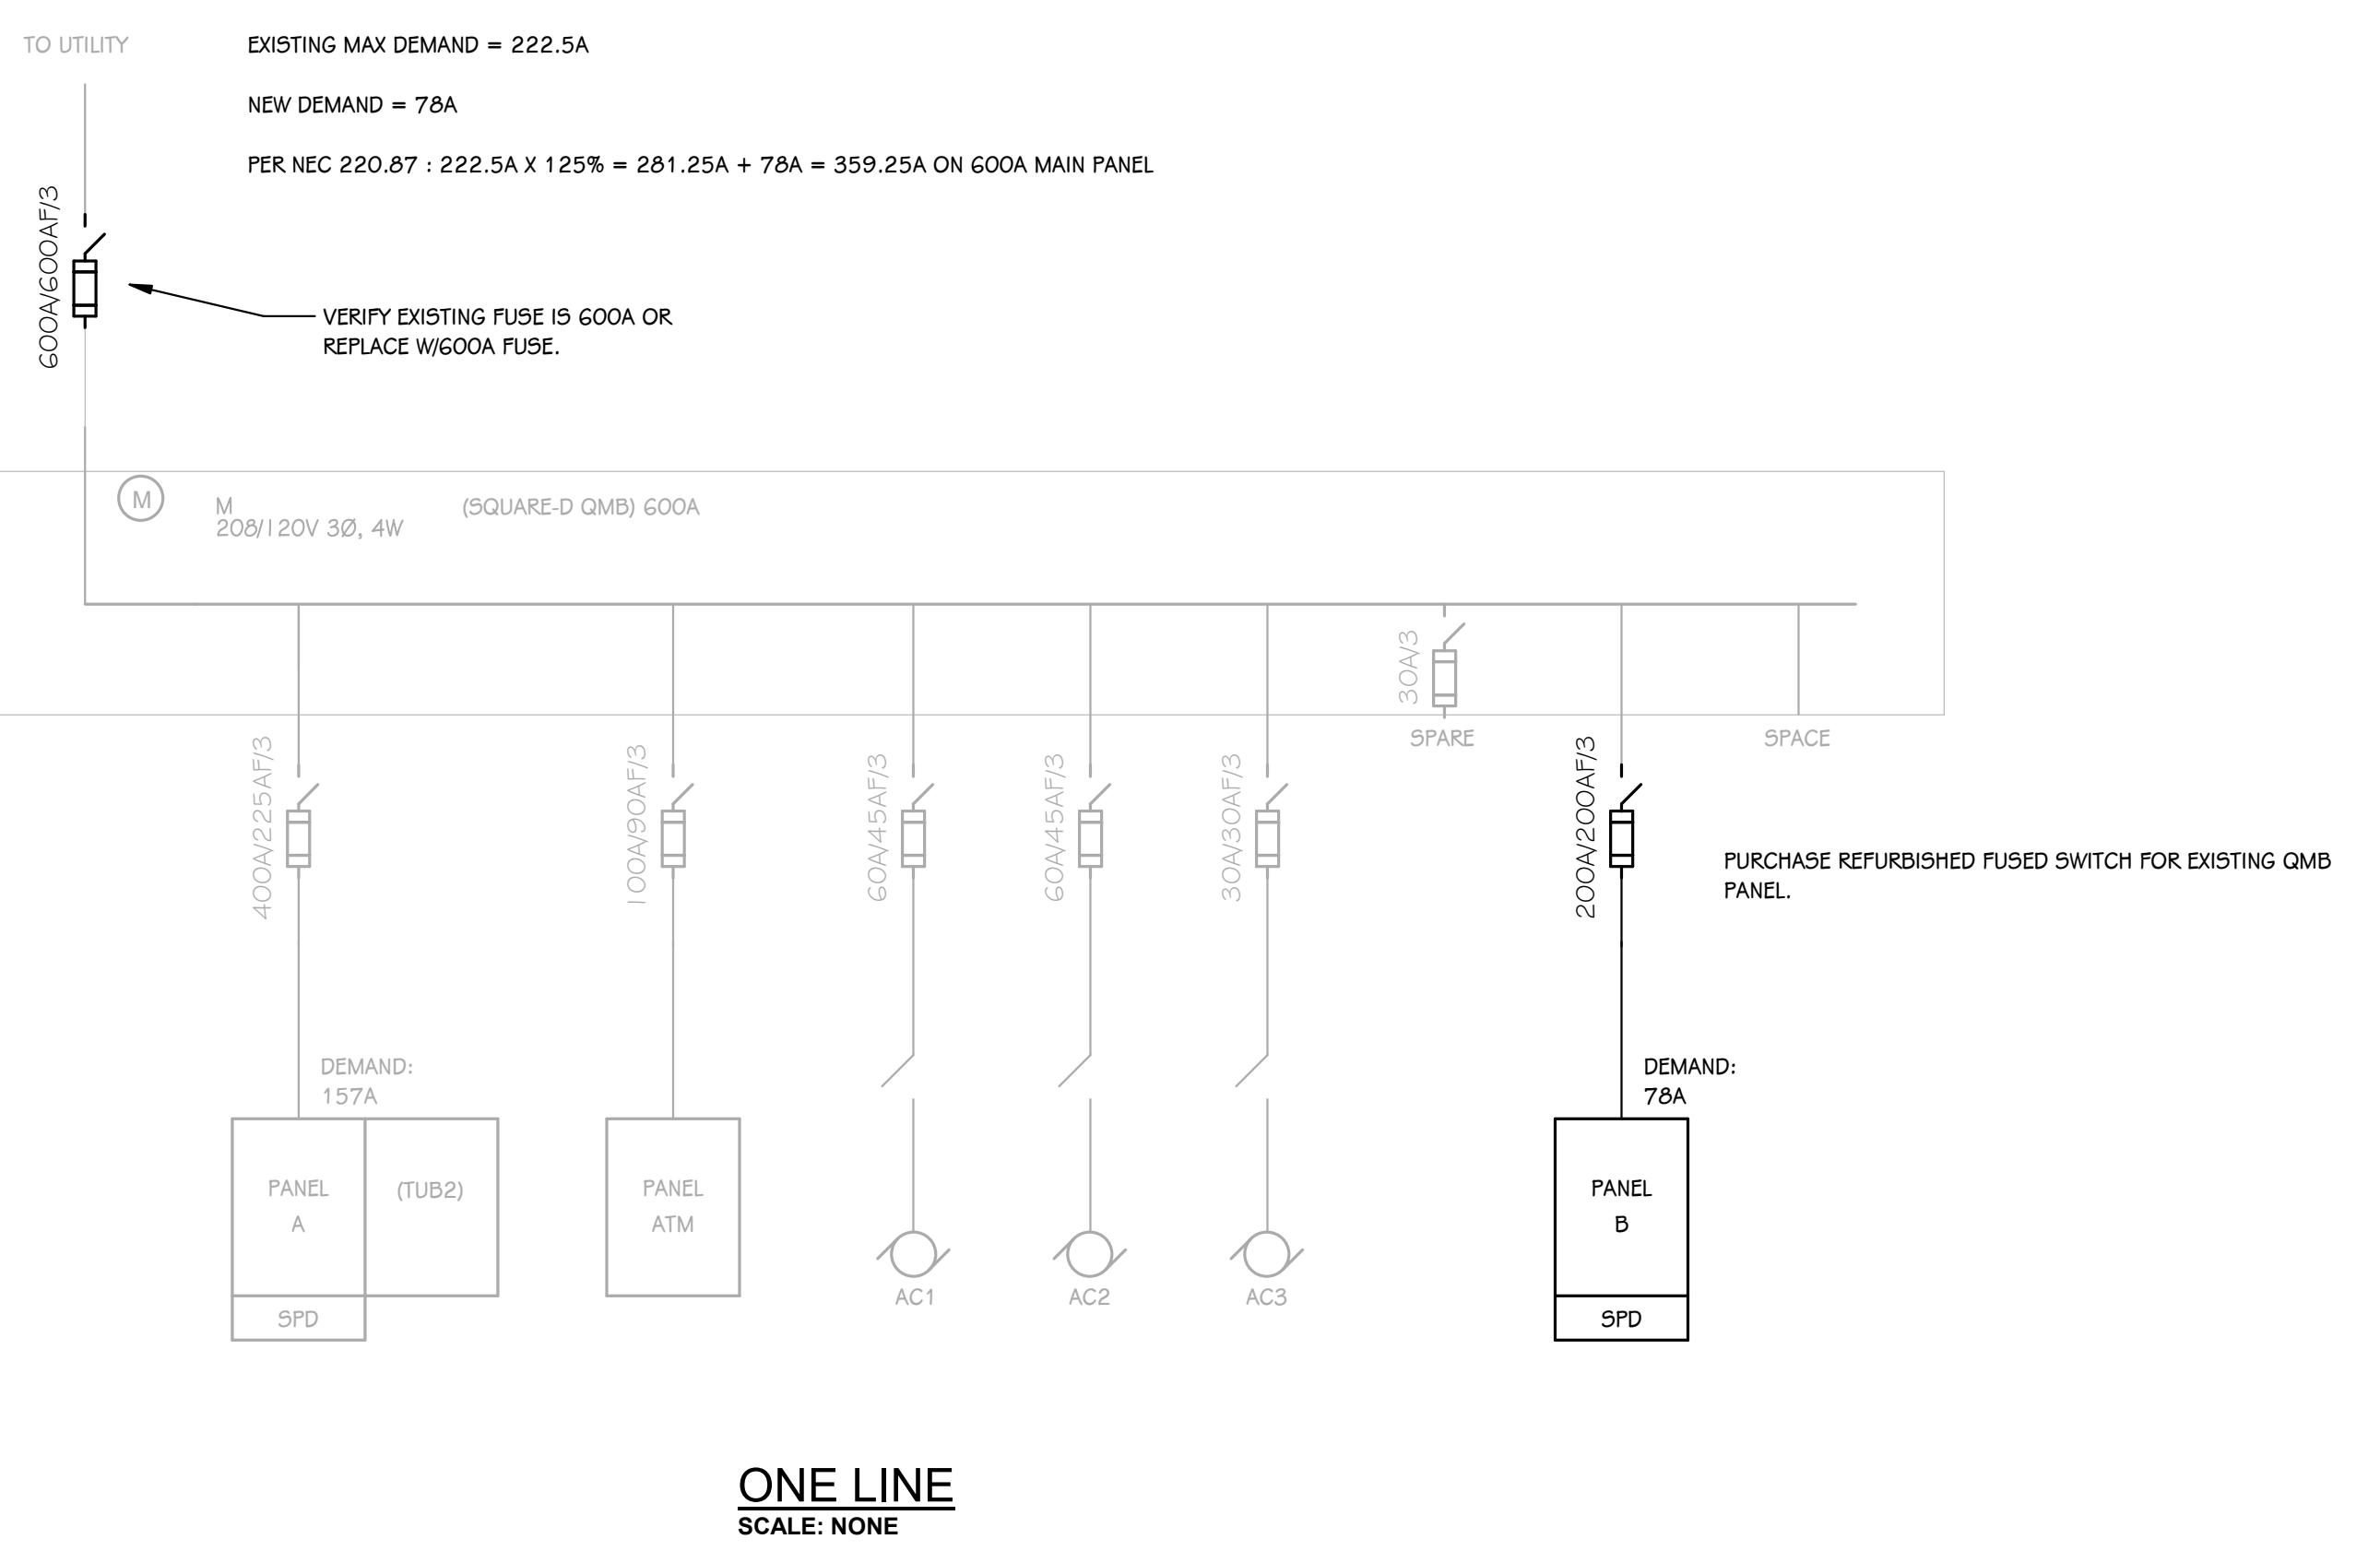
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Shepardsville, Kentucky

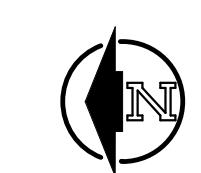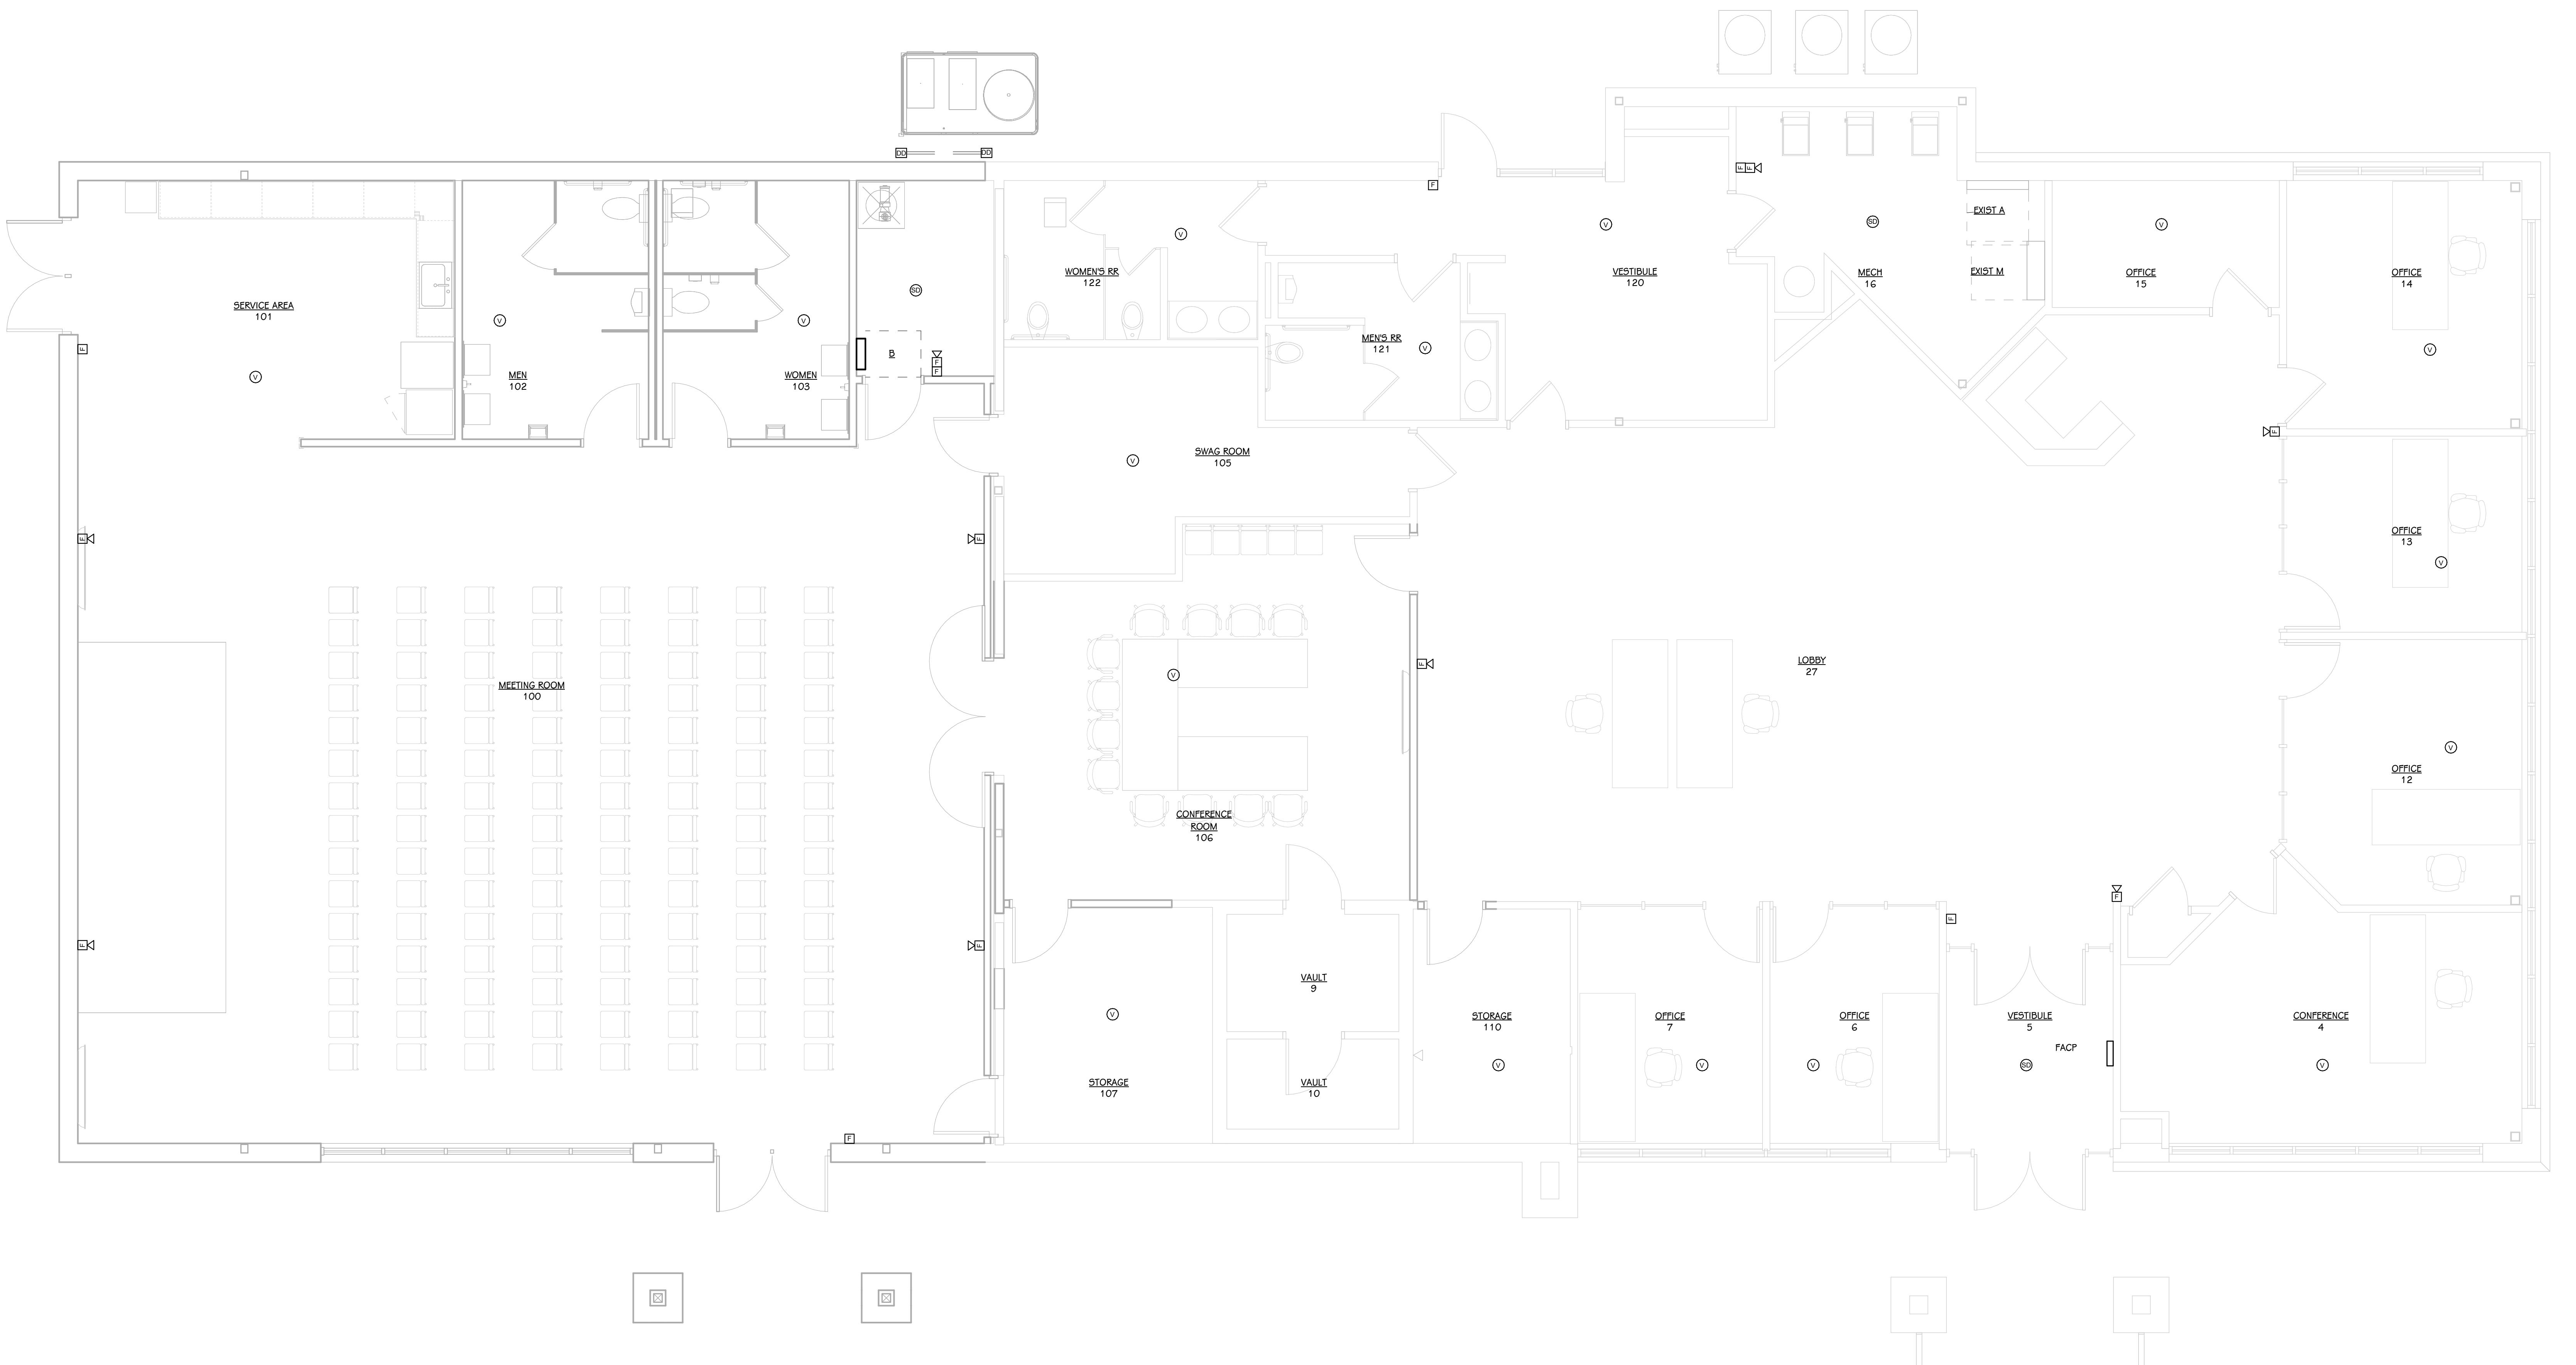SHEET TITLE
OVERALL FIRE ALARM PLAN
E 301
25-376.000

DATE
JANUARY 9, 2026

25-376.000



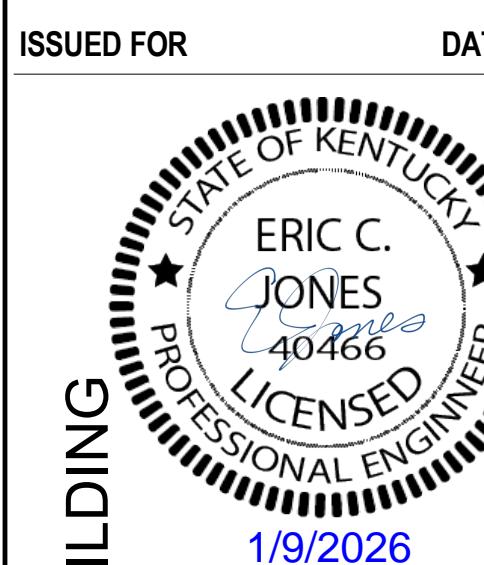

PANEL: B		LOCATION: MECHANICAL 104 / Level 1		MOUNTING: SURFACE		VOLTAGE: 208/120V, 3PH, 4W				
				AMPS: 225 A MLO		FED FROM: M				
				FEED-THRU LUGS... No		A.I.C. VALUE: 9438 A				
							(PROVIDE 25% HIGHER A.I.C. RATING)			
CIRCUIT DESCRIPTION										
1	RECEPTACLE - SERVICE AREA 101 NW WALL	20	1	540	360	1	20			
3	RECEPTACLE - SERVICE AREA 101 E WALL	20	1		360	180	1			
5	RECEPTACLE - SERVICE AREA 101 F FRIDGE	20	1			360	900			
7	POWER - WOMEN 103 HAND DRYER	20	1	900	720	1	20			
9	HVAC - EF-1	20	1		180	1260	1			
11	RECEPTACLE - CONFERENCE ROOM 106 TV	20	1			180	2500			
13	RECEPTACLE - CONFERENCE ROOM 106...	20	2	500	120	1	30			
15	--	--	--		500	4119	3			
17	RECEPTACLE - CONFERENCE ROOM 106...	20	2			500	4119			
19	--	--	--	500	4119	--	--			
21	RECEPTACLE - CONFERENCE ROOM 100	20	1		900	180	1			
23	POWER - MOTOR SHADE	20	1			144	1615			
25	RECEPTACLE - MEETING ROOM 100	20	1	1080	338	1	20			
27	FACP	20	1		500	410	1			
29	SPARE	20	1	0	0	0	20			
31	SPARE	20	1	0	0	0	20			
33	SPARE	20	1		0	0	20			
35	SPACE	--	1		--	--	1			
37	SPD	30	3	0	--	1	--			
39	--	--	--	0	--	1	--			
41	--	--	--	0	--	1	--			
TOTAL LOAD:		9177 VA	8589 VA	10318 VA						
ADDITIONAL FEED THRU LUGS LOAD (IF APPLICABLE):		0 VA	0 VA	0 VA						
TOTAL AMPS:		77 A	72 A	87 A						
LOAD CLASSIFICATION										
HVAC -		CONNECTED LOAD	DEMAND FACTOR	ESTIMATED DEMAND	PANEL TOTALS					
HVAC -		15157 VA	100.00%	15157 VA						
LIGHTING -		2363 VA	100.00%	2363 VA	TOTAL CONNECTED LOAD: 28084 VA					
Other		500 VA	100.00%	500 VA	TOTAL ESTIMATED DEMAND: 28084 VA					
POWER -		1944 VA	100.00%	1944 VA	TOTAL CONNECTED LOAD (A): 78 A					
RECEPTACLE -		8120 VA	100.00%	8120 VA	TOTAL ESTIMATED DEMAND... 78 A					
NOTES:										
PROVIDE SPD BREAKER PER ONE LINE SCHEDULE. RECEPTACLE DEMAND FACTOR = FIRST 10KVA X 100% + 50% OF REMAINDER. AIC RATING IS CALCULATED VALUE, PROVIDE IC RATING AT LEAST 25% HIGHER AS PER SPECIFICATIONS.										

ELECTRICAL HVAC FEEDER SCHEDULE											
DESCRIPTION	FED FROM	DISCONNECT MEANS	CURRENT (FLA)	DEMAND (FLA)	BREAKER/POL	FEEDER	WIRE	GROUND	EMT	ACCUM VOLT	ACCUM VOLT
					# OF SETS					DROP %	NOTES
208 V	B	NEMA 3R 60A PDS	34 A	34 A	50 A/3	1 SET	4 #6	#6 GND.	1"	1.5%	
120 V											
HVAC - RTU-1	B	NON-FUSED	1 A	1 A	20 A/1	1 SET	2 #12	#12 GND.	3/4"	1.4%	
HVAC - CP-1	B	PROVIDED BY DIV 23	2 A	2 A	20 A/1	1 SET	2 #12	#12 GND.	3/4"	1.5%	
HVAC - EF-1	B	NEMA 3R 30A PDS	21 A	21 A	30 A/1	1 SET	2 #10	#10 GND.	3/4"	3.1%	

NOTES:
GENERAL: CONDUIT SIZES BASED ON EMT AND COPPER CONDUCTORS UNLESS OTHERWISE NOTED. UPSIZE AS REQUIRED WHERE PVC OR GALVANIZED IS USED OR REQUIRED PER SPECIFICATIONS.
1. PROVIDE DRY CONTACT FROM GENERATOR ATS TO ELEVATOR CONTROLLER TO INDICATE GENERATOR RUNNING ON EMERGENCY POWER.
2. PROVIDE RAINIGHT DISCONNECT AT EQUIPMENT ON ROOF AND REMOTE STARTER IN ELECTRICAL ROOM.
3. PROVIDE CONNECTION TO ROOF TOP EQUIPMENT AND INTERCONNECT BETWEEN OUTSIDE UNIT AND INTERIOR UNIT. REFER TO MANUFACTURER'S INSTALLATION INSTRUCTIONS. PROVIDE RAINIGHT DISCONNECT ON EXTERIOR UNIT.
4. PROVIDE COPPER CONDUCTORS ONLY FOR CHILLER, ALUMINUM CONDUCTORS ARE NOT ACCEPTABLE FOR USE WITH CHILLER CONNECTIONS. DO NOT INCLUDE CHILLER FEEDS IN ANY ALUMINUM FEEDER ALTERNATES (VOLUNTARY OR ON DRAWINGS).

ELECTRICAL PANEL FEEDER SCHEDULE											
DESCRIPTION	FED FROM	CURRENT (FLA)	DEMAND (FLA)	FEEDER	WIRE	GROUND	EMT	ACCUM VOLT	ACCUM VOLT	DROP %	NOTES
					# OF SETS						
208 V	B	M	78 A	77 A	200 A / 3	1 SET	4 #30	#6 GND.	2 1/2"	0.7%	1

NOTES:
GENERAL: CONDUIT SIZES BASED ON EMT. UPSIZE AS REQUIRED WHERE PVC OR GALVANIZED IS USED OR REQUIRED PER SPECIFICATIONS.
1. CONDUIT SIZES BASED ON EMT AND COPPER CONDUCTORS (UNLESS OTHERWISE INDICATED WITH AN "AL" FOR ALUMINUM). UPSIZE AS REQUIRED WHERE PVC OR GALVANIZED IS USED OR REQUIRED PER SPECIFICATIONS.
2. G.E.C. = GROUNDING ELECTRODE CONDUCTOR FOR SEPARATELY DERIVED SYSTEM (PER SET, USE EQUIVALENT CMIL AND GEC FROM 250.66)
3. GND. = EQUIPMENT GROUNDING CONDUCTOR (E.G.C.)

<u>LIGHT FIXTURE TYPE NAME NOMENCLATURE:</u>	
<u>Fixture Style</u>	<u>Ceiling Type</u>
TROFFER (2X4, 2X2)	I D DRYWALL (GYP BOARD)
RECESSED LINEAR	R G GRID CEILING (LAY-IN)
RECESSED DOWNLIGHT (CAN)	C O OPEN EXPOSED CEILING
LINEAR PENDANT	L W WOOD CEILING
WALL MOUNTED	W M METAL CEILING
PENDANT CYLINDER	PC
PENDANT DECORATIVE	PD

(RECESSED LINEAR 8' EXAMPLE) (RECESSED DOWNLIGHT IN WOOD CEILING EXAMPLE)

RA8*-EM
LP3A-9

R - FIXTURE STYLE
A - FIXTURE SERIES
8 - FIXTURE LENGTH OR DIAMETER
* - CUSTOM LENGTH
EM - EMERGENCY

CD-W-EM
LP3A-9

C - FIXTURE STYLE
A - FIXTURE SERIES
W - CEILING TYPE
EM - EMERGENCY

- PANEL/CIRCUIT NUMBER

- PANEL/CIRCUIT NUMBER

CUSTOM MULTI-SEGMENT LINEAR LIGHT FIXTURE NOMENCLATURE:

(RECESSED EXAMPLE)

RAB 8'-0"

4'-0" 4'-0"

RISE/DROP SEGMENT LENGTH
SEGMENT LENGTH

R - FIXTURE STYLE
A - FIXTURE SERIES
B - VARIATION OF FIXTURE SHAPES/LENGTH
SEGMENT LENGTH

Light Fixture Schedule									
Type	Series	Description	Mounting	Ceiling Type	Color Temp	Driver	Watts	Manufacturer	Notes
DB	DB	RECESSED DOWNLIGHT	RECESSED	METAL SYSTEM	4000K	0-10V	20 VA	GOTHAM: #EV06-40/20-AR-FL-LSS-MD-MVOLT-GZ10-XX-E10W	1, 2, 6
IA	IA	INDUSTRIAL PENDANT LINEAR, 4' - 0" LONG	CHAIN	EXPOSED DECK	4000K	0-10V	32 VA	LITHONIA: #CLX-LED-LINEAR-L48-5000LM-HEF-FDL-MVOLT-GZ10-40K-80CRI-E10W	1, 2, 6
RA14*	RA	RECESSED LINEAR, 13' - 11 3/4" LONG	RECESSED			0-10V	98 VA	FINELITE: #HP4-R-D-XX'-H-840-F-96LG-277-SC-FC-DALI-1%-C-FE-FB	1, 2, 3, 4, 6
RA18.3*	RA	RECESSED LINEAR, 18' - 3 3/4" LONG	RECESSED			0-10V	128 VA	FINELITE: #HP4-R-D-XX'-H-840-F-96LG-277-SC-FC-DALI-1%-C-FE-FB	1, 2, 3, 4, 6
SG12*	SG	SURFACE COVE LINEAR, 12' - 0" LONG	SURFACE			0-10V	32 VA	LUMENWERX : #ALC-APO-LED-90CRI-350-40-XX-120-D1-1-COVH-W	1, 2, 3, 4, 6
SG16*	SG	SURFACE COVE LINEAR, 16' - 0" LONG	SURFACE			0-10V	42 VA	LUMENWERX : #ALC-APO-LED-90CRI-350-40-XX-120-D1-1-COVH-W	1, 2, 3, 4, 6
TA	TA	RECESSED TROFFER, 2' - 0" LONG	RECESSED			0-10V	41 VA	LITHONIA #2BLT2-40L-ADP-MVOLT-GZ10-LP840-WH-E10W	1, 2
TA	TA	RECESSED TROFFER, 2' - 0" LONG	RECESSED	ACOUSTIC GRID	4000K	0-10V	41 VA	LITHONIA #2BLT2-40L-ADP-MVOLT-GZ10-LP840-WH-E10W	1, 2
TB	TB	RECESSED TROFFER, 4' - 0" LONG	RECESSED			0-10V	41 VA	LITHONIA #2BLT4-40L-ADP-MVOLT-GZ10-LP840-WH-E10W	1, 2
TB	TB	RECESSED TROFFER, 4' - 0" LONG	RECESSED	ACOUSTIC GRID	4000K	0-10V	41 VA	LITHONIA #2BLT4-40L-ADP-MVOLT-GZ10-LP840-WH-E10W	1, 2
WA	WA	LED WALL PACK	WALL	N/A	4000K	0-10V	21 VA	LITHONIA: #DSXW1 LED-P3-80CRI-T2M-MVOLT-SRM-DBLXD	1, 2

NO


- * FIELD COORDINATE AND FIELD MEASURE FOR CUSTOM LENGTH FIXTURES, LENGTHS PROVIDED ARE ROUNDED AND DEPEND ON FIELD CONDITIONS.
- 1 ALL LED FIXTURES TO HAVE WARRANTY TO MEET OR EXCEED WARRANTY INCLUDED IN BASIS OF DESIGN. FIXTURES LISTED AS EQUALS SHALL MEET DELIVERED LUMENS, CRI, EFFICACY AND OPTIONS OF THAT SPECIFIED. REFER TO SPECIFICATIONS 265100 AND 265600 FOR ADDITIONAL REQUIREMENTS.
- 2 THE MOUNTING DESCRIPTION IS GENERAL. REFER TO SHOP DRAWINGS AND MANUFACTURER'S INSTALLATION INSTRUCTIONS FOR SPECIFIC MOUNTING DETAILS.
- 3 ONLY SUBMIT ONE SET OF LINEAR FIXTURE INFORMATION PER FIXTURE SERIES WHERE VARIOUS LENGTH FIXTURES OF SAME SERIES ARE USED.
- 4 FIXTURE LENGTH PER LIGHTING FLOOR PLANS. FIELD VERIFY BEFORE ORDERING AND COORDINATE WITH FRAMING CONTRACTOR FOR HOLD DIMENSIONS.
- 5 EXIT SIGNS DIRECTIONAL ARROWS TO BE CONFIRMED ON PLANS PRIOR TO ORDERING. ARROWS ON GRAPHICS MAY NOT MATCH THOSE OF DESCRIPTION DUE TO FACE DIRECTION IN REFERENCE.
- 6 FIXTURES WITH THE CENTER CIRCLE SHADED AND/OR WITH TAG ENDING IN "-EM" SHALL HAVE A SELF-CONTAINED EMERGENCY BATTERY PACK OPERATING TWO LAMPS AT A MINIMUM OF 1100 LUMENS FOR 90 MINUTES. FIXTURES WITH THE CENTER CIRCLE COMPLETELY SHADED SHALL BE ON 24 HOURS. ON WIRE BATTERY AND BALLAST SO FIXTURE TURNS "ON" WHEN POWER FAILS.

LIGHTING & RECEPTACLE CONTROL SCHEDULE


ROOM #	ROOM NAME	AREA	ALLOWANCES (2019 ASHRAE)		ACTUAL LIGHTING POWER		IES 10 TARGET FC	OCCUPANCY SENSOR		MANUAL CONTROL		CONTROLLED RECEPTACLE
			LPD	WATTS	LPD	WATTS		AUTO ON	AUTO OFF	SWITCH REQUIRED	DIMMER	
110	STORAGE	107	0.38 W/ft ²	41 VA	0.76 W/ft ²	82 VA	10	-	100% AFTER 20 MINS	YES	WITHIN A DAYLIGHT ZONE	NO
102	MEN	141	0.63 W/ft ²	89 VA	0.58 W/ft ²	82 VA	15	100%	100% AFTER 20 MINS	YES	-	NO
103	WOMEN	141	0.63 W/ft ²	89 VA	0.58 W/ft ²	82 VA	15	100%	100% AFTER 20 MINS	YES	-	NO
107	STORAGE	143	0.38 W/ft ²	55 VA	0.57 W/ft ²	82 VA	10	-	100% AFTER 20 MINS	YES	WITHIN A DAYLIGHT ZONE	NO
104	MECHANICAL	78	0.43 W/ft ²	34 VA	0.41 W/ft ²	32 VA	20	-	-	YES	-	NO
101	SERVICE AREA	289	0.59 W/ft ²	171 VA	0.57 W/ft ²	164 VA	5	50%	100% AFTER 20 MINS	YES	WITHIN A DAYLIGHT ZONE	YES
100	MEETING ROOM	1864	0.97 W/ft ²	1808 VA	0.67 W/ft ²	1255 VA	30	50%	100% AFTER 20 MINS	YES	WITHIN A DAYLIGHT ZONE	YES
106	CONFERENCE ROOM	415	0.97 W/ft ²	403 VA	0.59 W/ft ²	246 VA	30	50%	100% AFTER 20 MINS	YES	WITHIN A DAYLIGHT ZONE	YES
Level 1		3179	2688 VA		2025 VA							
Grand total		3179	2688 VA		2025 VA							

N


PROVIDE (1) RELAY PACK PER CIRCUIT CONTAINING CONTROLLED RECEPTACLES. REFER TO POWER PLAN(S) FOR CIRCUIT QUANTITIES.

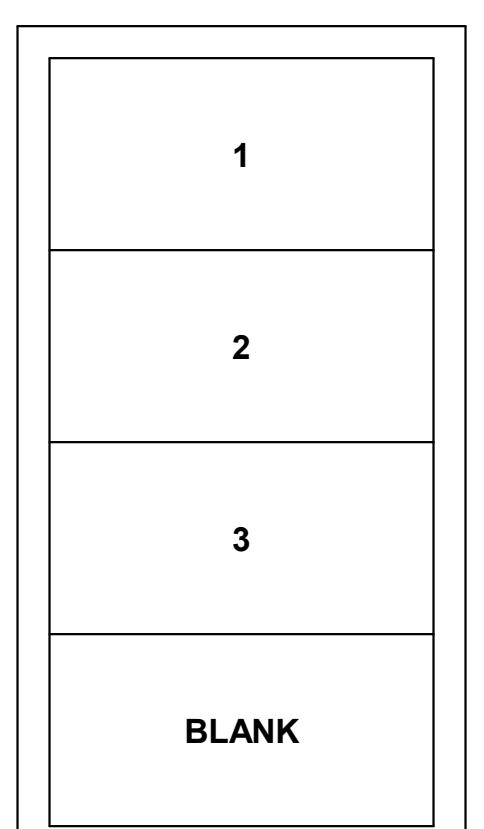

CONTROL LV-4B

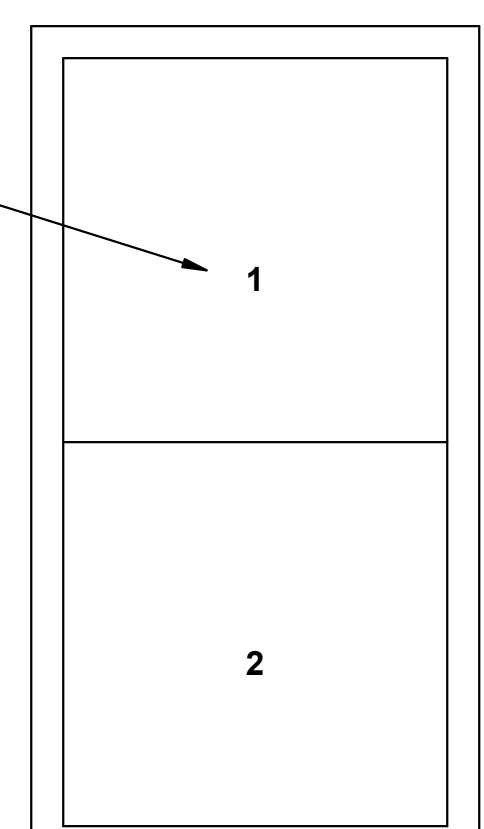


CONTROL LV-2A

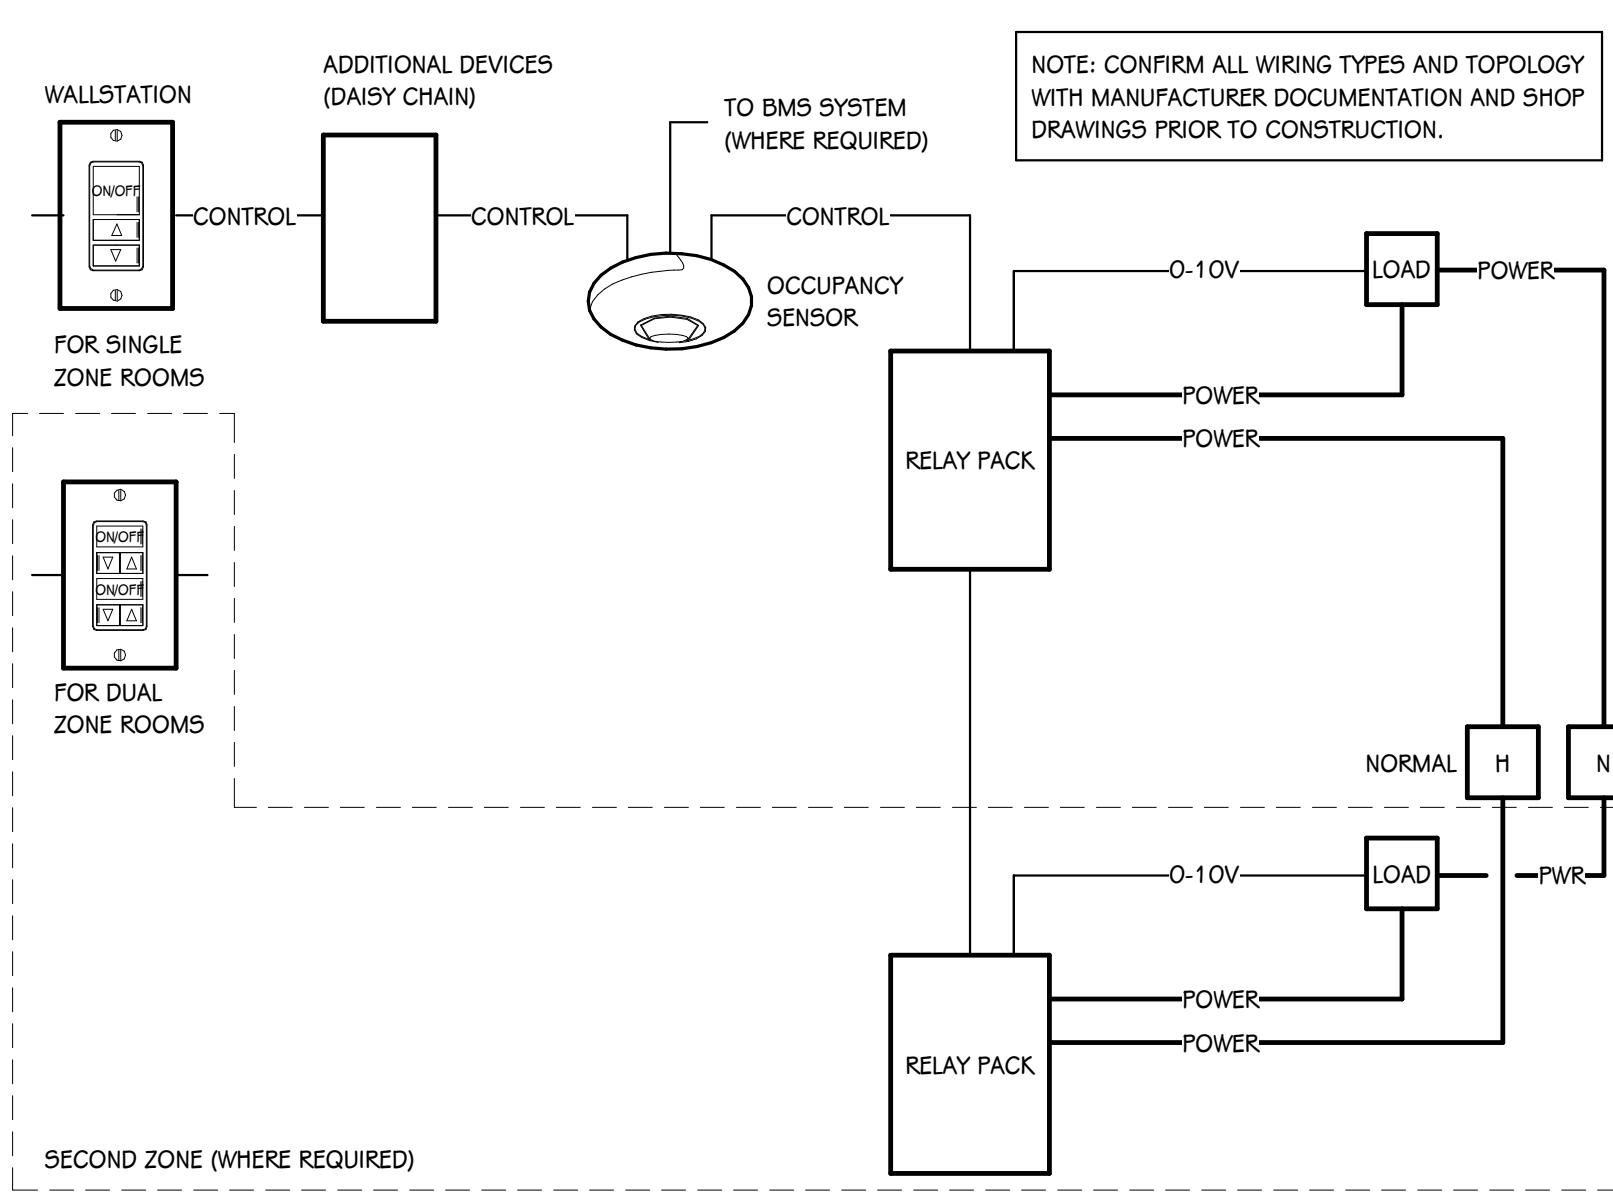


OCCUPANCY SENSOR WIRING DIAGRAM

SCALE: NONE

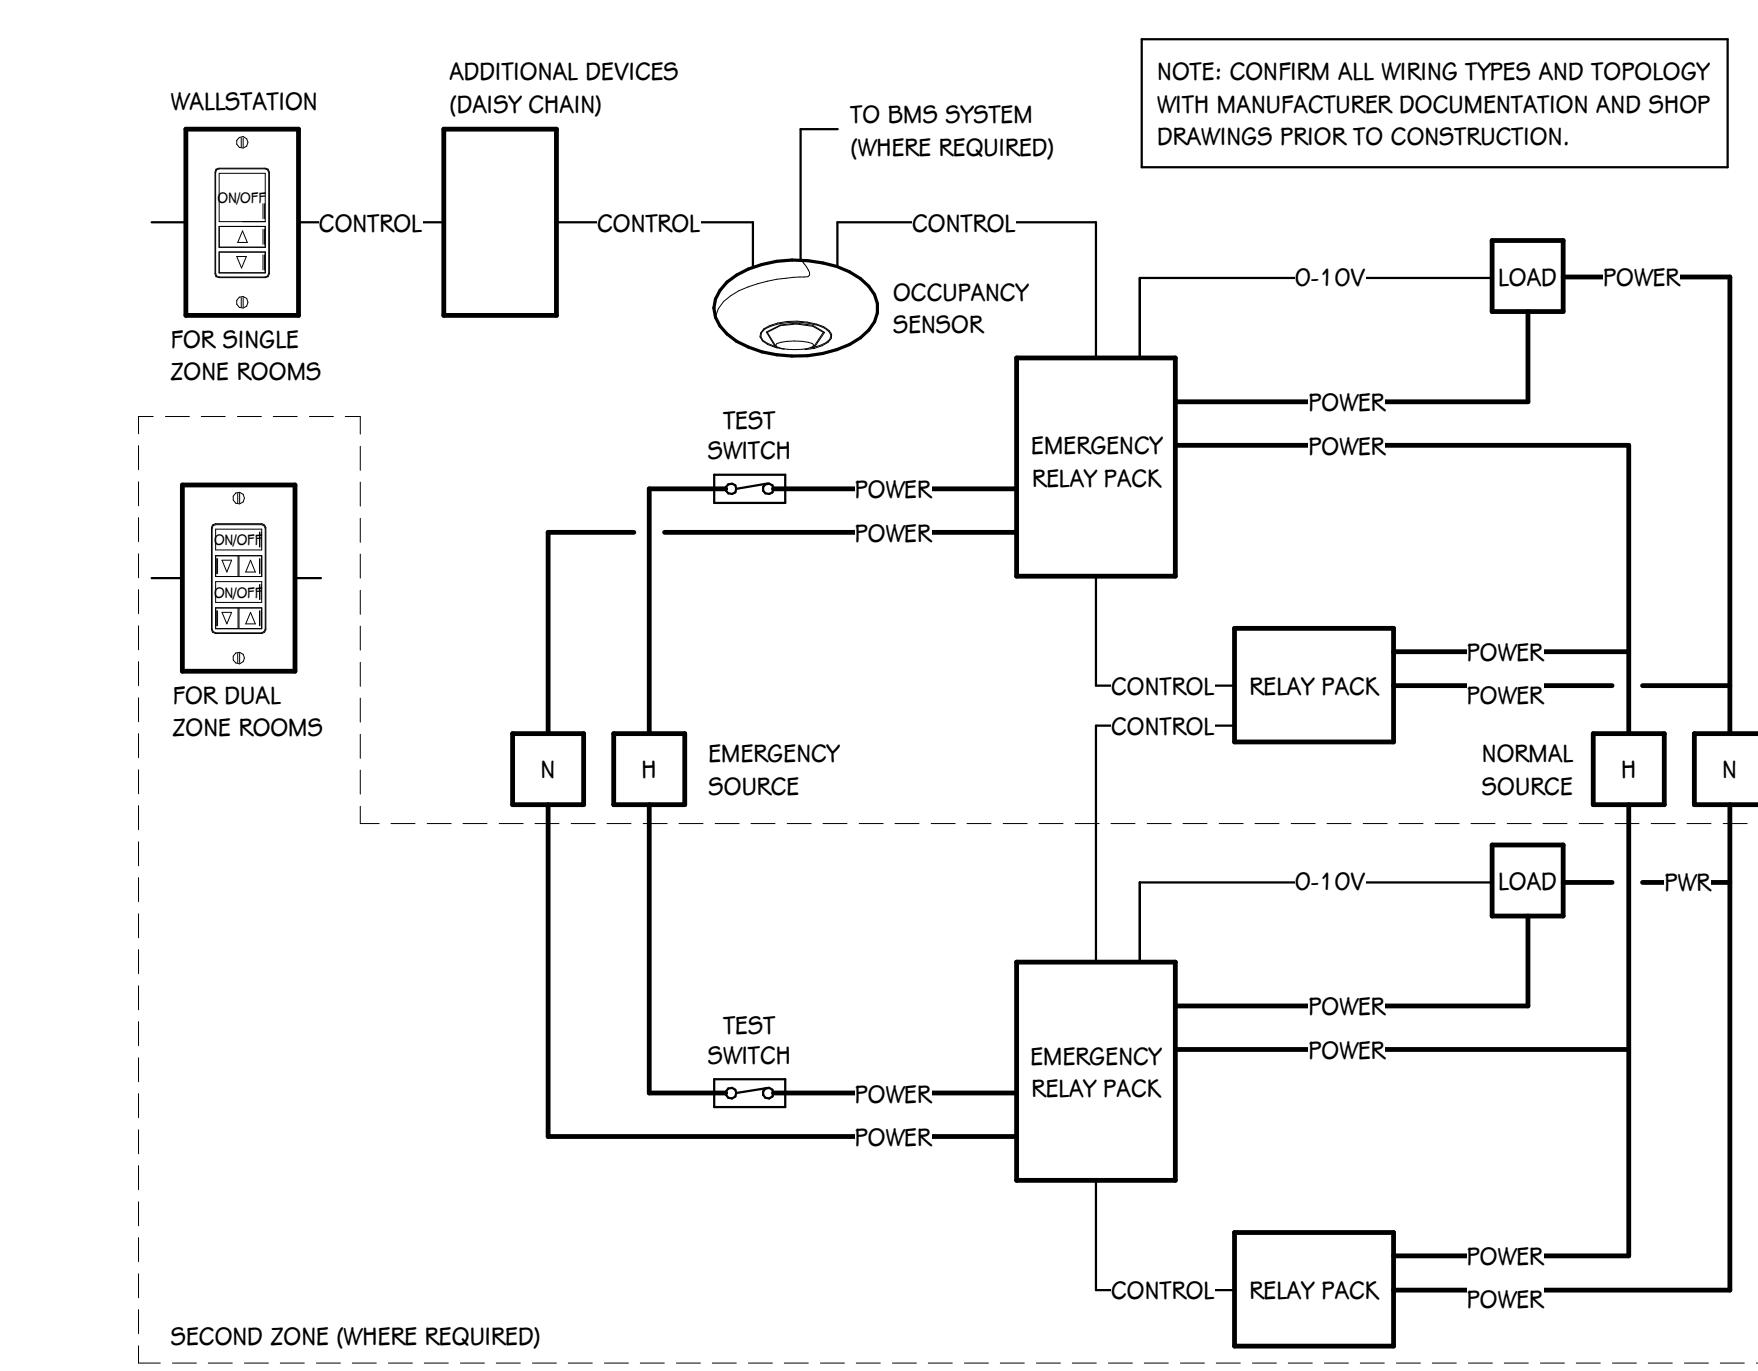

EMERGENCY OCCUPANCY SENSOR WIRING DIAGRAM

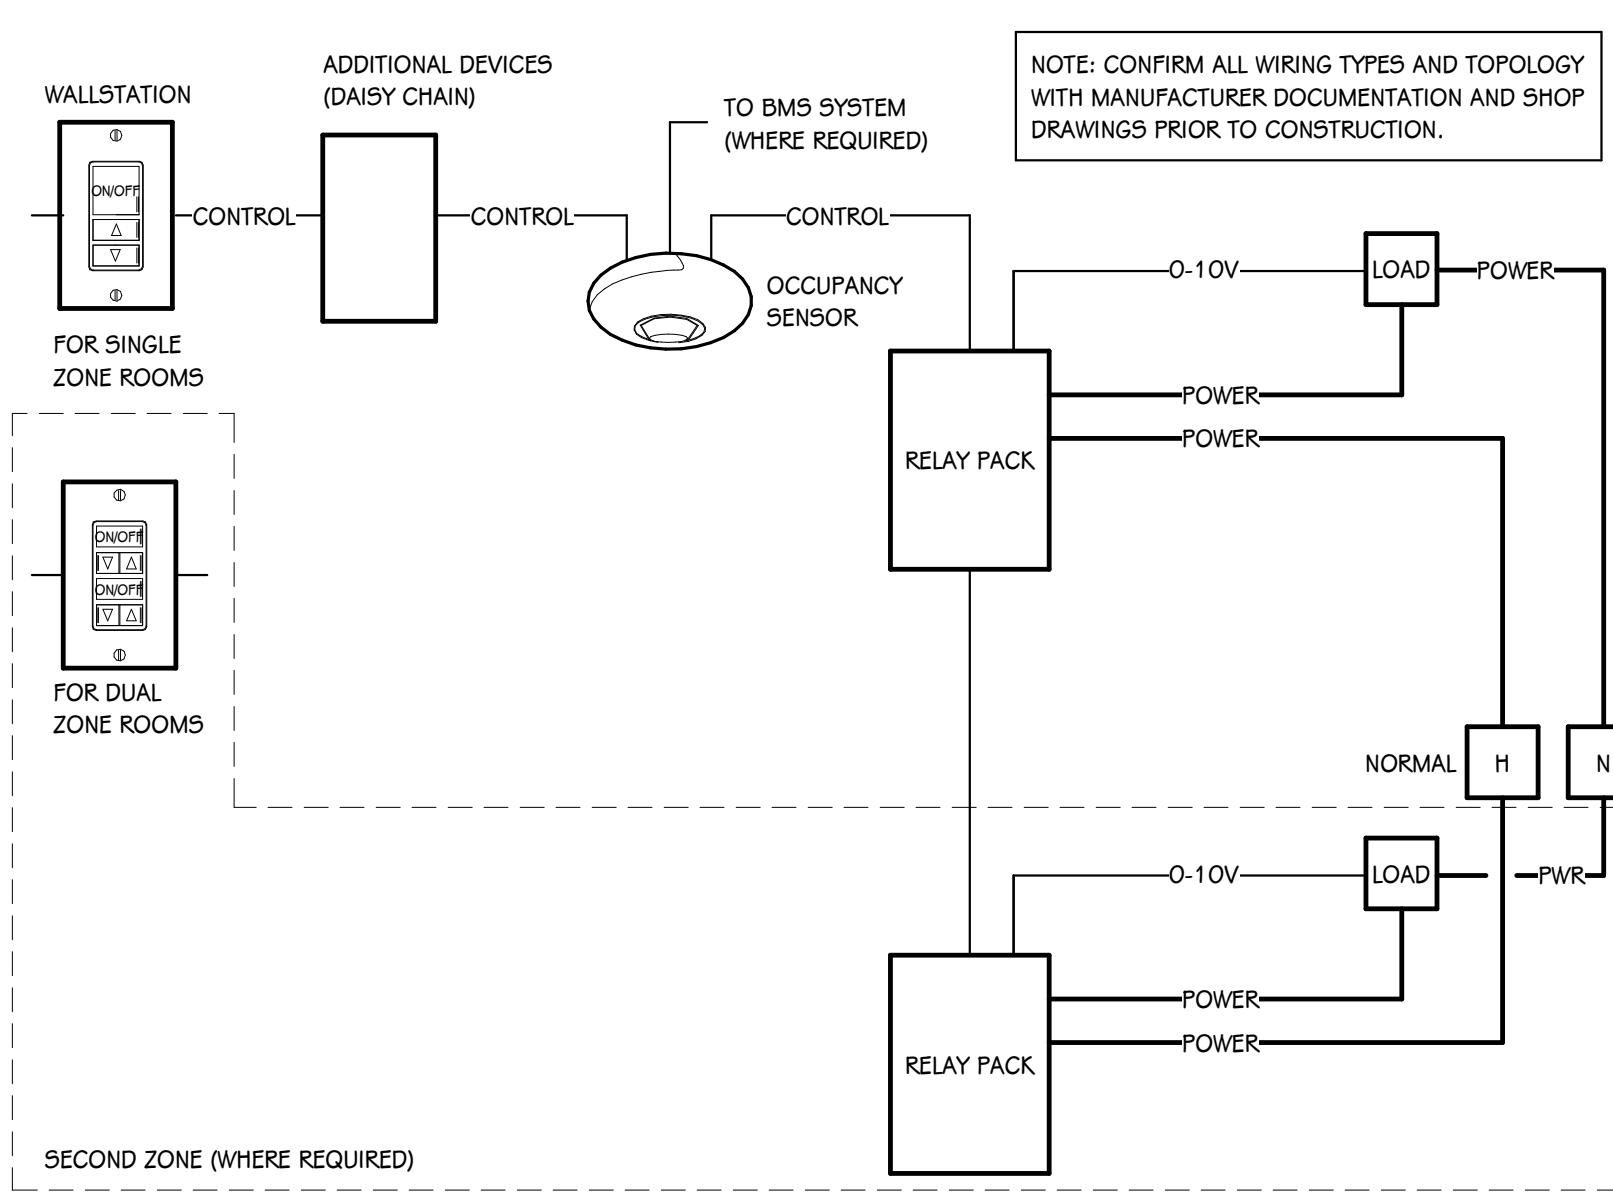

OCCUPANCY SENSOR WIRING DIAGRAM

OWNER
TEAMSTERS LOCAL 2727
Shenandoahville Kentucky

OWNER
TEAMSTERS LOCAL 2727
Shenandoahville Kentucky

SHEET TITLE
LIGHTING SCHEDULES AND DETAILS

STATE OF KENTUCKY
ERIC C. JONES
40466
LICENSED
PROFESSIONAL ENGINEER
1/9/2026

ISSUED FOR **DATE**

BUILDING

STATE OF KENTUCKY

ERIC C.

JONES

40466

LICENSED

PROFESSIONAL ENGINEER

1/9/2026

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